Urban Design and Landscape Plan

Ring Road Completion August 2024



Attachment 1: Architecture and Urban Design



Document Control - Revision History

Attachment 1: Architecture and Urban Design

Plan Control and Amendment

Rev. No.	Date	Description of Change	Prepared by
1	25/09/2023	Public Exhibition	AMA / M80-RRA
2	21/12/2023	UDLP Final Submission IEA	AMA / M80-RRA
3	29/01/2024	UDLP Final Submission for Review	AMA / M80-RRA
4	02/08/2024	UDLP Final Submission IEA	AMA / M80-RRA
5	21/08/2024	UDLP Final Submission	AMA / M80-RRA

DESIGN SUBJECT TO RELEVANT CODES AND STANDARDS

Nort	h East Link Program				
				NAME	DATE
			DRAFTING CHECKED BY	L.ANDERSON	29.04.2024
4	UDLP FINAL SUBMISSION		DESIGNED BY	M.SPYROPOULOS	29.04.2024
0	UDLP FINAL SUBMISSION FOR REVIEW	29.01.2024	ENGINEERING CHECKED BY	E.CASTILLO	29.04.2024
_		21.12.2023	VERIFIED BY	R.WOODS	29.04.2024
1	PUBLIC EXHIBITION	25.09.2023			
EV.	DESCRIPTION	DATE	APPROVED BY	Z.CVITKOVIC	29.04.2024
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NORTH EAST LINK PROGRAM

ATTACHMENT 1: ARCHITECTURE AND URBAN DESIGN DOCUMENT CONTROL

PROJECT CONTRACT: | NELP DRAWING No.: | SUIT. CODE | REVISION | NORTH | NEL-NTH-NNA-3900-EPU-DRG-ARC1 | 2

Overview

Pursuant to Clause **4.9.2(b)** of the Incorporated Document, Attachment 1 contains architecture and urban design plans, including sections and elevations, with materials and finishes associated with the Ring Road Completion.

The architecture and urban design plans accompany this UDLP to support and demonstrate the design's compliance with key elements of the Urban Design Strategy, including Objective 1.5: Architectural contribution and Objective 3.2: Integration of design.

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Nort	h East Link Program				
				NAME	DATE
			DRAFTING CHECKED BY	L.ANDERSON	02.08.202
4	UDLP FINAL SUBMISSION	02.08.2024	DESIGNED BY	M.SPYROPOULOS	02.08.2024
,		29.01.2024	ENGINEERING CHECKED BY	E.CASTILLO	02.08.2024
		21.12.2023	VERIFIED BY	R.WOODS	02.08.2024
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NORTH EAST LINK PROGRAM

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ATTACHMENT 1: ARCHITECTURE AND URBAN DESIGN DOCUMENT CONTROL

NELP DRAWING No.: SUIT. CODE REVISION NEL-NTH-NNA-3900-EPU-DRG-ARC2 2

Note: * Indicates signed documents as drawings will not have wet signatures.

Architecture and Urban Design Plan List

Attachment 1: Architecture and Urban Design Plan List

Drawing Number	Location
NEL-NTH-NNA-3900-EPU-DRG-1000	Cover Page
NEL-NTH-NNA-3900-EPU-DRG-1001	Drawing List and Legend
NEL-NTH-NNA-3900-EPU-DRG-1002	Site Plan and Context
NEL-NTH-NNA-3900-EPU-DRG-1003	Material Schedule
NEL-NTH-NNA-3900-EPU-DRG-1101	Locality Plan
NEL-NTH-NNA-3900-EPU-DRG-1102	General Arrangement Plans - Zone 1A - M80 Ring Road
NEL-NTH-NNA-3900-EPU-DRG-1103	General Arrangement Plans - Zone 1B - M80 Ring Road
NEL-NTH-NNA-3900-EPU-DRG-1104	General Arrangement Plans - Zone 1C - M80 Ring Road
NEL-NTH-NNA-3900-EPU-DRG-1105	General Arrangement Plans - Zone 1D - M80 Ring Road
NEL-NTH-NNA-3900-EPU-DRG-1106	General Arrangement Plans - Zone 2A -M80 Interchange
NEL-NTH-NNA-3900-EPU-DRG-1107	General Arrangement Plans - Zone 2B - M80 Interchange
NEL-NTH-NNA-3900-EPU-DRG-1108	General Arrangement Plans - Zone 3A - Greensborough
NEL-NTH-NNA-3900-EPU-DRG-1109	General Arrangement Plans - Zone 3B - Greensborough
NEL-NTH-NNA-3900-EPU-DRG-1110	General Arrangement Plans - Zone 4 - Watsonia Precinct
NEL-NTH-NNA-3900-EPU-DRG-1201	Locality Plan
NEL-NTH-NNA-3900-EPU-DRG-1202	Sections - Zone 1 - M80 Ring Road
NEL-NTH-NNA-3900-EPU-DRG-1203	Sections - Zone 2 - M80 Interchange
NEL-NTH-NNA-3900-EPU-DRG-1204	Sections - Zone 2 - M80 Interchange
NEL-NTH-NNA-3900-EPU-DRG-1205	Sections - Zone 3 - Greensborough Road
NEL-NTH-NNA-3900-EPU-DRG-1206	Sections - Zone 4 - Watsonia Precinct
NEL-NTH-NNA-3900-EPU-DRG-1207	Sections - Zone 4 - Watsonia Precinct
NEL-NTH-NNA-3900-EPU-DRG-1208	Sections - Zone 4 - Watsonia Precinct
NEL-NTH-NNA-3900-EPU-DRG-1209	Sections - Zone 2 - M80 Interchange

Drawing Number	Location
NEL-NTH-NNA-3900-EPU-DRG-1210	Sections - Zone 2 - M80 Interchange
NEL-NTH-NNA-3900-EPU-DRG-1211	Sections - Zone 2 - M80 Interchange
NEL-NTH-NNA-3900-EPU-DRG-1212	Sections - Zone 2 - M80 Interchange
NEL-NTH-NNA-3900-EPU-DRG-1213	Sections - Zone 2 - M80 Interchange
NEL-NTH-NNA-3900-EPU-DRG-1214	Sections - Zone 3 - Greensborough Road
NEL-NTH-NNA-3900-EPU-DRG-1215	Sections - Zone 3 - Greensborough Road
NEL-NTH-NNA-3900-EPU-DRG-1216	Sections - Zone 4 - Watsonia Precinct
NEL-NTH-NNA-3900-EPU-DRG-1251	Locality Plan
NEL-NTH-NNA-3900-EPU-DRG-1252	Elevations - Zone 2 - M80 Interchange
NEL-NTH-NNA-3900-EPU-DRG-1253	Elevations - Zone 2 - M80 Interchange
NEL-NTH-NNA-3900-EPU-DRG-1254	Elevations - Zone 2 - M80 Interchange
NEL-NTH-NNA-3900-EPU-DRG-1255	Elevations -Zone3 - Greensborough Road
NEL-NTH-NNA-3900-EPU-DRG-1256	Elevations -Zone3 - Greensborough Road
NEL-NTH-NNA-3900-EPU-DRG-1257	Elevations -Zone3 - Greensborough Road
NEL-NTH-NNA-3900-EPU-DRG-1258	Elevations -Zone3 - Greensborough Road
NEL-NTH-NNA-3900-EPU-DRG-1301	Locality Plan
NEL-NTH-NNA-3900-EPU-DRG-1302	General Arrangement Plan - M80 Incident Response Bay
NEL-NTH-NNA-3900-EPU-DRG-1401	Locality Plan
NEL-NTH-NNA-3900-EPU-DRG-1402	General Arrangement Plans - Macorna Street Shared Use Path Bridge
NEL-NTH-NNA-3900-EPU-DRG-1403	Sections - Macorna Street Shared Use Path Bridge
NEL-NTH-NNA-3900-EPU-DRG-1404	Elevations - Macorna Street Shared Use Path Bridge
NEL-NTH-NNA-3900-EPU-DRG-1405	Section - Macorna Street North Shared Use Path
NEL-NTH-NNA-3900-EPU-DRG-1406	Elevations - Macorna Street North Shared Use Path Bridge

DESIGN SUBJECT TO RELEVANT CODES AND STANDARDS

NAME DATE L.ANDERSON 02.08.2024 M.SPYROPOULOS 02.08.2024 DESIGNED BY UDLP FINAL SUBMISSION FOR REVIEW E.CASTILLO 02.08.2024 2 UDLP FINAL SUBMISSION IEA 21.12.2023 ERIFIED BY R.WOODS 02.08.2024 Z.CVITKOVIC 02.08.2024 DESCRIPTION DATE APPROVALS

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NORTH EAST LINK PROGRAM ATTACHMENT 1:

ATTACHMENT 1: ARCHITECTURE AND URBAN DESIGN PLAN LIST 1

PROJECT CONTRACT: NELP DRAWING No.: SUIT. CODE REVISION NORTH NEL-NTH-NNA-3900-EPU-DRG-ARC3 2

Architecture and Urban Design Plan List

Attachment 1: Architecture and Urban Design Plan List

Drawing Number	Location
NEL-NTH-NNA-3900-EPU-DRG-1407	Sections - Macorna Street South Shared Use Path Undercroft
NEL-NTH-NNA-3900-EPU-DRG-1408	Sections - Macorna Street South Shared Use Path Undercroft
NEL-NTH-NNA-3900-EPU-DRG-1409	Elevation - Macorna Street South Shared Use Path Undercroft
NEL-NTH-NNA-3900-EPU-DRG-1410	General Arrangement Plans - M80 Interchange Sheet 1
NEL-NTH-NNA-3900-EPU-DRG-1411	General Arrangement Plans - M80 Interchange Sheet 2
NEL-NTH-NNA-3900-EPU-DRG-1412	Section - M80 Interchange
NEL-NTH-NNA-3900-EPU-DRG-1413	Elevation - M80 Interchange
NEL-NTH-NNA-3900-EPU-DRG-1414	General Arrangement Plan - Yando Street Underpass
NEL-NTH-NNA-3900-EPU-DRG-1416	Section - Yando Street Underpass
NEL-NTH-NNA-3900-EPU-DRG-1415	Elevation - Yando Street Underpass
NEL-NTH-NNA-3900-EPU-DRG-1501	Locality Plan
NEL-NTH-NNA-3900-EPU-DRG-1502	General Arrangement Plans - Kempston Street Underpass
NEL-NTH-NNA-3900-EPU-DRG-1503	Section - Kempston Street Underpass
NEL-NTH-NNA-3900-EPU-DRG-1504	Elevation - Kempston Street Underpass
NEL-NTH-NNA-3900-EPU-DRG-1505	General Arrangement Plan - Grimshaw Street Interchange
NEL-NTH-NNA-3900-EPU-DRG-1506	General Arrangement Plan - Grimshaw Street East Underpass
NEL-NTH-NNA-3900-EPU-DRG-1507	Section - Grimshaw Street East Underpass
NEL-NTH-NNA-3900-EPU-DRG-1508	Elevations - Grimshaw Street East Underpass
NEL-NTH-NNA-3900-EPU-DRG-1509	General Arrangement Plan - Grimshaw Street West Underpass
NEL-NTH-NNA-3900-EPU-DRG-1510	Section - Grimshaw Street West Underpass
NEL-NTH-NNA-3900-EPU-DRG-1511	Elevations - Grimshaw Street West Underpass
NEL-NTH-NNA-3900-EPU-DRG-1512	General Arrangement Plan - Greensborough Incident Response Bay
NEL-NTH-NNA-3900-EPU-DRG-1513	General Arrangement Plan - Nell Street Shared Use Path Bridge

NEL-NTH-NNA-3900-EPU-DRG-1514	
NEE NITT NIVA 0000 ET 0 DIKG 1014	Sections - Nell Street Shared Use Path Bridge
NEL-NTH-NNA-3900-EPU-DRG-1515	Elevation - Nell Street Shared Use Path Bridge
NEL-NTH-NNA-3900-EPU-DRG-1516	Section - Nell Street East Shared Use Path Undercroft
NEL-NTH-NNA-3900-EPU-DRG-1517	Elevations - Nell Street East Shared Use Path Undercroft
NEL-NTH-NNA-3900-EPU-DRG-1518	Sections - Nell Street West Shared Use Path Undercroft
NEL-NTH-NNA-3900-EPU-DRG-1519	Elevations - Nell Street West Shared Use Path Undercroft
NEL-NTH-NNA-3900-EPU-DRG-1601	Locality Plan
NEL-NTH-NNA-3900-EPU-DRG-1602	General Arrangement and Elevations - Greensborough Road Rail Tunnel
NEL-NTH-NNA-3900-EPU-DRG-1603	General Arrangement Plan - Hurstbridge Rail Tunnel Services
NEL-NTH-NNA-3900-EPU-DRG-1604	General Arrangement Plan - Elder Street Land Bridge
NEL-NTH-NNA-3900-EPU-DRG-1605	Elevation and Section - Elder Street Land Bridge
NEL-NTH-NNA-3900-EPU-DRG-1606	General Arrangement Plan - Rasheda Street
NEL-NTH-NNA-3900-EPU-DRG-1607	Elevations - Rasheda Street
NEL-NTH-NNA-3900-EPU-DRG-1608	General Arrangement Plan - Watsonia Road Land Bridge
NEL-NTH-NNA-3900-EPU-DRG-1609	Elevation - Watsonia Road Land Bridge
NEL-NTH-NNA-3900-EPU-DRG-1610	Elevation - Watsonia Road Land Bridge
NEL-NTH-NNA-3900-EPU-DRG-1611	Rail Lubricator Plan And Section
NEL-NTH-NNA-3900-EPU-DRG-1701	Locality Plan
NEL-NTH-NNA-3900-EPU-DRG-1702	Road Infrastructure Plans - Zone 1A
NEL-NTH-NNA-3900-EPU-DRG-1703	Road Infrastructure Plans - Zone 1B
NEL-NTH-NNA-3900-EPU-DRG-1704	Road Infrastructure Plans - Zone 1C
NEL-NTH-NNA-3900-EPU-DRG-1705	Road Infrastructure Plans - Zone 1D
NEL-NTH-NNA-3900-EPU-DRG-1706	Road Infrastructure Plans - Zone 2A

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NAME DATE L.ANDERSON 02.08.2024 M.SPYROPOULOS 02 08 2024 DESIGNED BY UDLP FINAL SUBMISSION FOR REVIEW E.CASTILLO 02.08.2024 2 UDLP FINAL SUBMISSION IEA 21.12.2023 ERIFIED BY R.WOODS 02.08.2024 Z.CVITKOVIC 02.08.2024 DESCRIPTION DATE APPROVALS

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ATTACHMENT 1: ARCHITECTURE AND URBAN DESIGN PLAN LIST 2

PROJECT CONTRACT: NELP DRAWING No.: NORTH NEL-NTH-NNA-3900-EPU-DRG-ARC4

SUIT. CODE REVISION

Architecture and Urban Design Plan List

Attachment 1: Architecture and Urban Design Plan List

Drawing Number	Location
NEL-NTH-NNA-3900-EPU-DRG-1707	Road Infrastructure Plans - Zone 2B
NEL-NTH-NNA-3900-EPU-DRG-1708	Road Infrastructure Plans - Zone 3A
NEL-NTH-NNA-3900-EPU-DRG-1709	Road Infrastructure Plans - Zone 3B
NEL-NTH-NNA-3900-EPU-DRG-1710	Road Infrastructure Plans - Zone 4
NEL-NTH-NNA-3900-EPU-DRG-1711	Noise Wall Types - Sheet 01
NEL-NTH-NNA-3900-EPU-DRG-1712	Noise Walls Types - Sheet 02
NEL-NTH-NNA-3900-EPU-DRG-1713	Noise Wall Elevations - Sheet 01
NEL-NTH-NNA-3900-EPU-DRG-1721	Retaining Wall Types - Sheet 01
NEL-NTH-NNA-3900-EPU-DRG-1722	Retaining Wall Types - Sheet 02
NEL-NTH-NNA-3900-EPU-DRG-1731	Flood Wal Types - Sheet 01
NEL-NTH-NNA-3900-EPU-DRG-1741	Screen Types - Sheet 01
NEL-NTH-NNA-3900-EPU-DRG-1751	Bridge Barrier Types - Sheet 01
NEL-NTH-NNA-3900-EPU-DRG-1752	Bridge Barrier Types - Sheet 02
NEL-NTH-NNA-3900-EPU-DRG-1753	Bridge Barrier Types - Sheet 03
NEL-NTH-NNA-3900-EPU-DRG-1761	Gantry Types - Sheet 01
NEL-NTH-NNA-3900-EPU-DRG-1762	Gantry Types - Sheet 02
NEL-NTH-NNA-3900-EPU-DRG-1771	Pier Types - Sheet 01
NEL-NTH-NNA-3900-EPU-DRG-1781	Fence Types - Types 01
NEL-NTH-NNA-3900-EPU-DRG-1791	Material Precedents

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NORTH EAST LINK PROGRAM

ATTACHMENT 1: ARCHITECTURE AND URBAN DESIGN PLAN LIST 3

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DESIGN SUBJECT TO RELEVANT CODES AND STANDAR

NORTH EAST LINK PROGRAM NELP DISCLAIMER RING ROAD COMPLETION ATTACHMENT 1: ARCHITECTURE AND URBAN DESIGN

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PROJECT CONTRACT NORTH

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ATTACHMENT 1: ARCHITECTURE AND URBAN DESIGN


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MATERIAL SCHEDULE

ACRYLIC FINISHES

A-01

OL-01

TRANSPARENT TINTED ACRYLIC PANEL

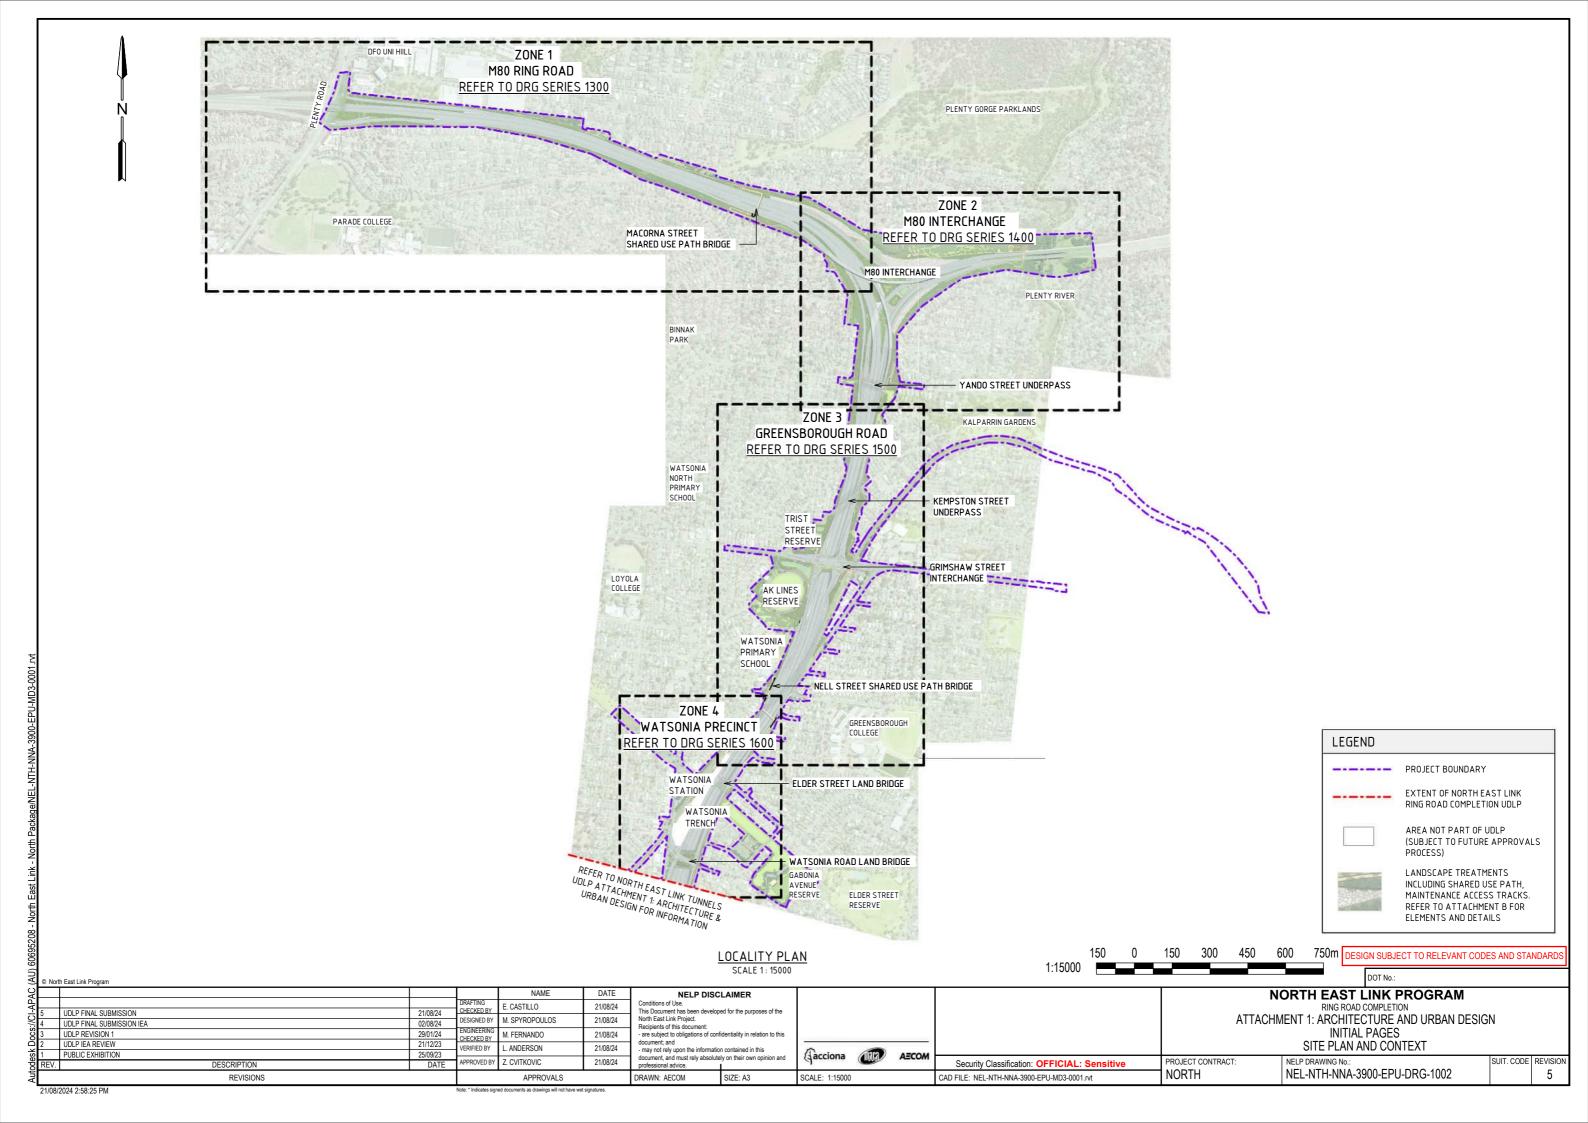TRANSPARENT TINTED ACRYLIC PANEL WITH ETCHED FINISH AND GRADUAL OPACITY DECREASE TOWARDS THE TOP OF THE PANEL. IN CUSTOM COLOURS. INTEGRATED POLYAMIDE THREADS FOR SHATTER AND BIRD STRIKE PROTECTION.



TRANSLUCENT TINTED ACRYLIC OR PERFORATED STEEL PANEL

TRANSLUCENT TINTED ACRYLIC PANEL. INTEGRATED POLYIMIDE OR PERFORATED STAINLESS STEEL PANEL TO CUSTOM MANUFACTURED SHAPES. MATERIAL AND EXTENT OF APPLICATION ARE TO BE FINALISED IN DESIGN DEVELOPMENT PHASE IN CONSULTATION WITH DIRECTLY IMPACTED PROPERTIES.



METAL FINISHES



M-03

M-04

SOLID ALUMINIUM PANEL

SOLID ALUMINIUM PANEL TO CUSTOM ARCHITECTURAL PROFILE WITH SATIN PVDF FINISH, IN CUSTOM COLOURS. FULL HEIGHT CLEAR NON SACRIFICIAL, NON-FILM FORMING COATING. NOTE- TO MATCH TUNNELS UDLP



WEATHERING STEEL

WEATHERING STEEL



PERFORATED WEATHERING STEEL

CUSTOM PATTERN PERFORATED WEATHERING



M-05

PERFORATED ALUMINIUM PANELS

PERFORATED ALUMINIUM PANEL TO CUSTOM ARCHITECTURAL PROFILE WITH SATIN PVDF FINISH. IN CUSTOM COLOURS, FULL HEIGHT CLEAR NON SACRIFICIAL, NON-FILM FORMING COATING.

MESH FINISHES



WIRE MESH PROTECTION SCREEN

WIRE MESH PROTECTION SCREEN TO CUSTOM MANUFACTURED SHAPES. STAINLESS STEEL



WIRE MESH PROTECTION SCREEN WITH PVDF FINISH IN CUSTOM COLOURS

WIRE MESH PROTECTION SCREEN TO CUSTOM MANUFACTURED SHAPES. PVDF FINISH IN CUSTOM COLOURS.



PAINT FINISHES



P-02


PAINT OVER STEEL - TYPE 01

PAINT OVER STEEL WITH PROTECTIVE COATING. SATIN FINISH WITH INTEGRAL PROPERTIES TO



PAINT OVER STEEL - TYPE 02

PAINT OVER STEEL WITH PROTECTIVE COATING. SATIN FINISH WITH INTEGRAL PROPERTIES TO TOP COAT.

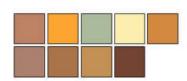

PAINT OVER CONCRETE - TYPE 01 P-03

PAINT OVER CONCRETE WITH PROTECTIVE COATING. SATIN FINISH WITH INTEGRAL ANTI-GRAFFITI PROPERTIES TO ANTI-CARBONATION TOP COAT ALL COATINGS SHALL MEET THE REQUIREMENT OF VICROADS SPECIFICATION SECTION 685. FINAL DESIGN SUBJECT TO WURUNDJERI CODESIGN INPUT



CONCRETE FINISHES



CONCRETE WITH INTEGRAL FINISH

CONCRETE WITH INTEGRAL ARCHITECTURAL REVEAL. FROM CUSTOM TYPE RESIN/RUBBER FABRICATED FORM LINE.

PRECAST CONCRETE TEXTURED PANEL WITH

INTEGRAL ARCHITECTURAL REVEAL. FROM

CUSTOM TYPE RESIN/RUBBER FABRICATED



C-03

SHOTCRETE

SHOTCRETE FINISH.

PRECAST CONCRETE (TRENCH)

FORM LINE WITH OXIDE COLOUR.


NOTE - TO MATCH TUNNELS UPLE

DECKING FINISHES



GLASS FIBRE REINFORCED POLYMER

GLASS FIBRE REINFORCED POLYMER DECK WITH APPROVED COLOUR AND TEXTURE WEARING SURFACE.

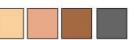

LIGHTING



LIGHTING WITH TUNABLE RGBW COLOURS. FIXED COLOUR TEMPERATURE

HANDRAIL FINISHES



STAINLESS STEEL HANDRAIL

CONTINUOUS HANDRAIL. 316 STAINLESS STEEL FINISH, 50mm DIAMETER.

ROCK BATTER



NATURAL ROCK BATTER

NATURAL ROCK BATTER



ROCK BEACHING

ROCK BEACHING TREATMENT

- THE ALIGNMENT AND LOCATION OF BARRIERS, FENCES. SCREENS AND WALLS ARE INDICATIVE AND ARE SUBJECT TO DESIGN DEVELOPMENT.
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DESIGN SUBJECT TO RELEVANT CODES AND STANDARD

SUIT. CODE REVISION

5

NORTH EAST LINK PROGRAM

RING ROAD COMPLETION ATTACHMENT 1: ARCHITECTURE AND URBAN DESIGN

INITIAL PAGES

MATERIAL SCHEDULE

NELP DRAWING No.

PROJECT CONTRACT

NORTH

NEL-NTH-NNA-3900-EPU-DRG-1003

North East Link Program

LIDI P FINAL SUBMISSION UDLP FINAL SUBMISSION IEA UDLP REVISION 1

UDLP IEA REVIEW PUBLIC EXHIBITION

DESCRIPTION

REVISIONS

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APPROVALS

NAME

. CASTILLO

M SPYROPOULOS

I. FERNANDO

. ANDERSON

7 CVITKOVIC

CHECKED BY

DESIGNED BY

CHECKED BY

ERIFIED BY

PPROVED BY

21/08/24

02/08/24

29/01/24

DATE

DATE

21/08/24

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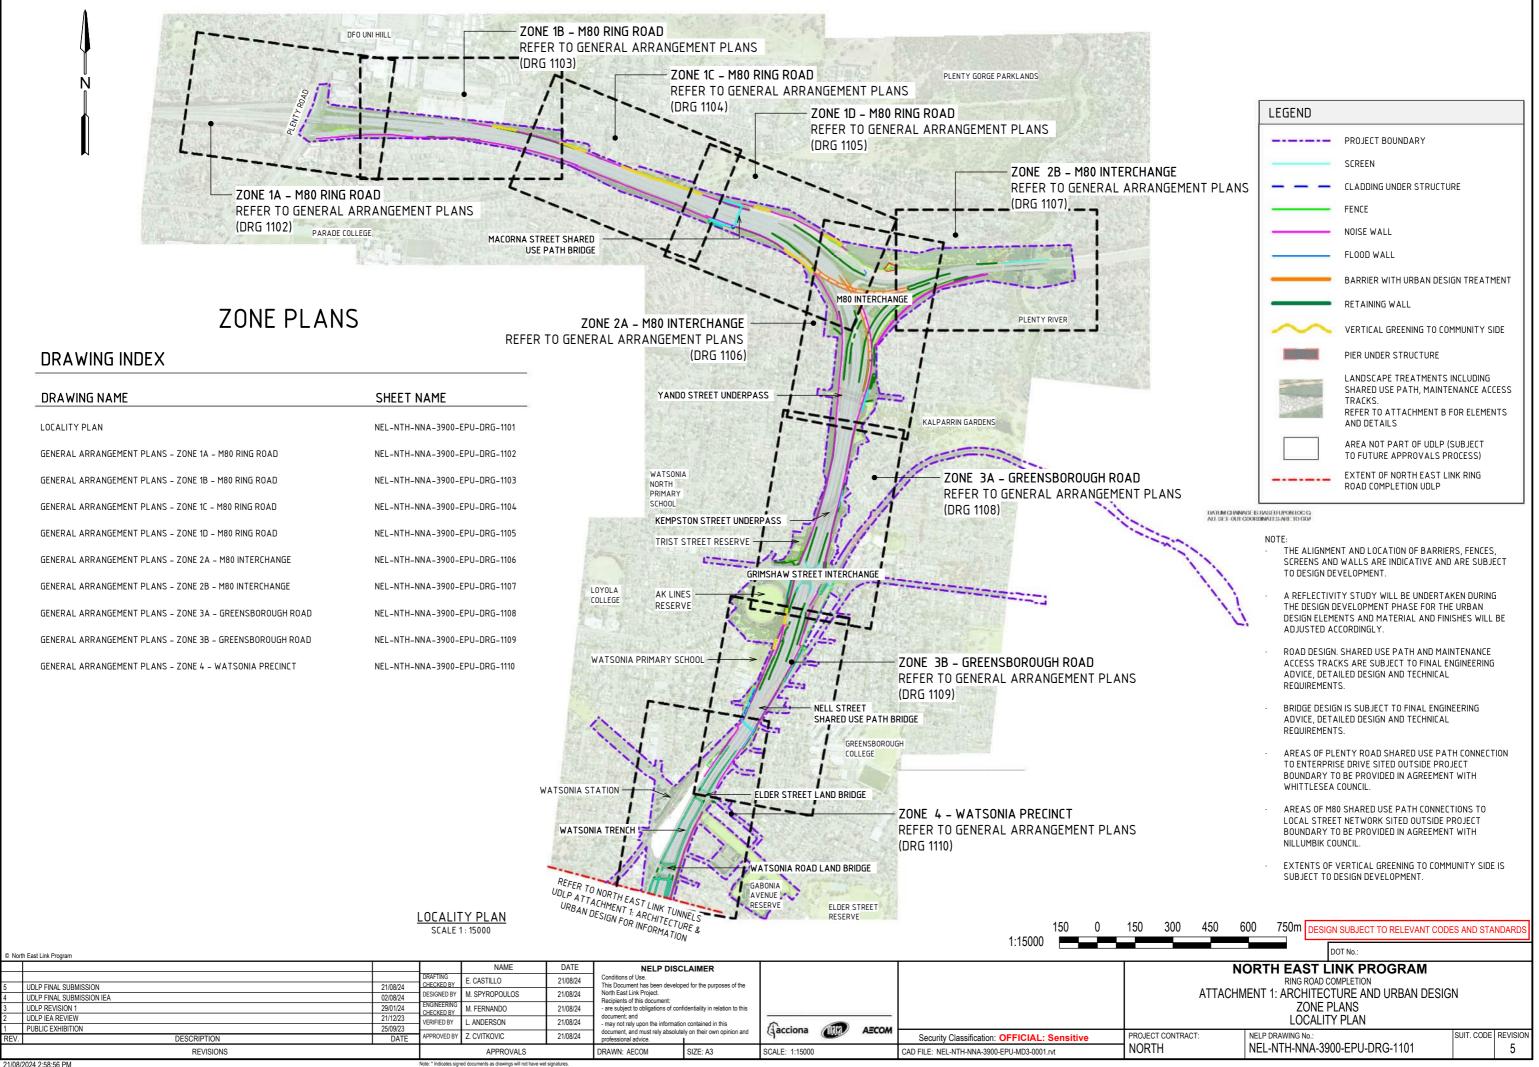
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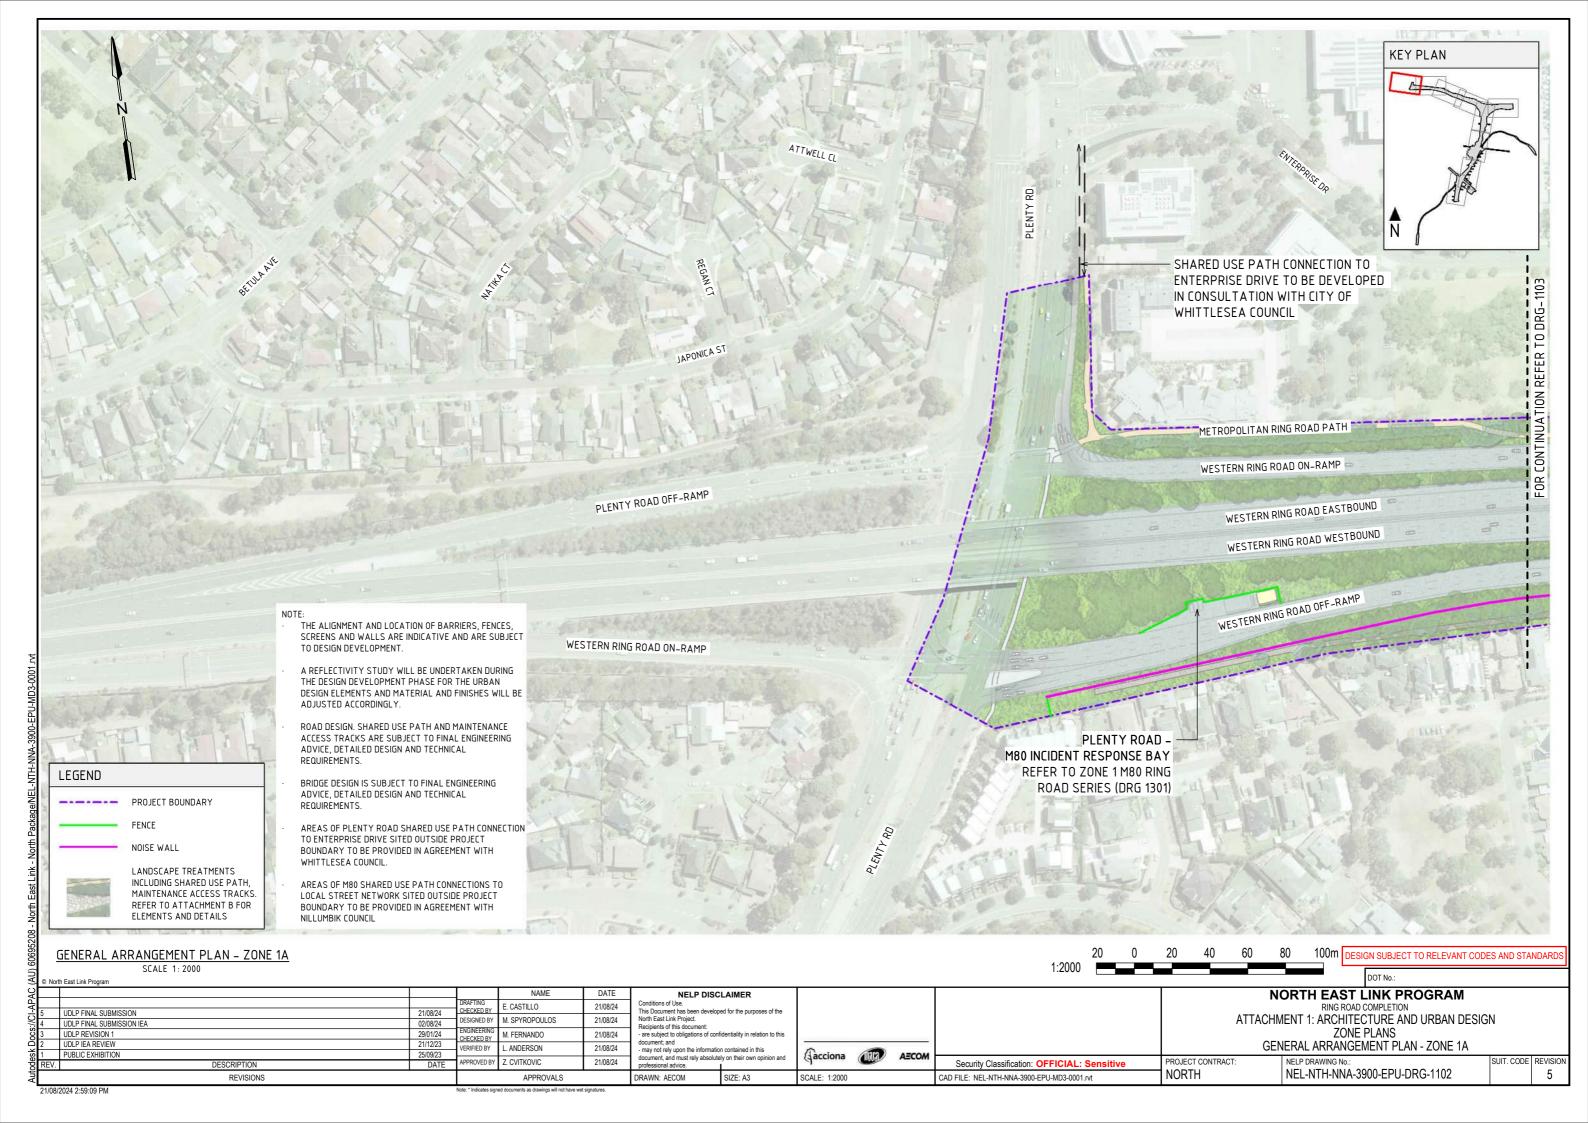
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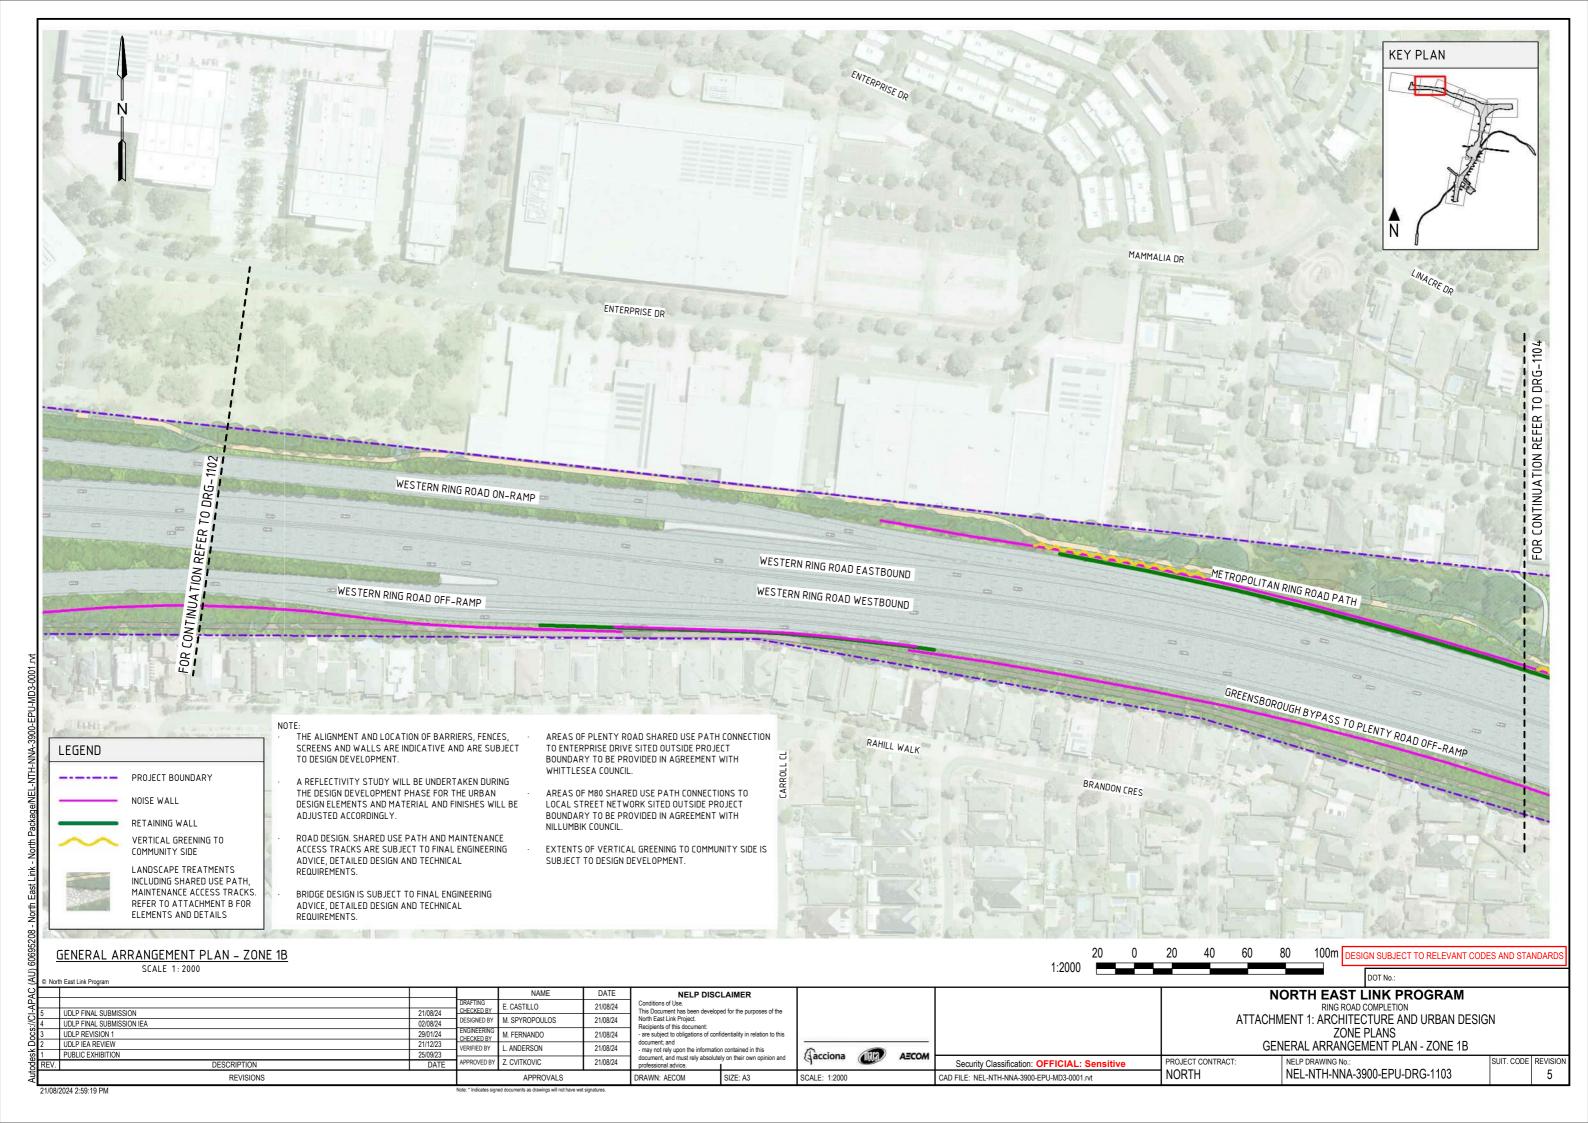
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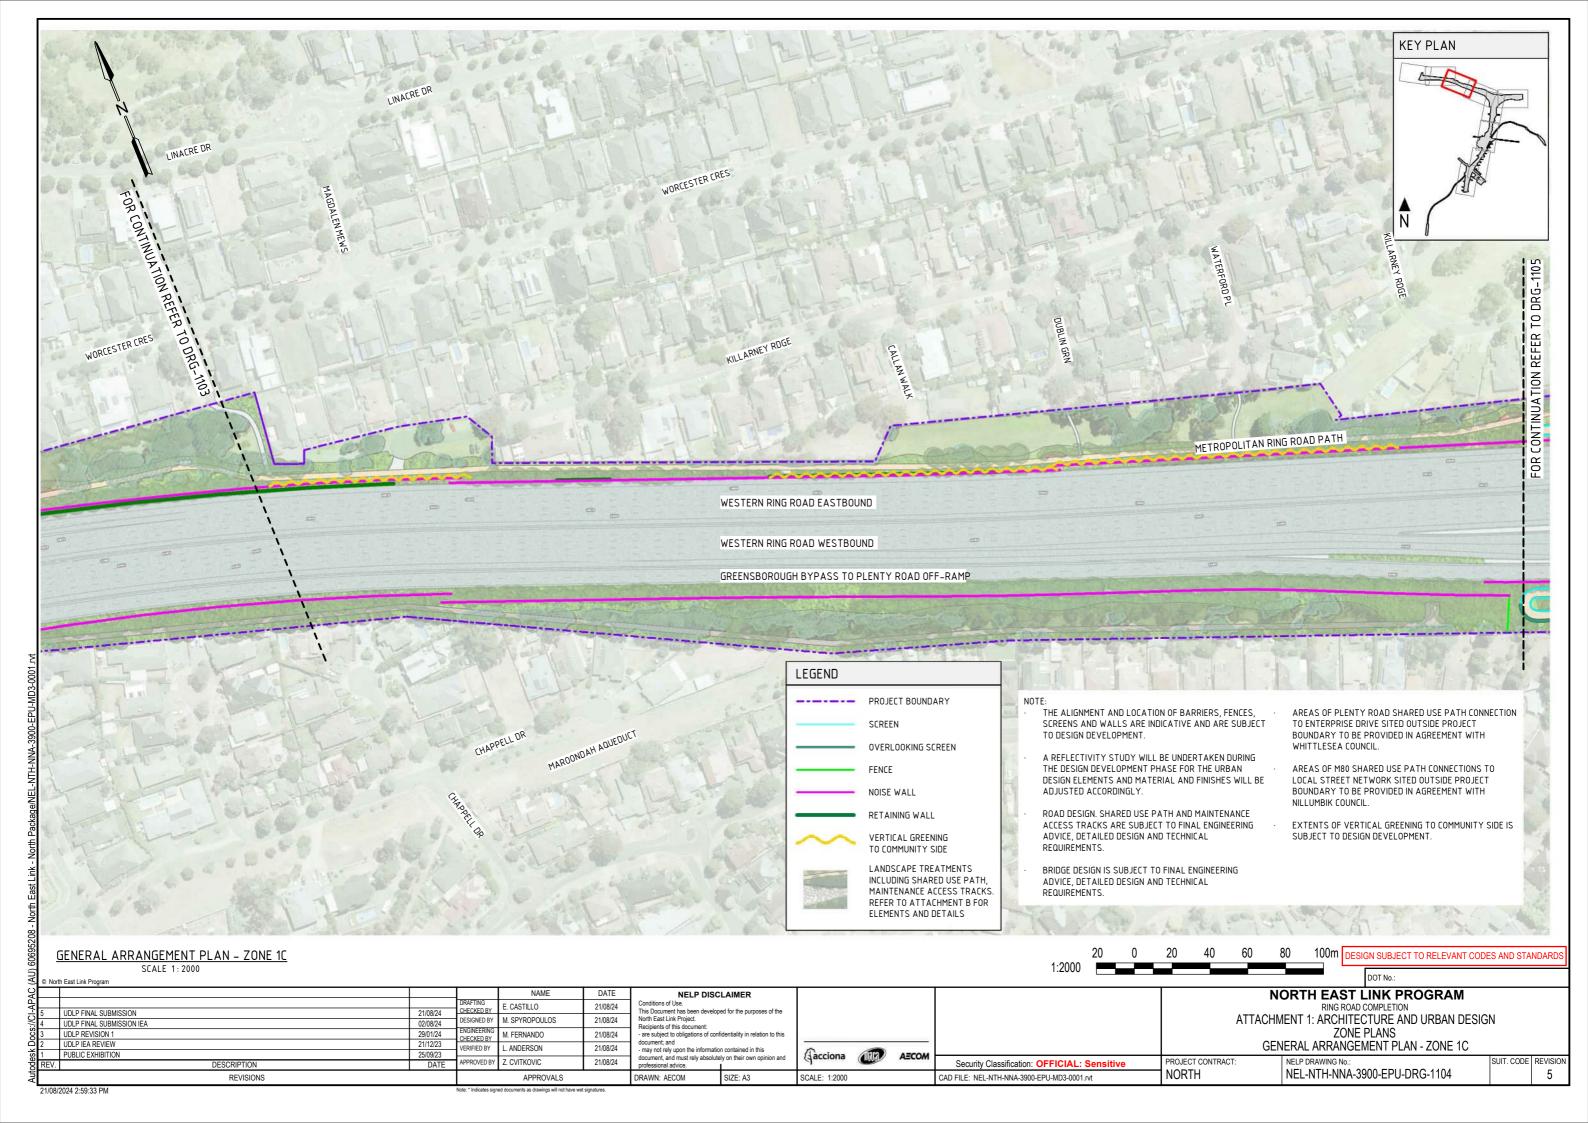
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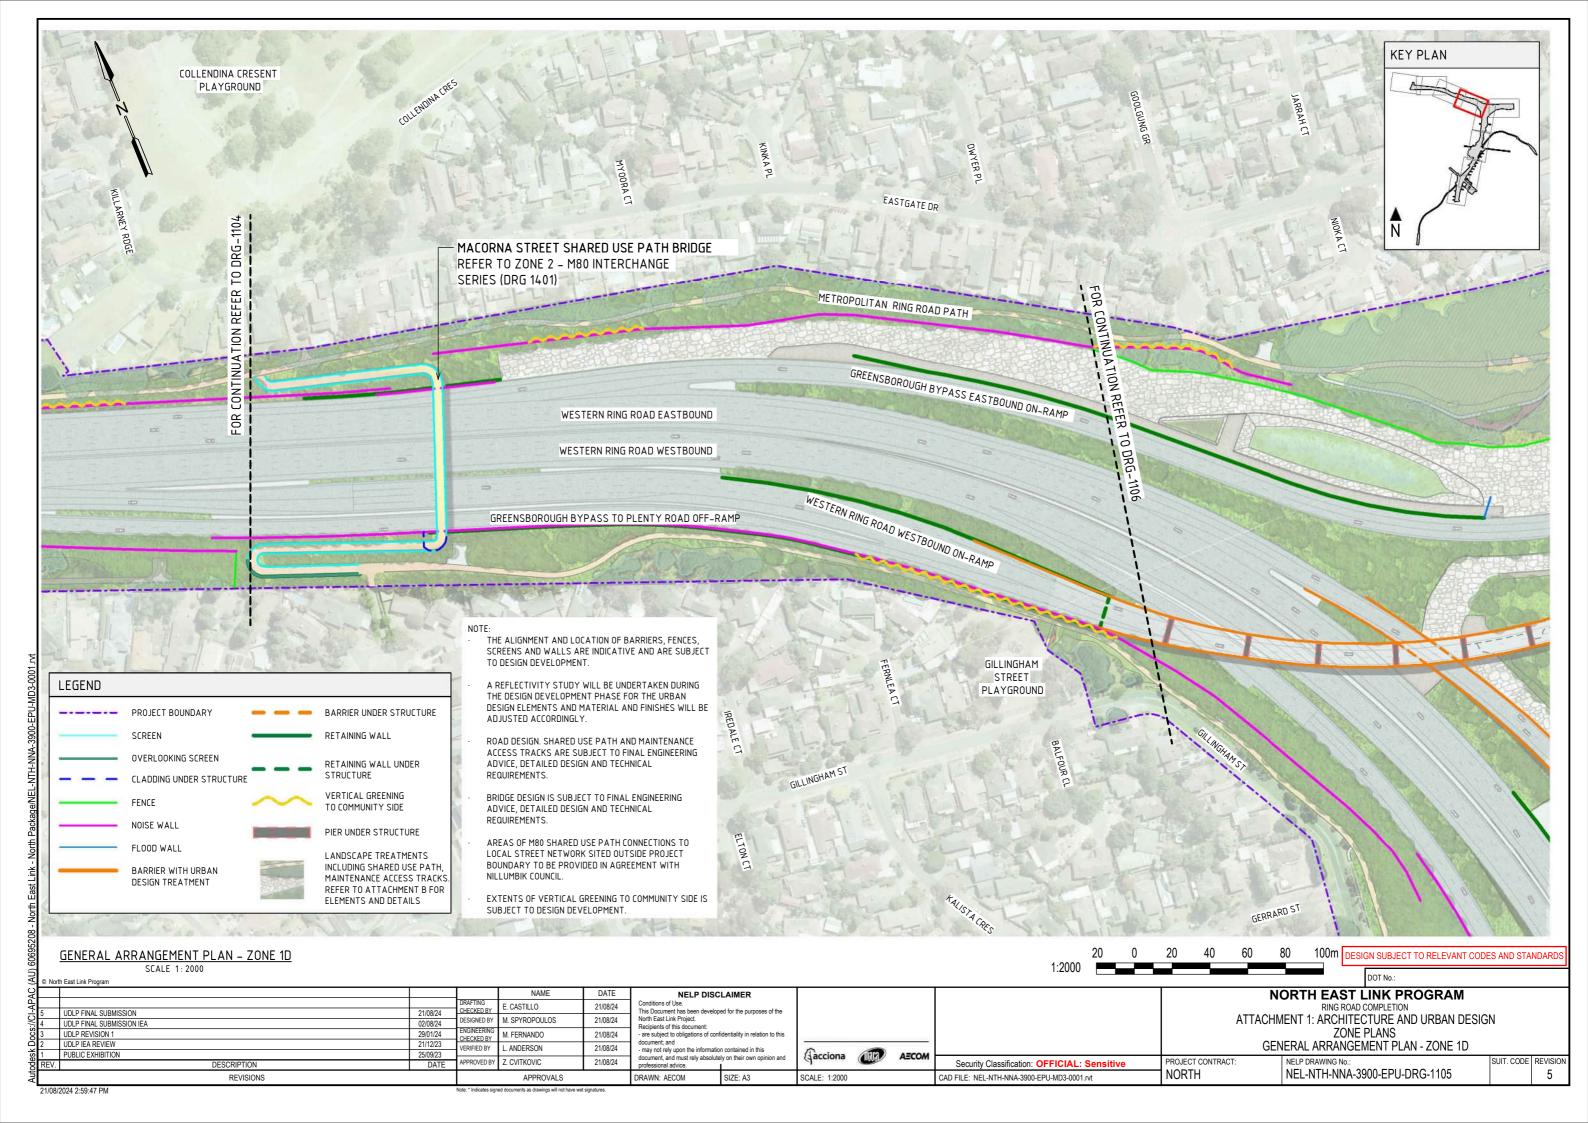
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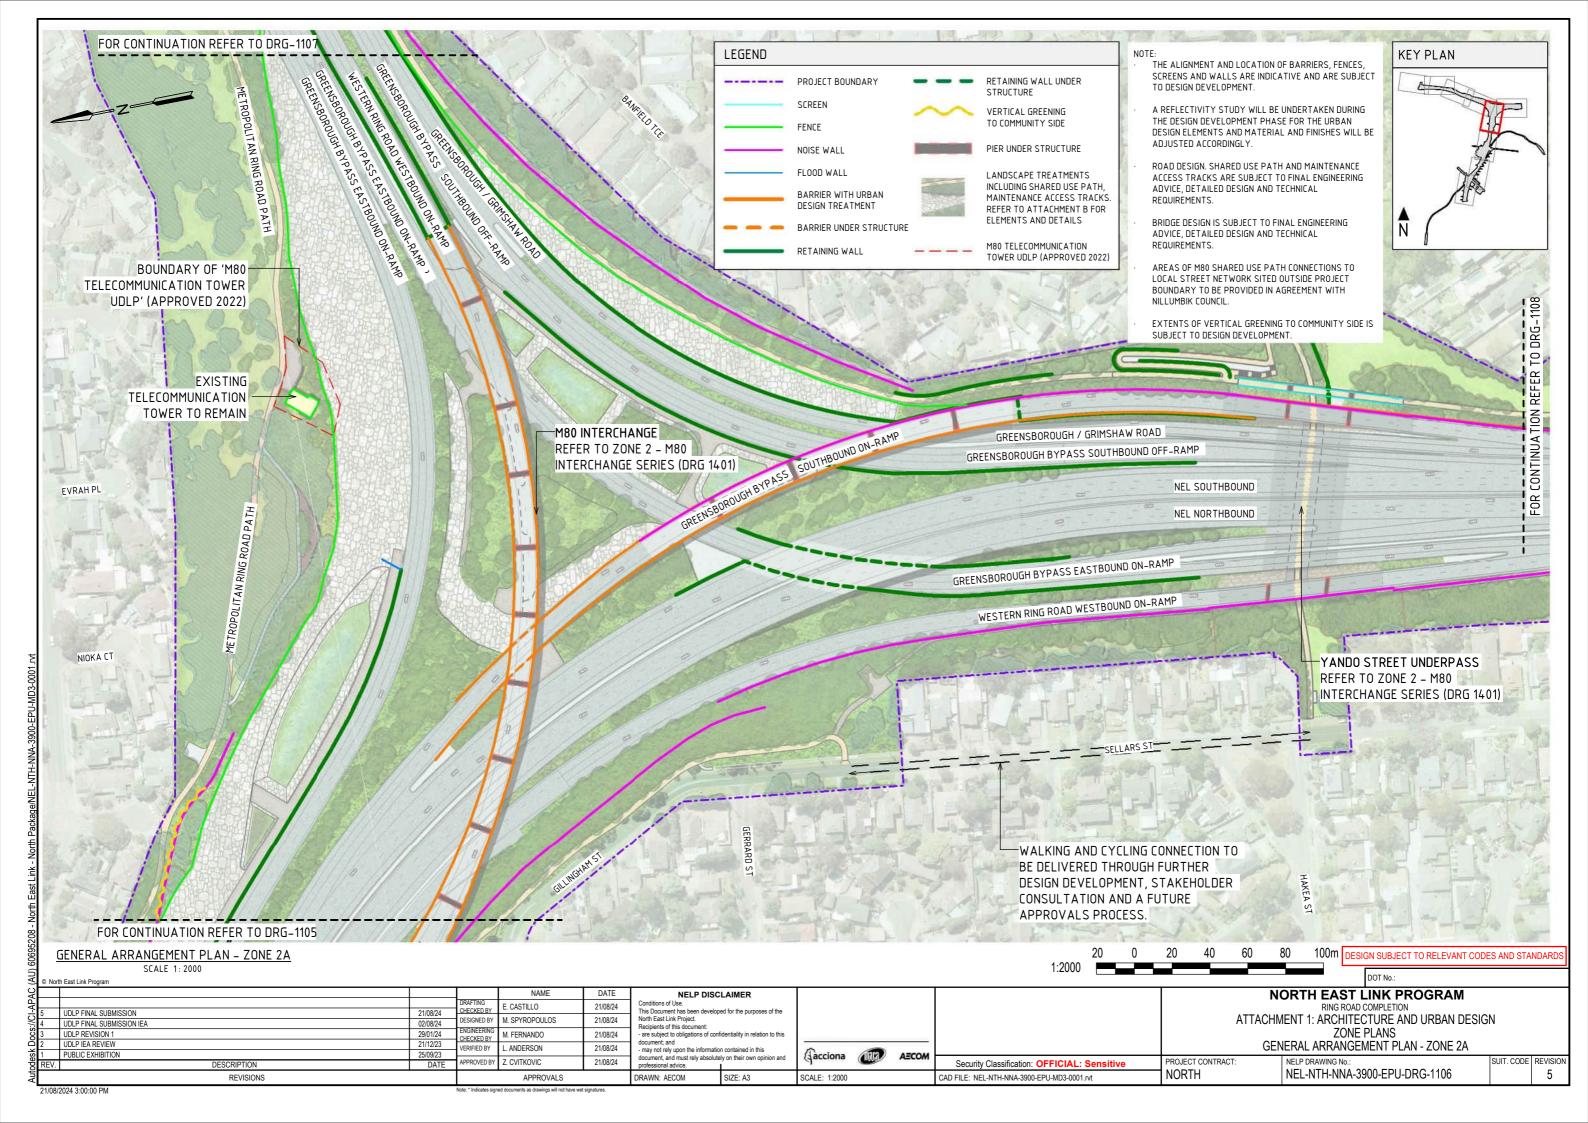
















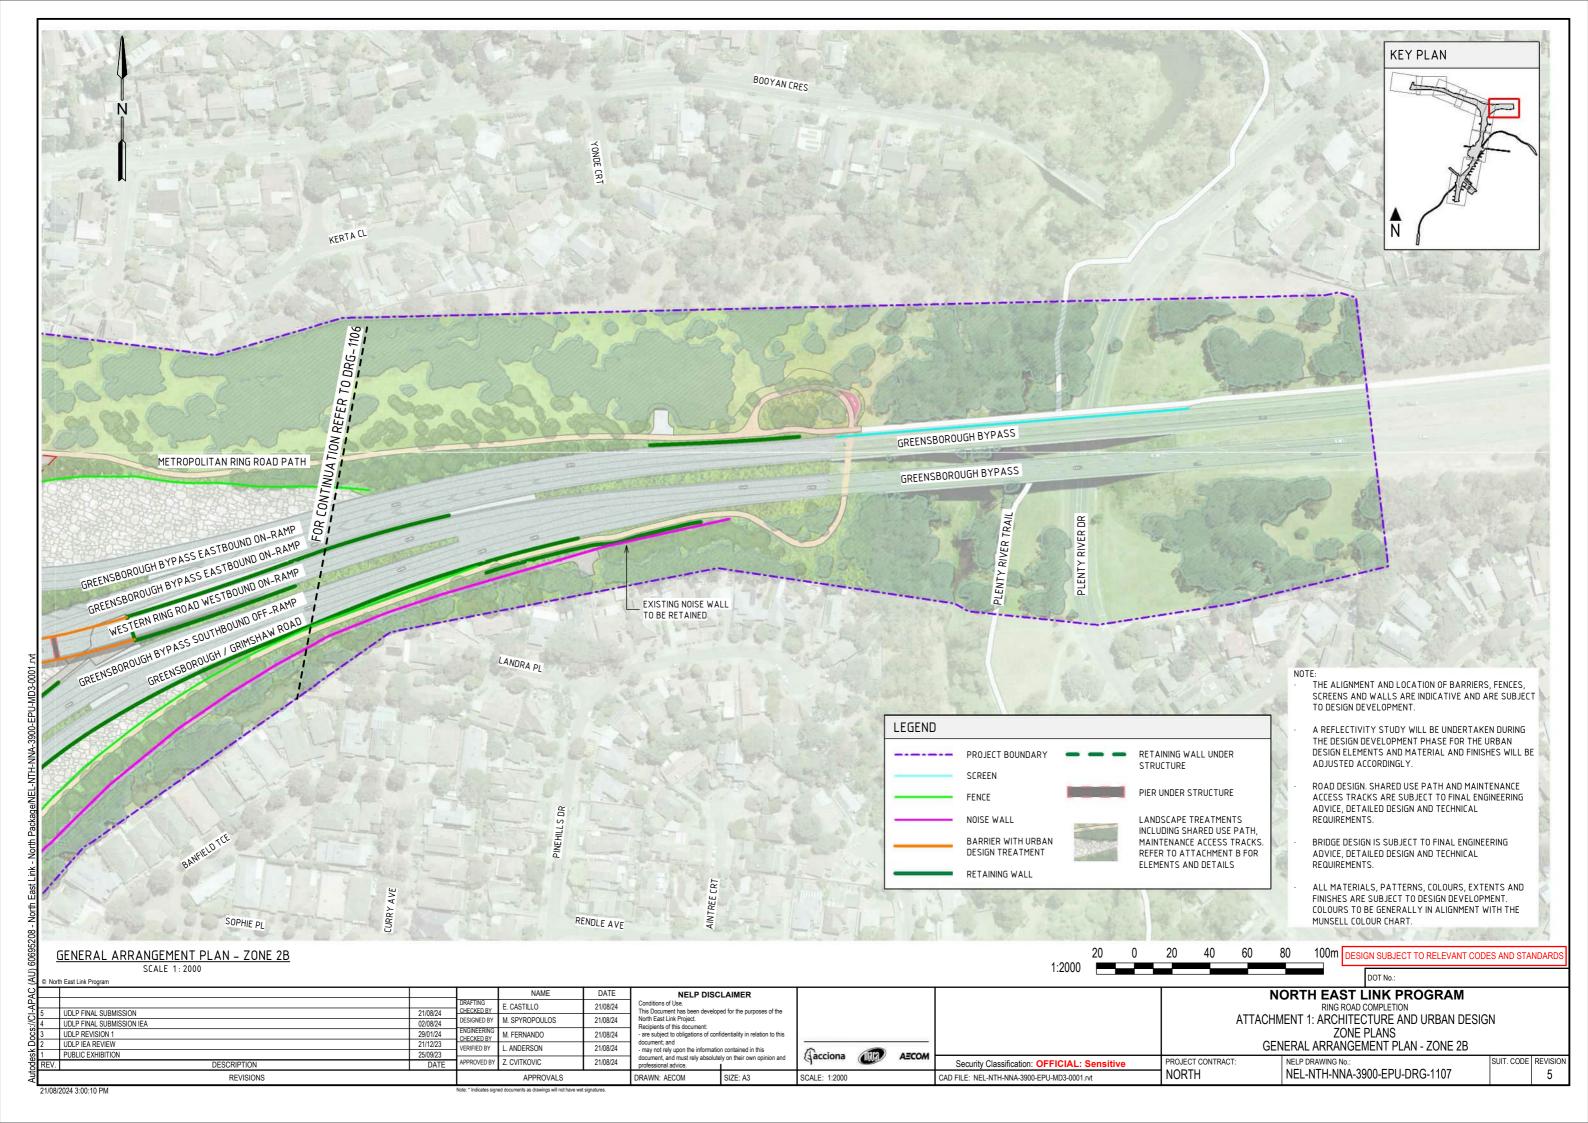


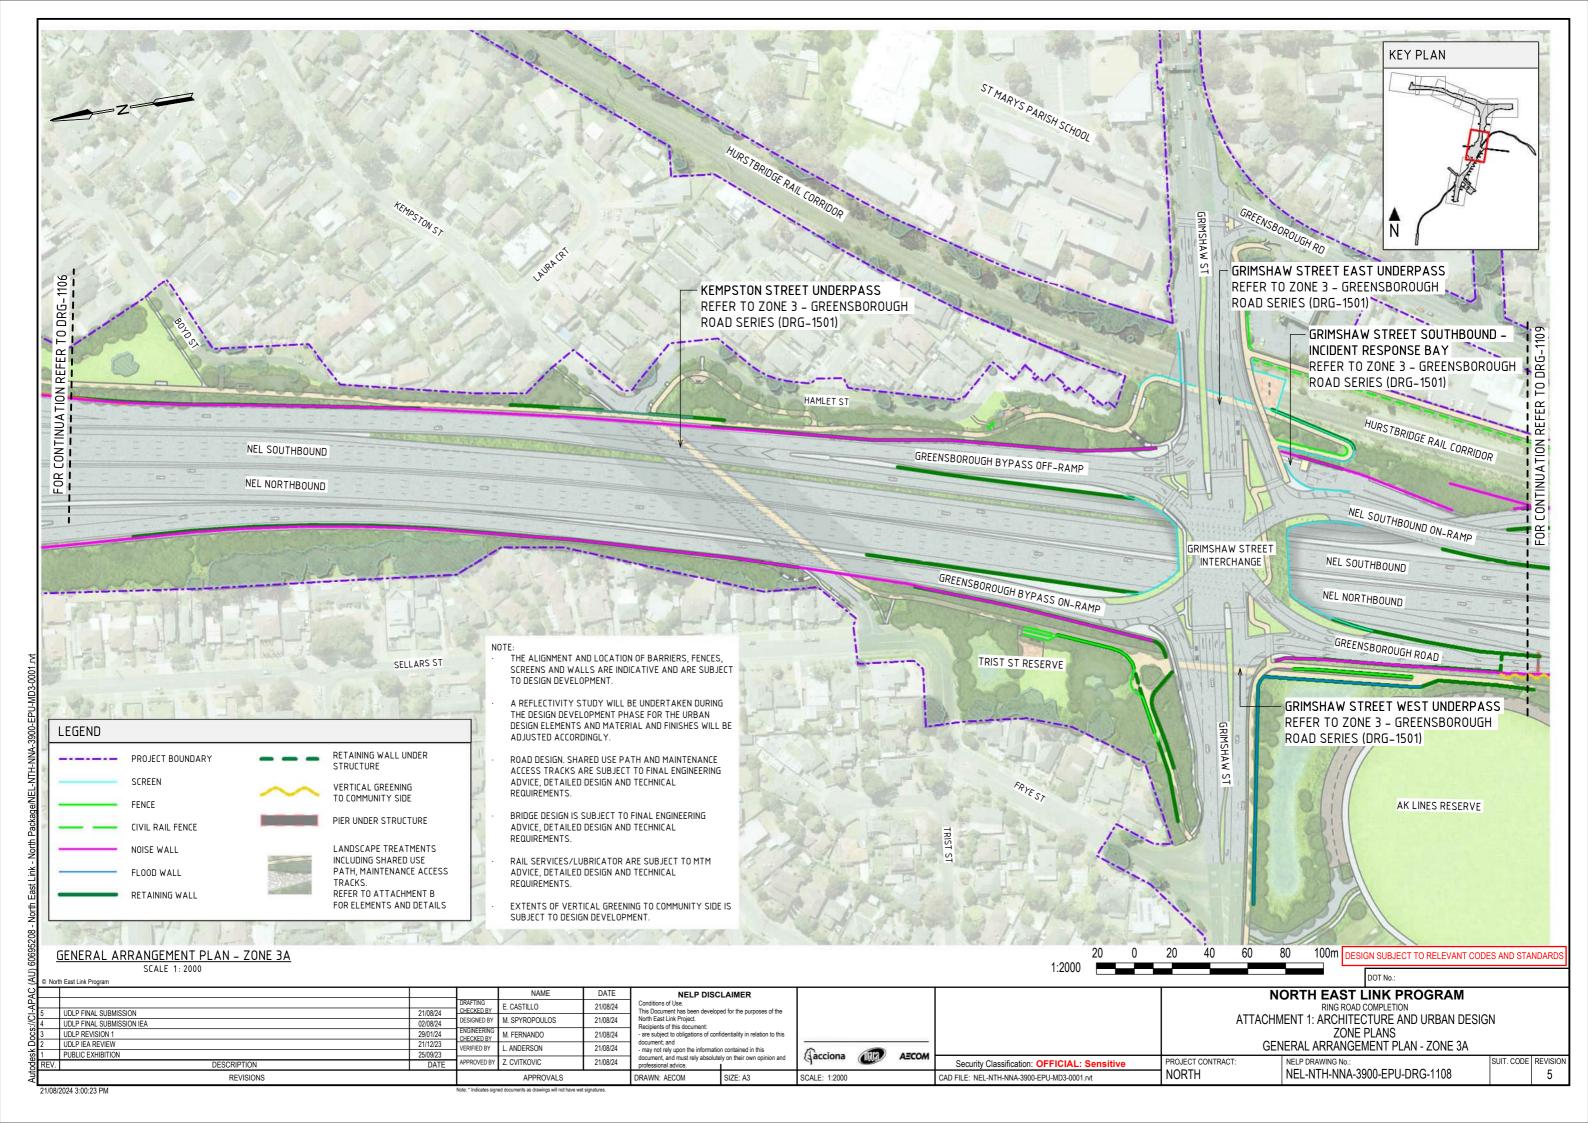

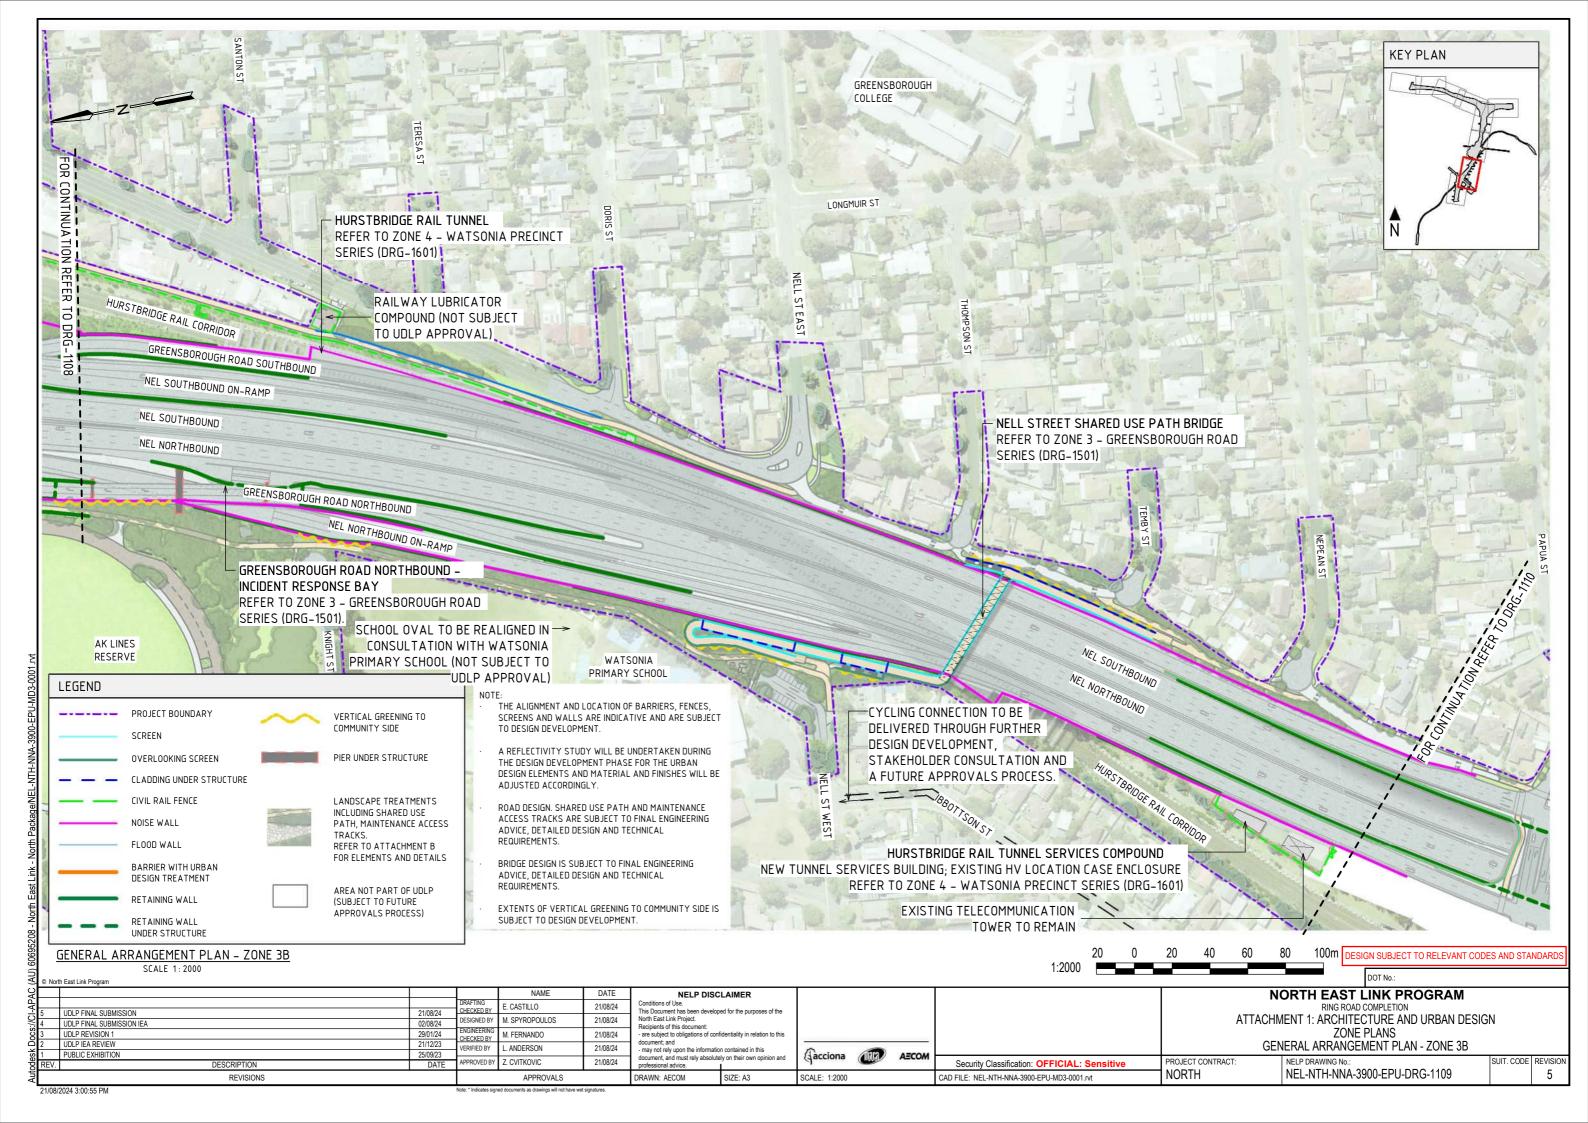

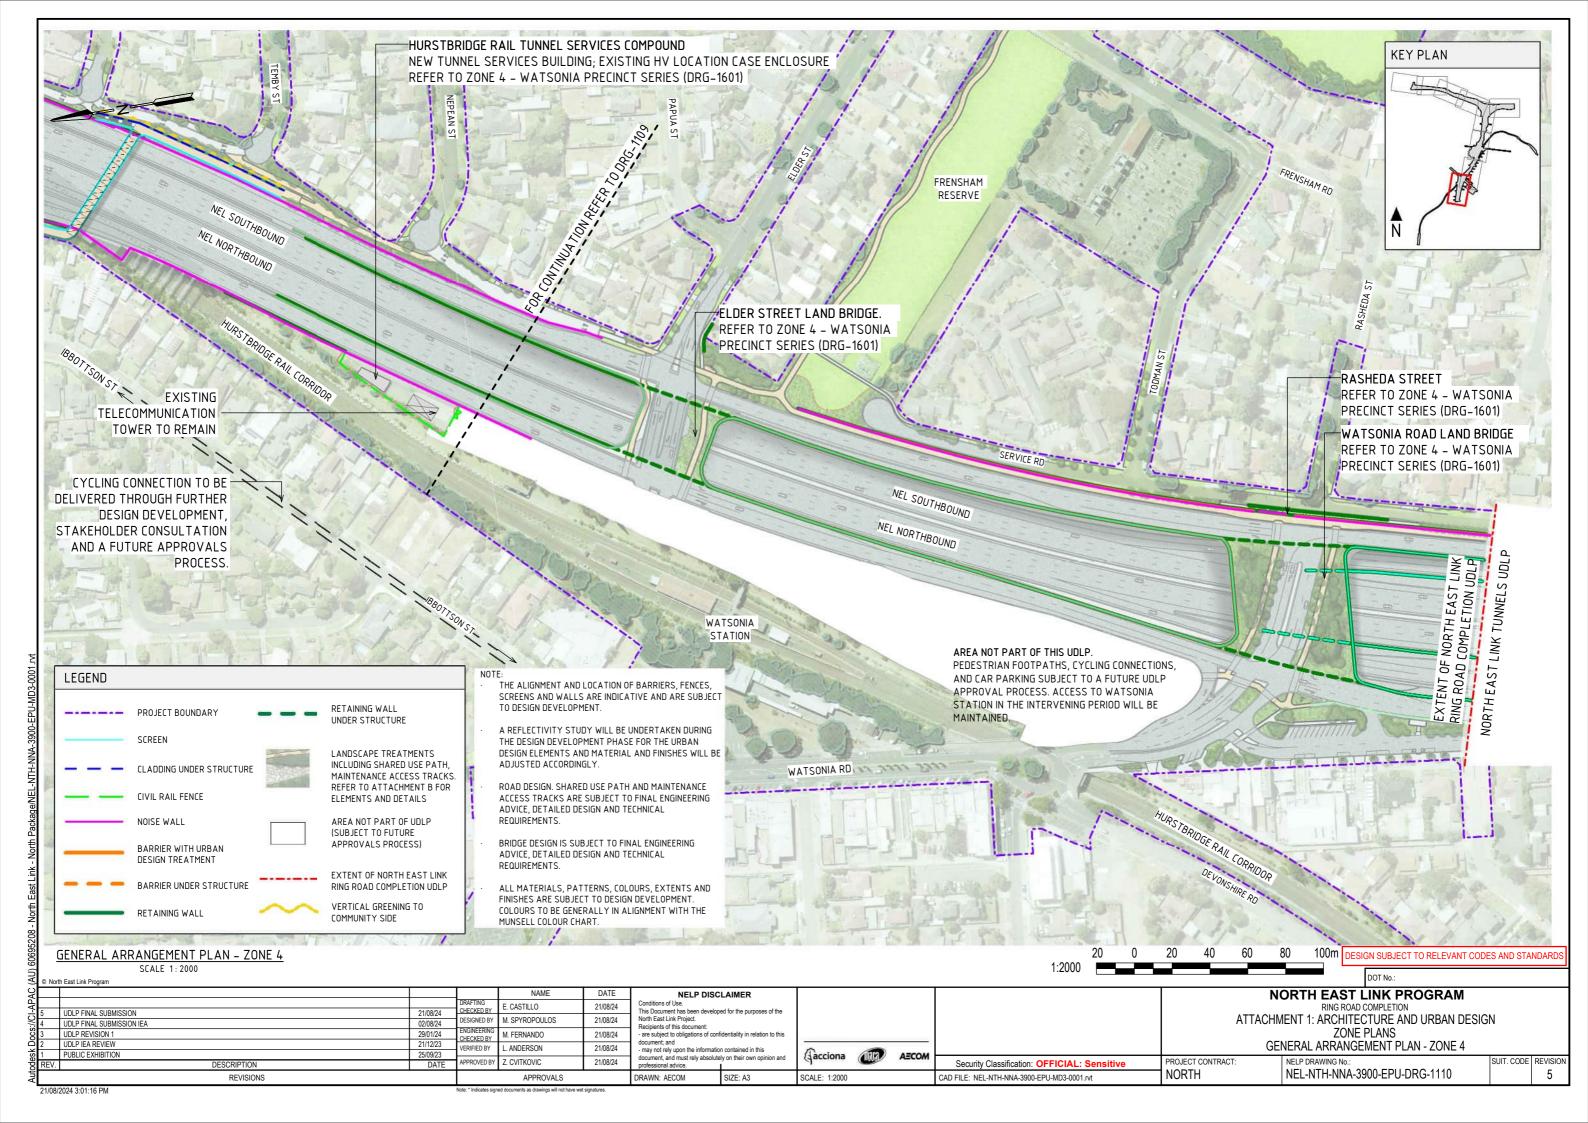



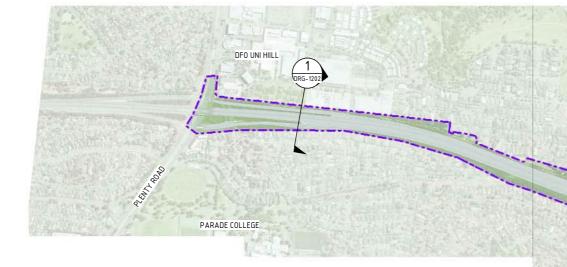

URBAN DESIGN SECTIONS

DRAWING INDEX

DRAWING NAME	SHEET NUMBER
LOCALITY PLAN	NEL-NTH-NNA-3900-EPU-DRG-1201
SECTIONS - ZONE 1 - M80 RING ROAD	NEL-NTH-NNA-3900-EPU-DRG-1202
SECTIONS - ZONE 2 - M80 INTERCHANGE	NEL-NTH-NNA-3900-EPU-DRG-1203
SECTIONS - ZONE 2 - M80 INTERCHANGE	NEL-NTH-NNA-3900-EPU-DRG-1204
SECTIONS - ZONE 3 - GREENSBOROUGH ROAD	NEL-NTH-NNA-3900-EPU-DRG-1205
SECTIONS - ZONE 4 - WATSONIA PRECINCT	NEL-NTH-NNA-3900-EPU-DRG-1206
SECTIONS - ZONE 4 - WATSONIA PRECINCT	NEL-NTH-NNA-3900-EPU-DRG-1207
SECTIONS - ZONE 4 - WATSONIA PRECINCT	NEL-NTH-NNA-3900-EPU-DRG-1208
SECTIONS - ZONE 2 - M80 INTERCHANGE	NEL-NTH-NNA-3900-EPU-DRG-1209
SECTIONS - ZONE 2 - M80 INTERCHANGE	NEL-NTH-NNA-3900-EPU-DRG-1210
SECTIONS - ZONE 2 - M80 INTERCHANGE	NEL-NTH-NNA-3900-EPU-DRG-1211
SECTIONS - ZONE 2 - M80 INTERCHANGE	NEL-NTH-NNA-3900-EPU-DRG-1212
SECTIONS - ZONE 2 - M80 INTERCHANGE	NEL-NTH-NNA-3900-EPU-DRG-1213
SECTIONS – ZONE 3 – AK LINES AND GREENSBOROUGH ROAD	NEL-NTH-NNA-3900-EPU-DRG-1214
SECTIONS - ZONE 3 - GREENSBOROUGH ROAD - GRIMSHAW INTERCHANGE	NEL-NTH-NNA-3900-EPU-DRG-1215
SECTIONS – ZONE 3 – WATSONIA PRIMARY SCHOOL INTERFACE	NEL-NTH-NNA-3900-EPU-DRG-1216

M80 INTERCHANGE BINNAK YANDO STREET UNDERPASS KALPARRIN GARDENS LEGEND WATSONIA PROJECT BOUNDARY NORTH PRIMARY SCHOOL EXTENT OF NORTH EAST LINK RING ROAD COMPLETION UDLP KEMPSTON STREET UNDERPASS AREA NOT PART OF UDLP (SUBJECT TO FUTURE APPROVALS TRIST STREET RESERVE LANDSCAPE TREATMENTS - GRIMSHAW STREET - UKITISHAN - . -INTERCHANGE - . . INCLUDING SHARED USE PATH, LOYOLA MAINTENANCE ACCESS TRACKS. COLLEGE AK LINES RESERVE REFER TO ATTACHMENT B FOR ELEMENTS AND DETAILS WATSONIA PRIMARY SCREENS AND WALLS ARE INDICATIVE AND ARE SUBJECT SCHOOL

PLENTY GORGE PARKLANDS

- MACORNA STREET SHARED USE PATH BRIDGE

THE ALIGNMENT AND LOCATION OF BARRIERS, FENCES,

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DESIGN SUBJECT TO RELEVANT CODES AND STANDAR

NORTH EAST LINK PROGRAM

RING ROAD COMPLETION ATTACHMENT 1: ARCHITECTURE AND URBAN DESIGN **URBAN DESIGN SECTIONS**

PROJECT CONTRACT

NORTH

LOCALITY PLAN NELP DRAWING No.

NEL-NTH-NNA-3900-EPU-DRG-1201

SUIT. CODE REVISION

DATE E. CASTILLO 21/08/24 UDLP FINAL SUBMISSION 21/08/24 M SPYROPOULOS 21/08/24 DESIGNED BY UDLP FINAL SUBMISSION IEA 02/08/24 M. FERNANDO 21/08/24 UDLP REVISION 1 29/01/24 CHECKED BY UDLP IEA REVIEW ERIFIED BY . ANDERSON 21/08/24 PUBLIC EXHIBITION APPROVED BY 7 CVITKOVIC 21/08/24 DESCRIPTION

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NELL STREET

REFER TO NORTH EAST LINK TUNNELS UDLP ATTACHMENT 1: ARCHITECTURE & URBAN DESIGN FOR INFORMATION

SIZE: A3

WATSONIA STATION

WATSONIA ROAD LAND BRIDGE

SHARED USE PATH BRIDGE

(acciona SCALE:

Security Classification: CAD FILE: NEL-NTH-NNA-3900-EPU-MD3-0001.rvt

GREENSBOROUGH

GABONIA AVENUE

ELDER STREET


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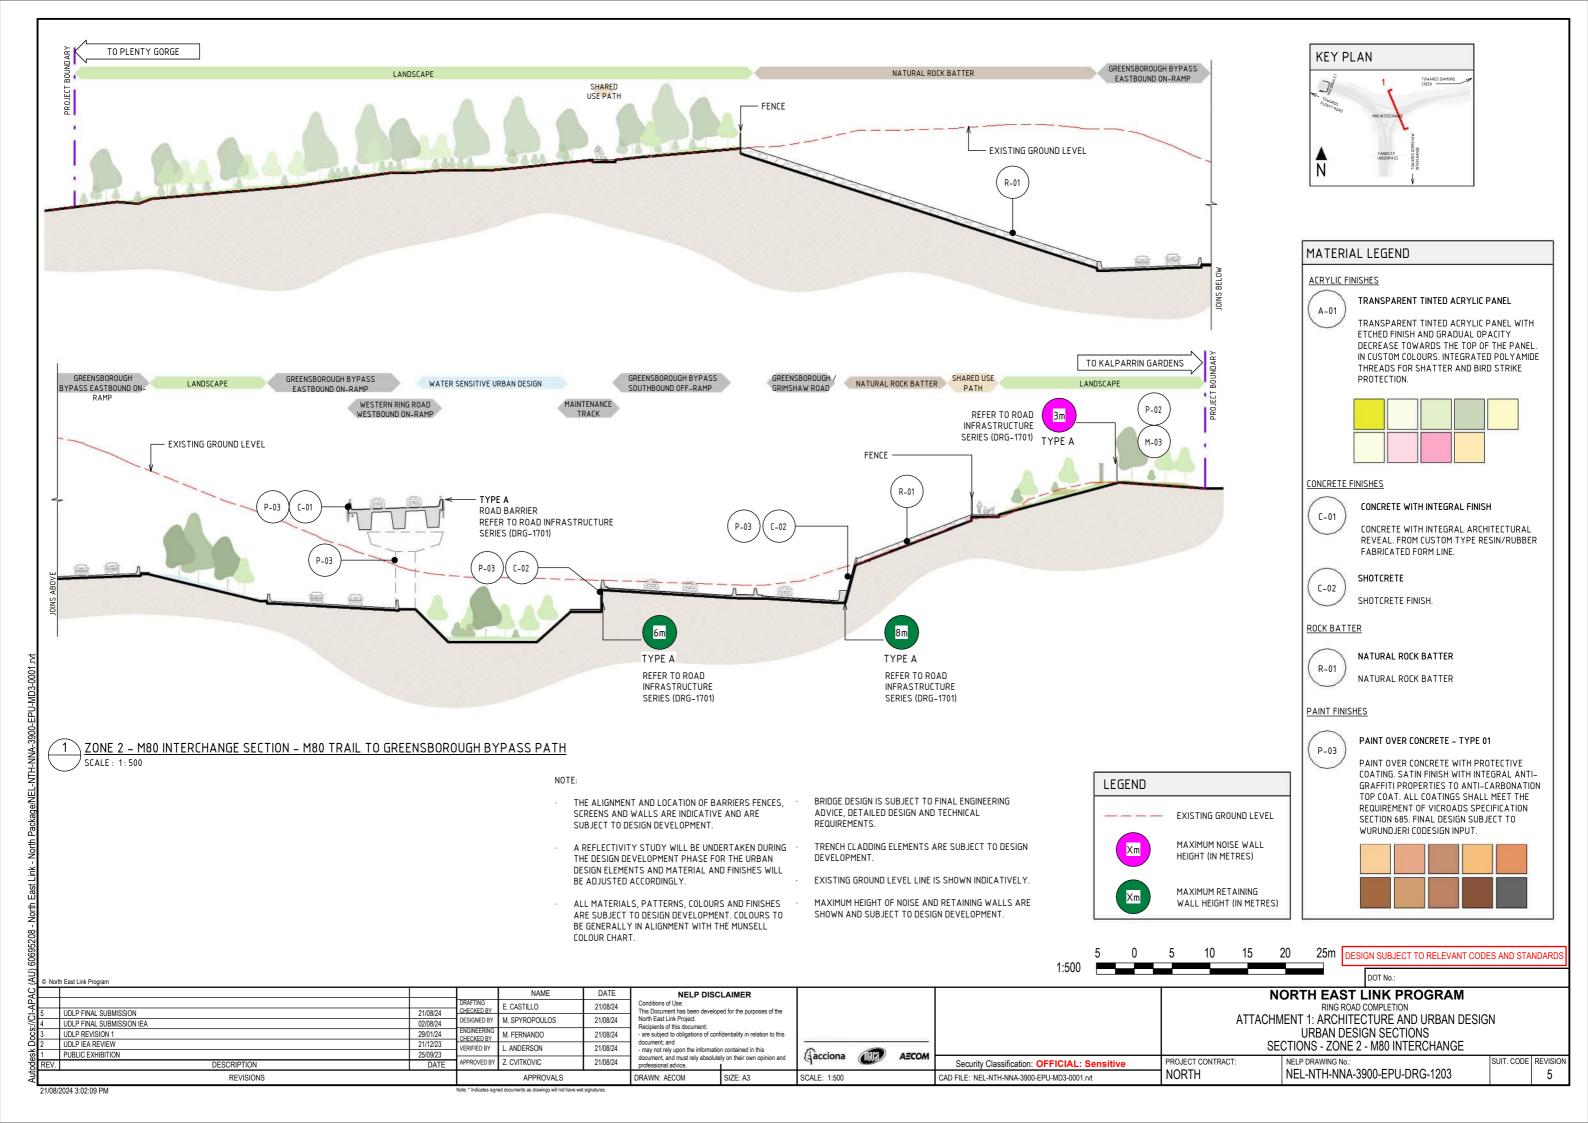
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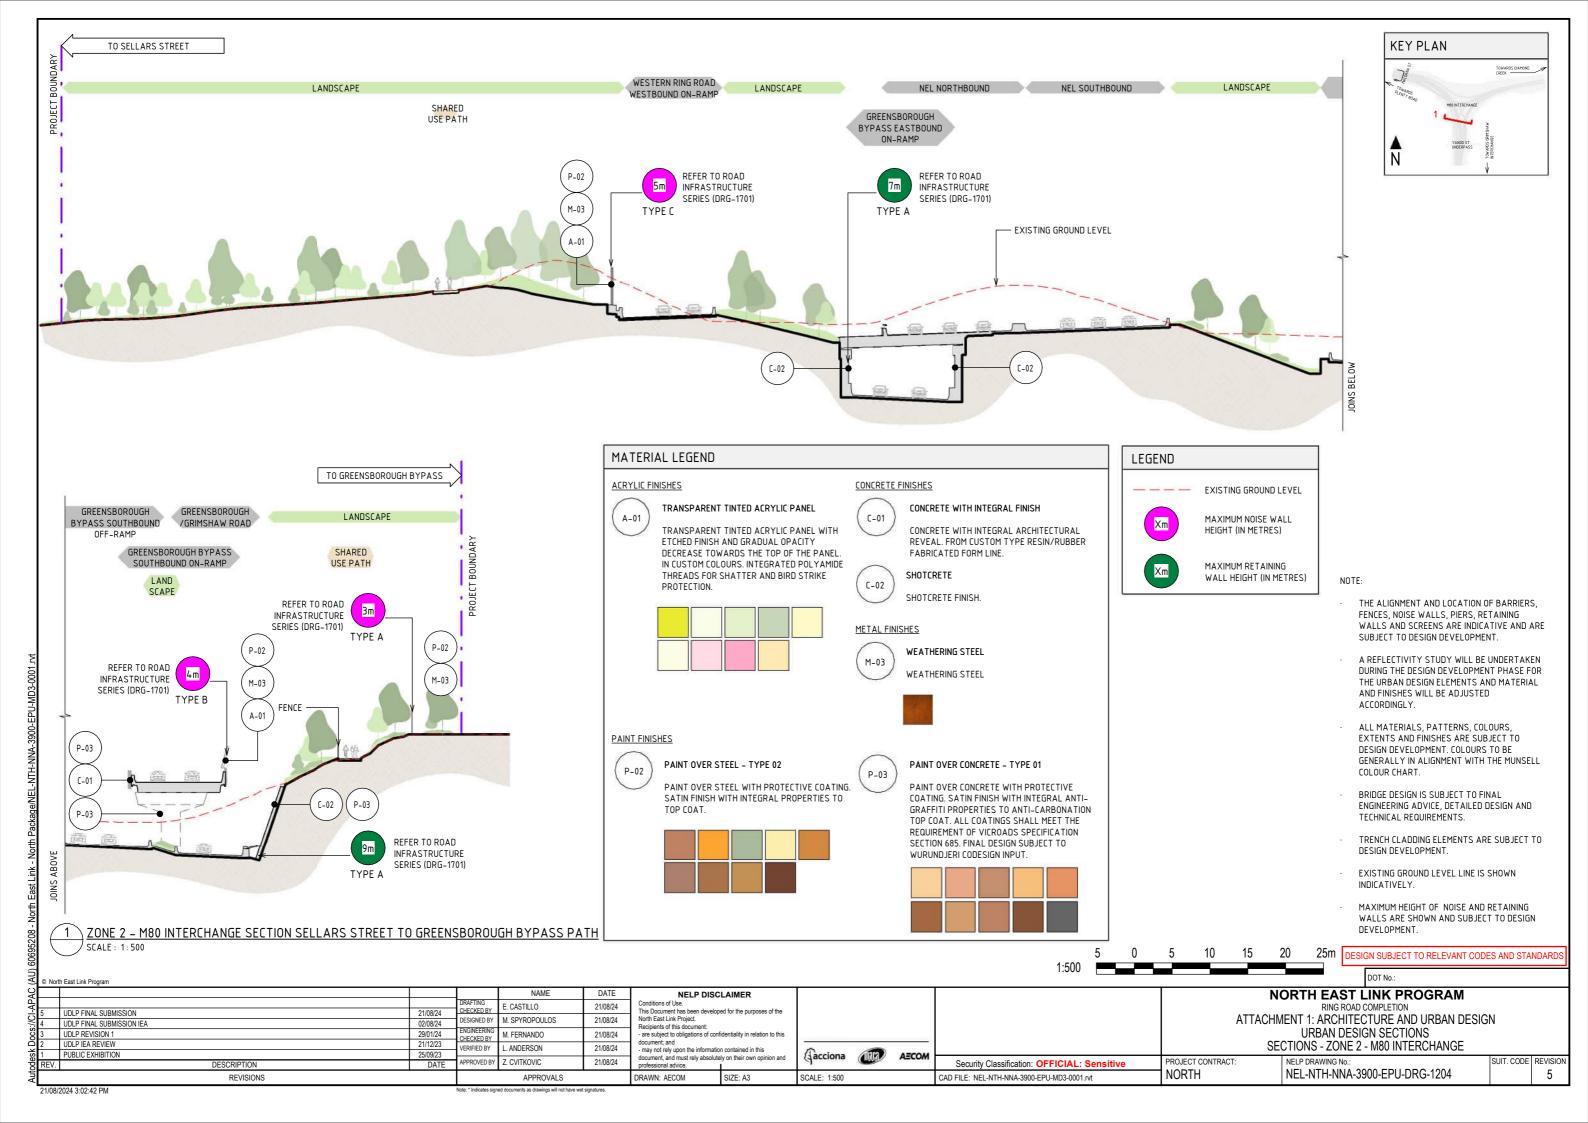
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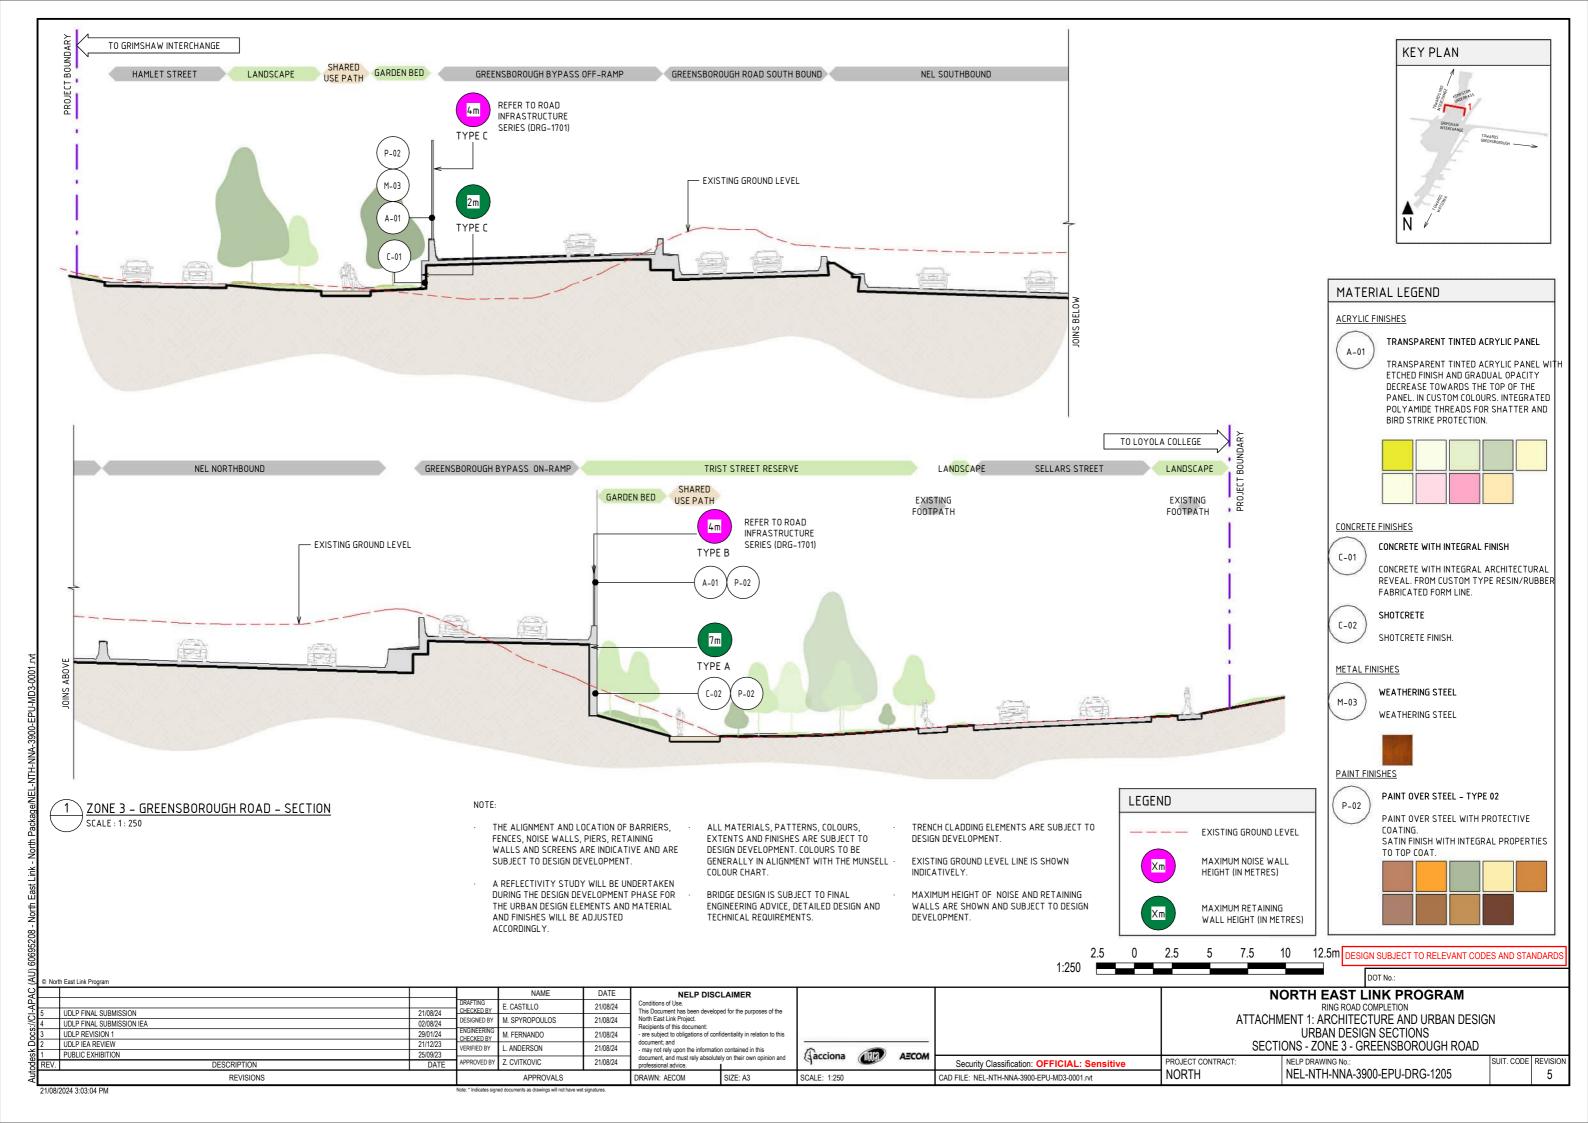
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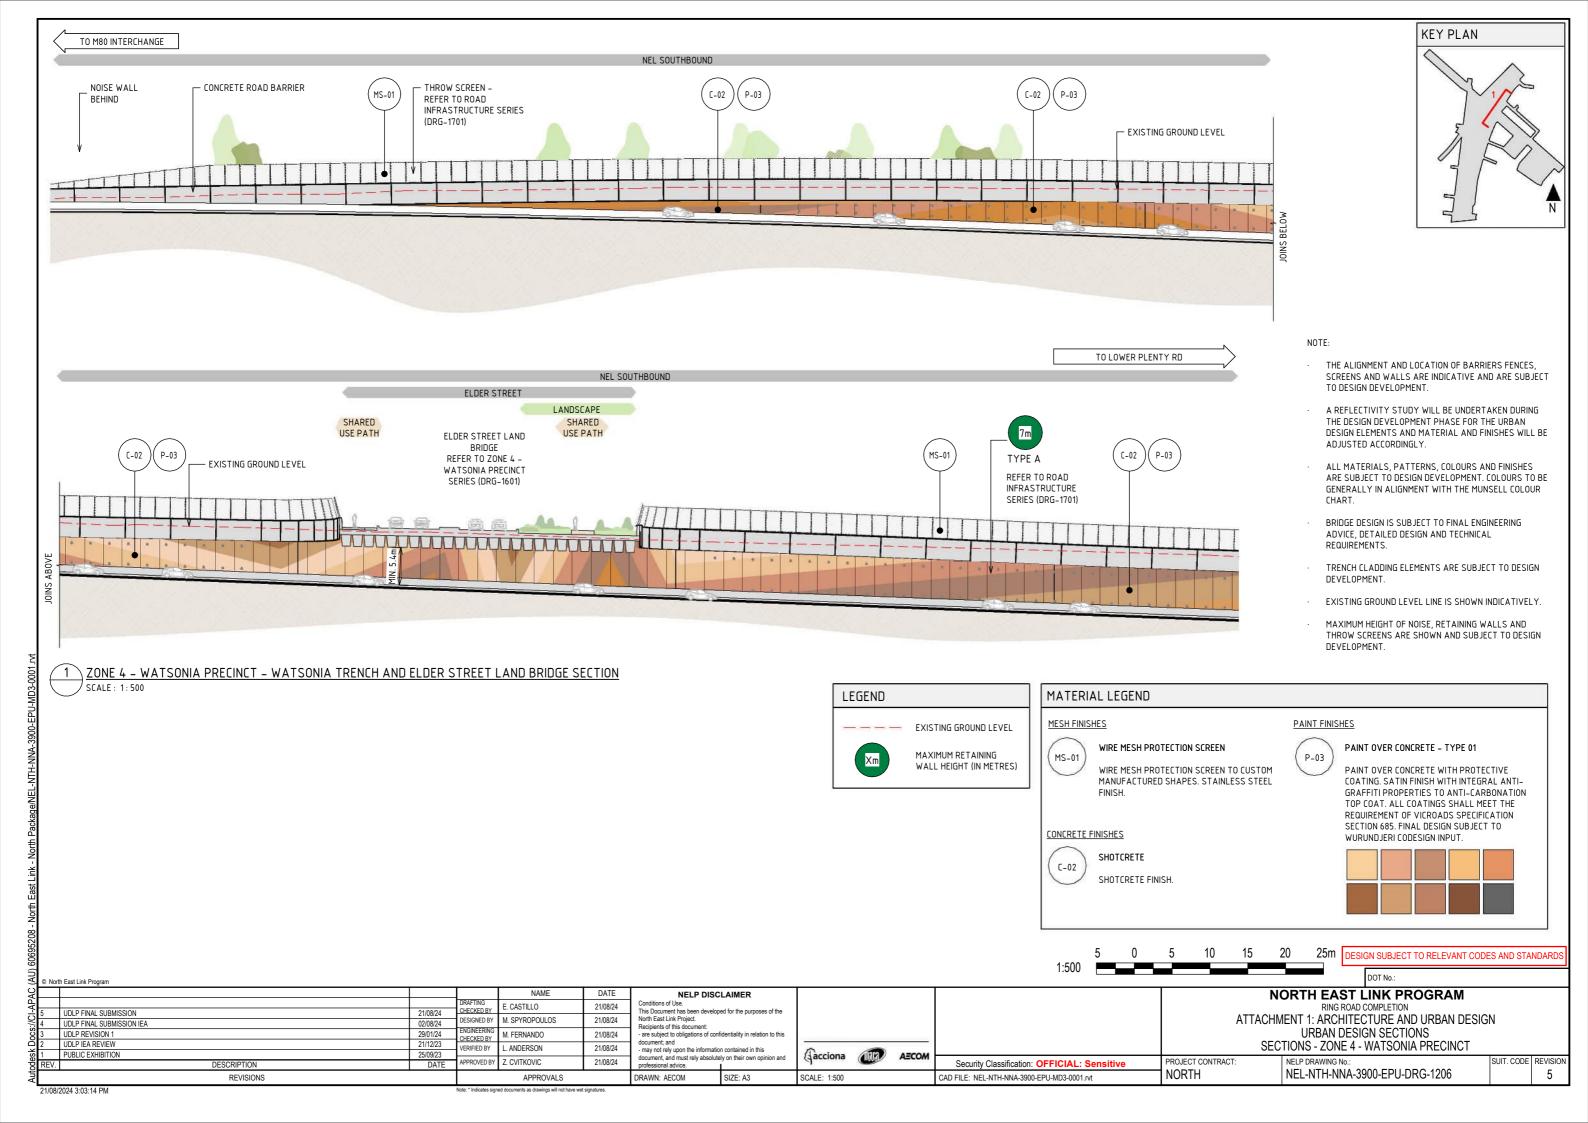
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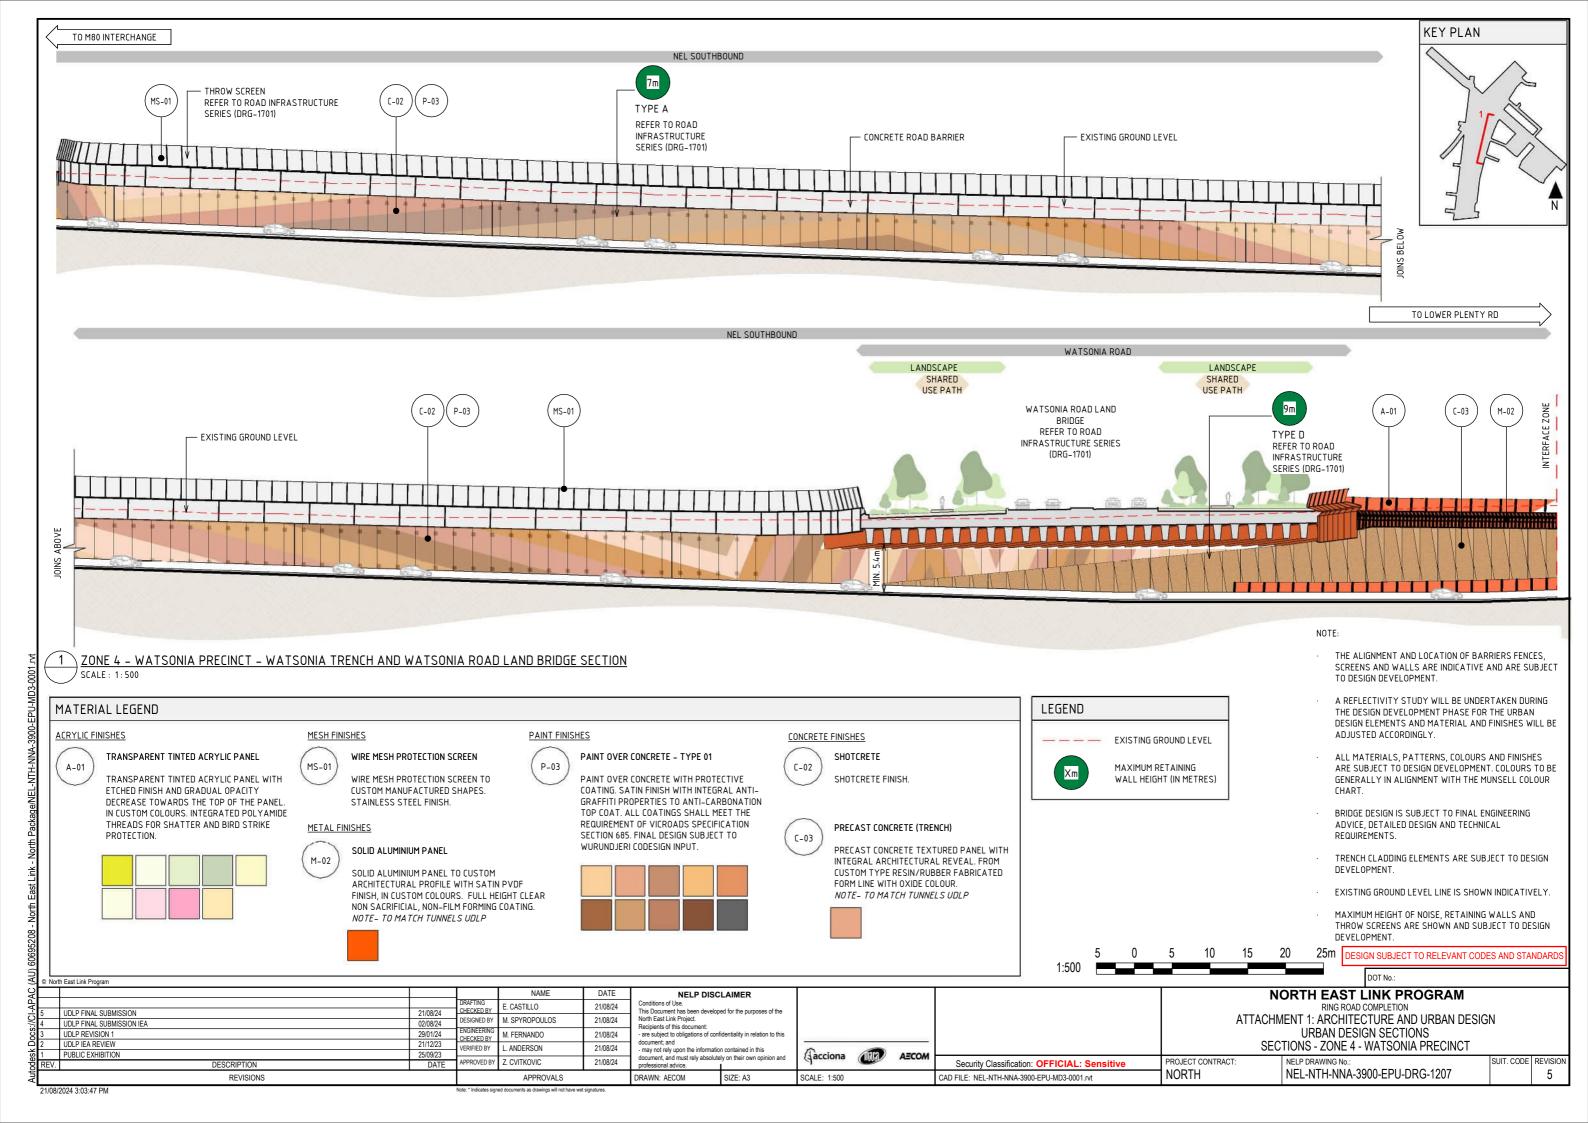











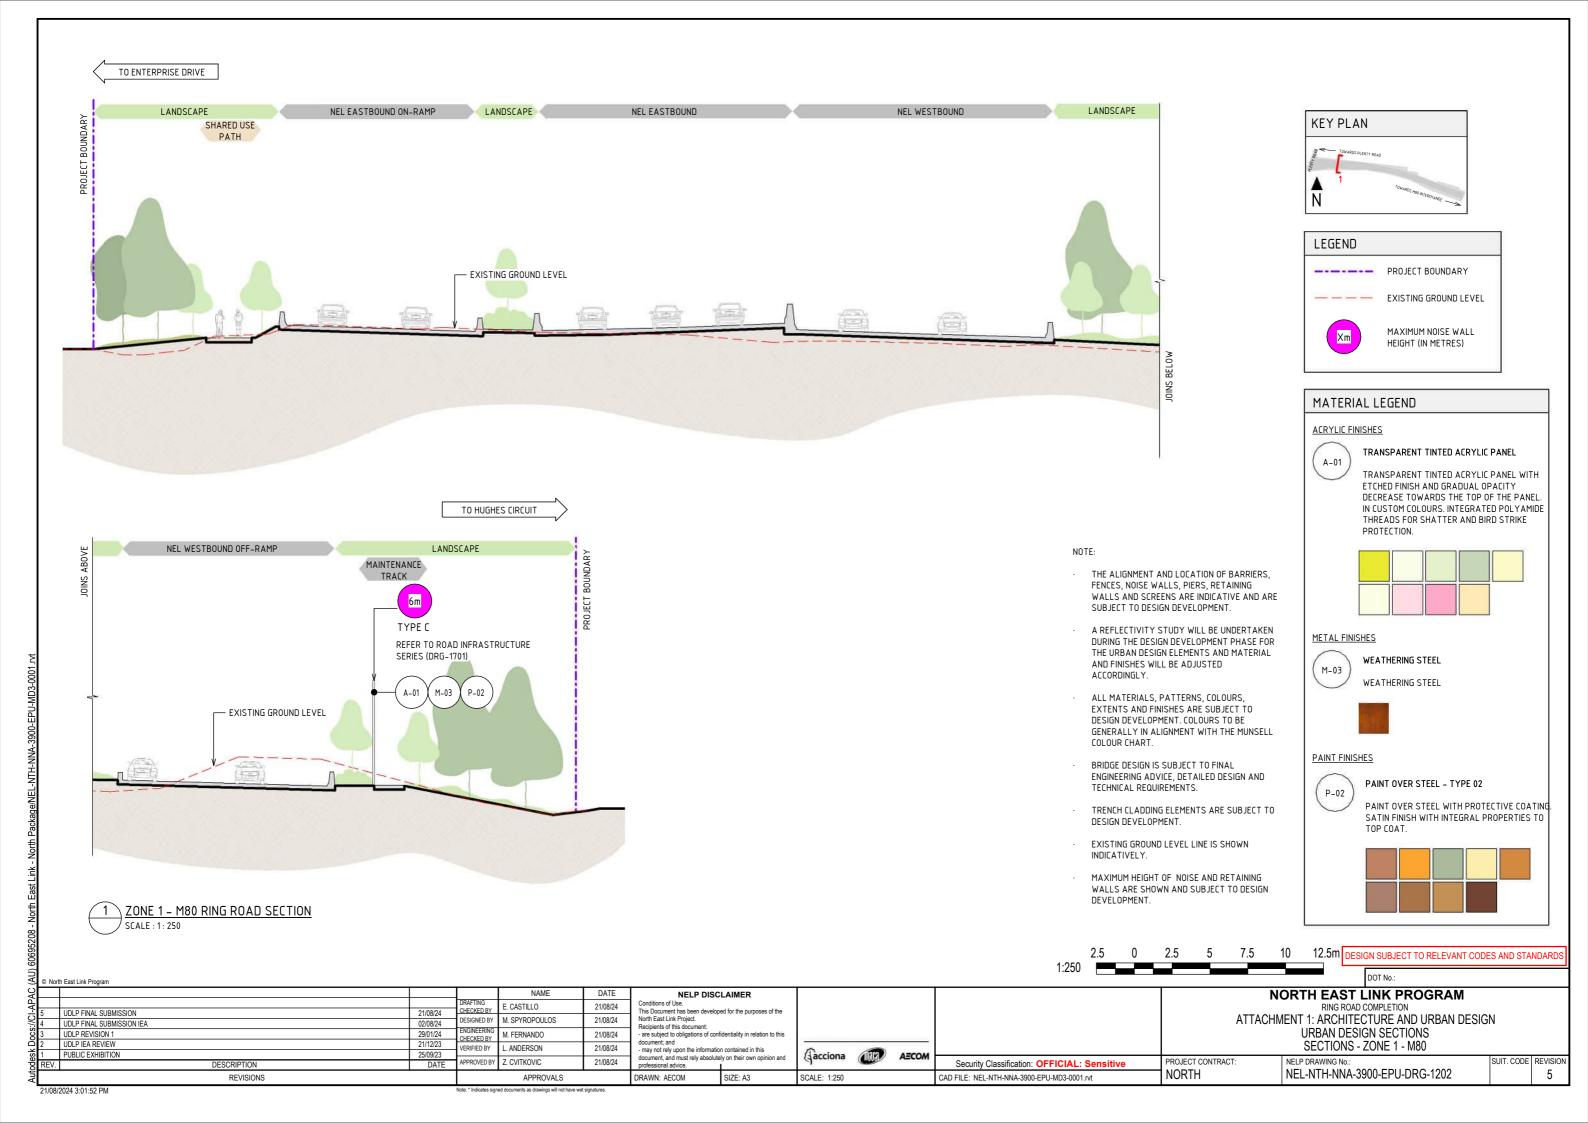

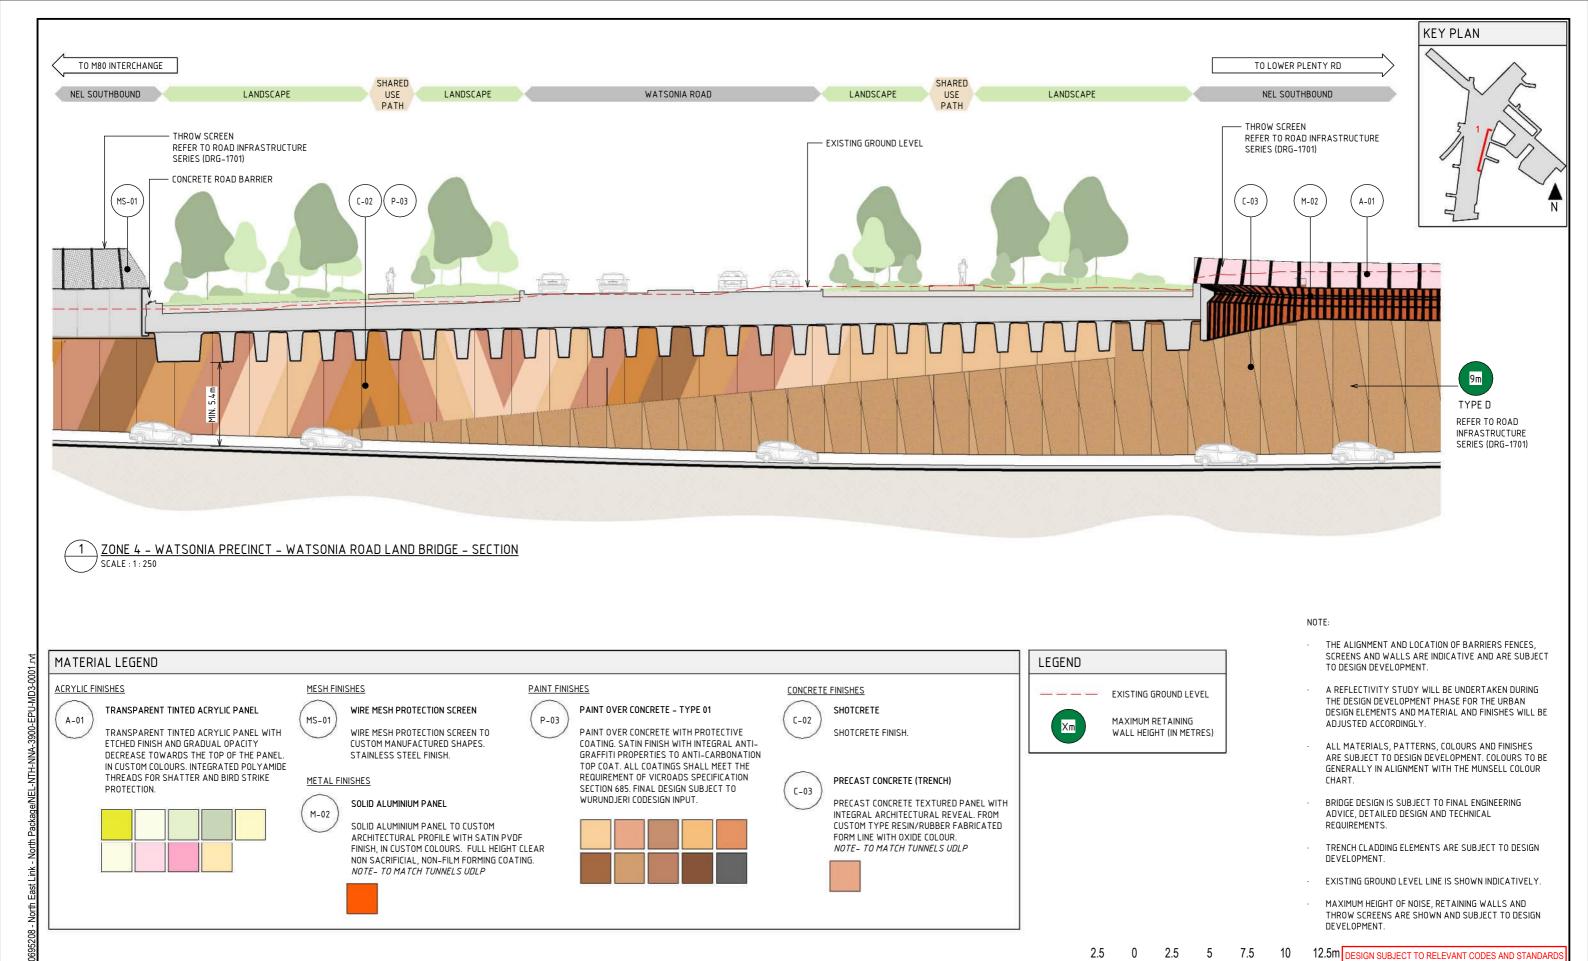

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NEL-NTH-NNA-3900-EPU-DRG-1208

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NORTH

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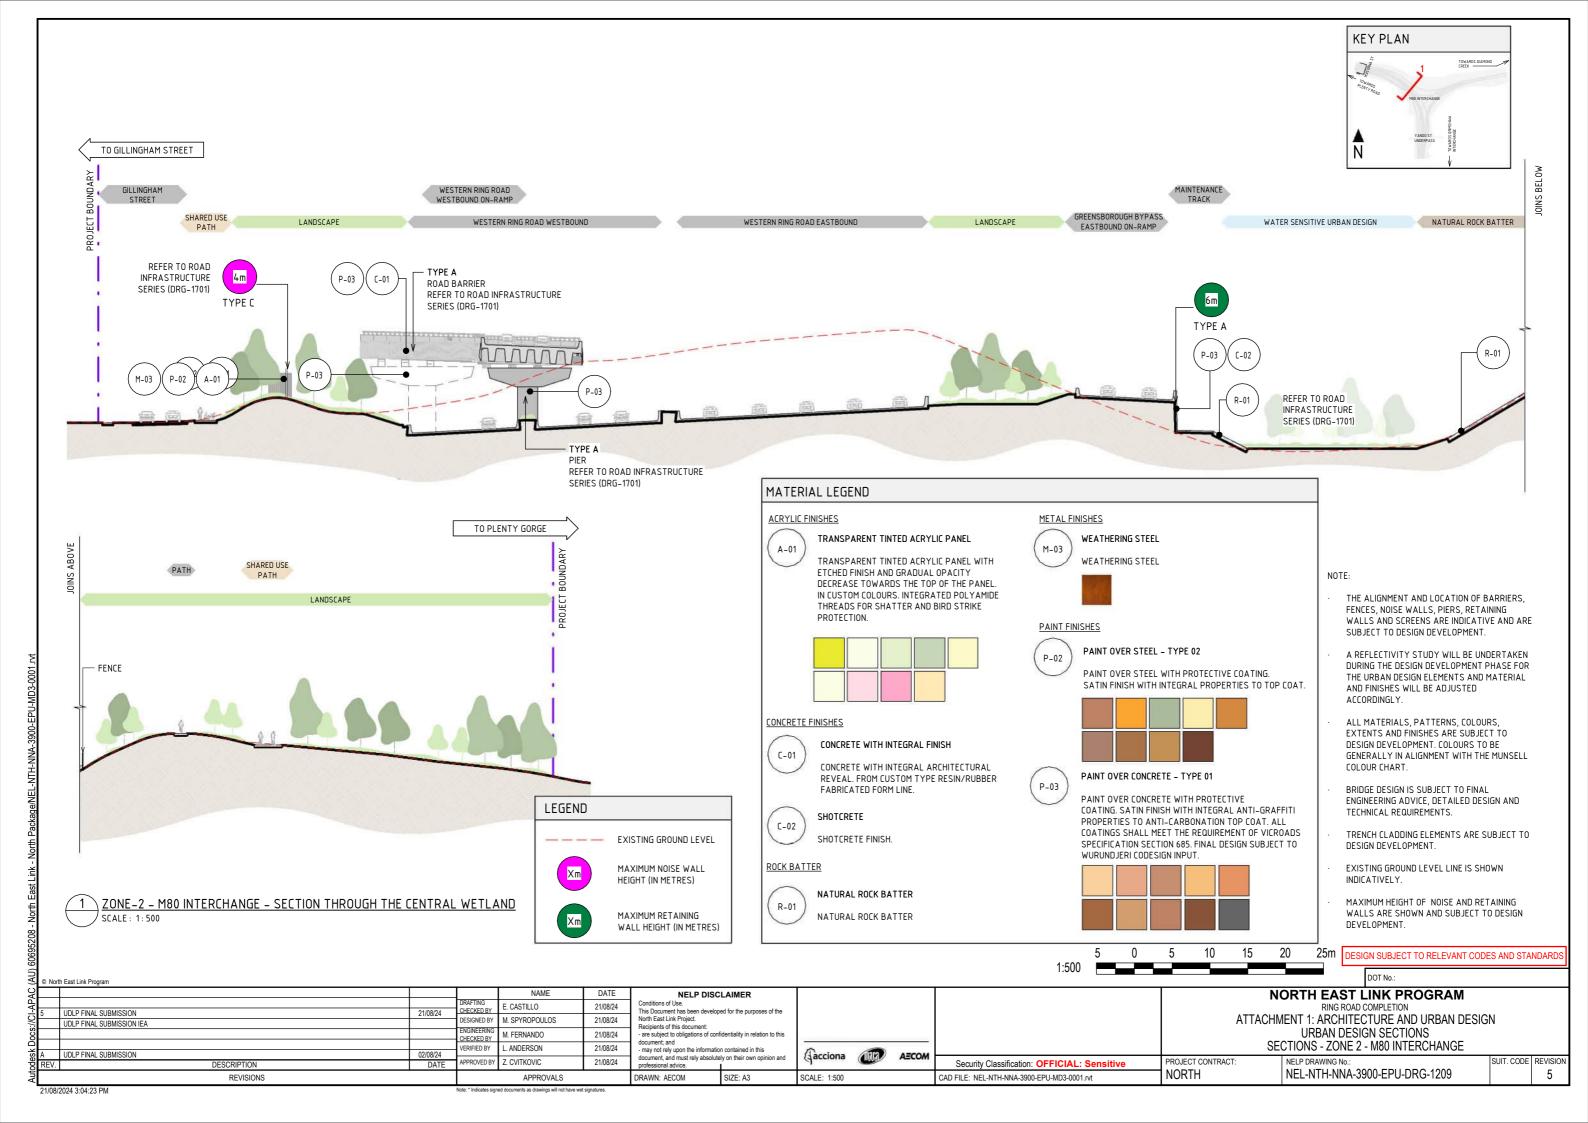
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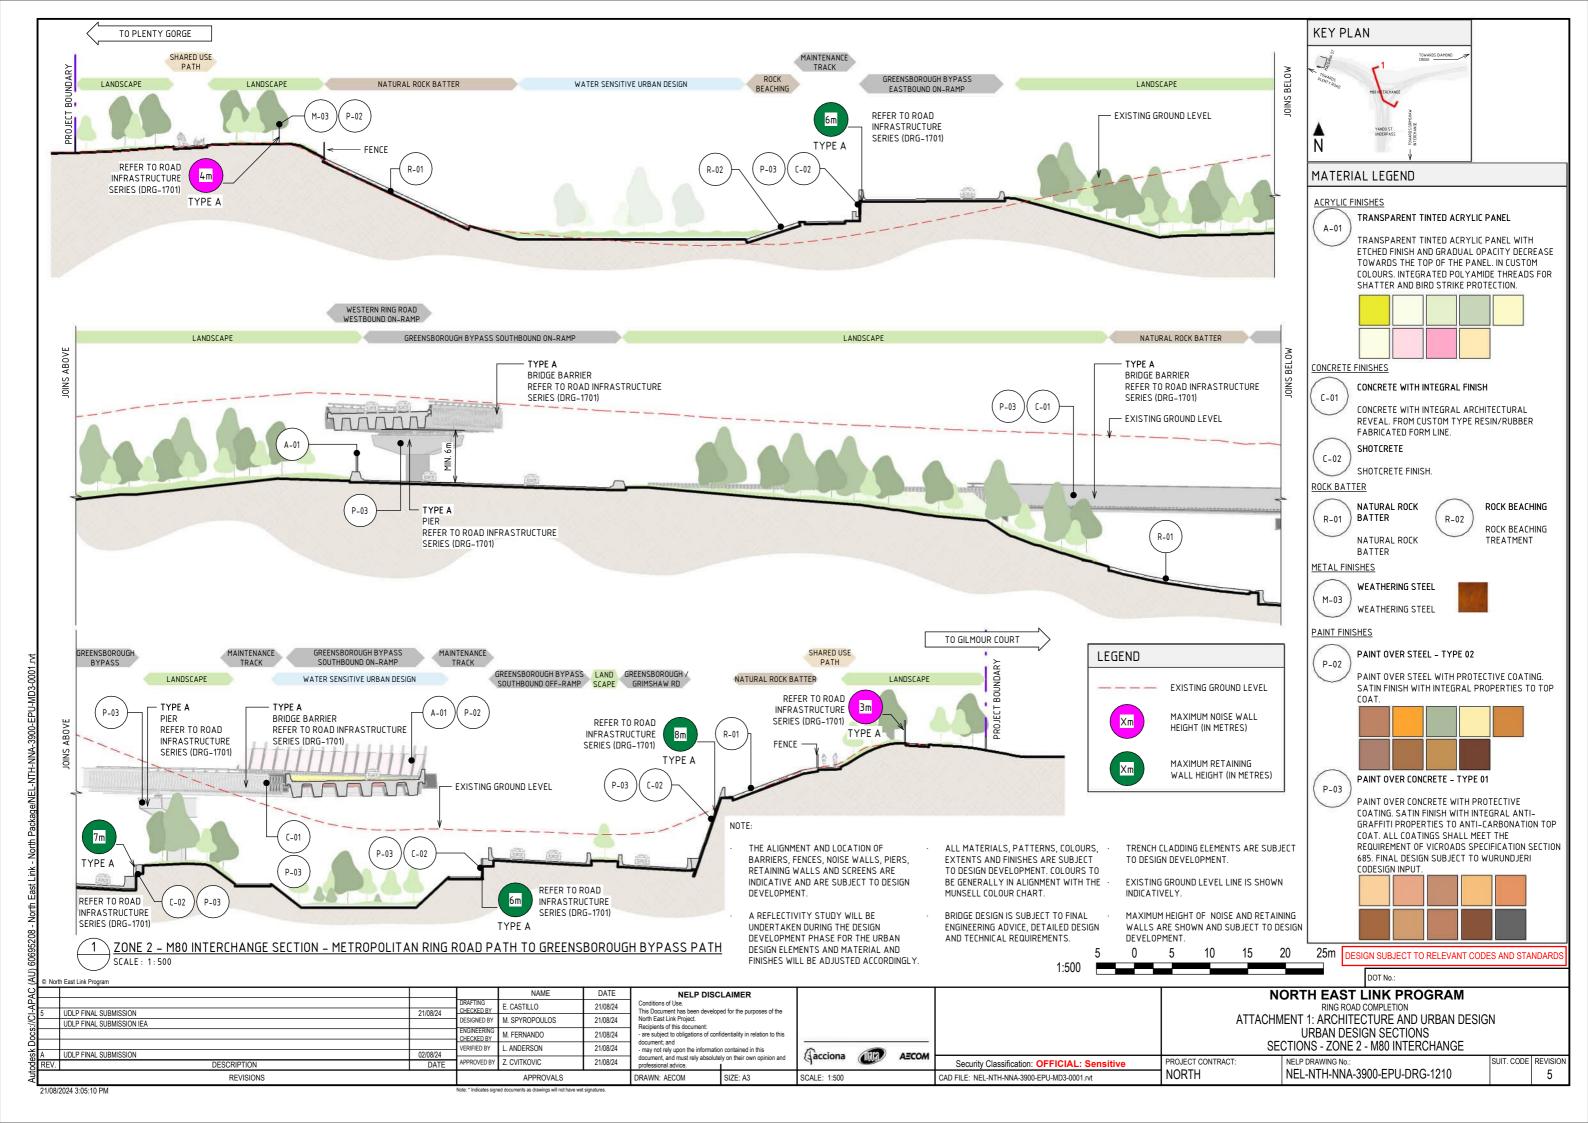
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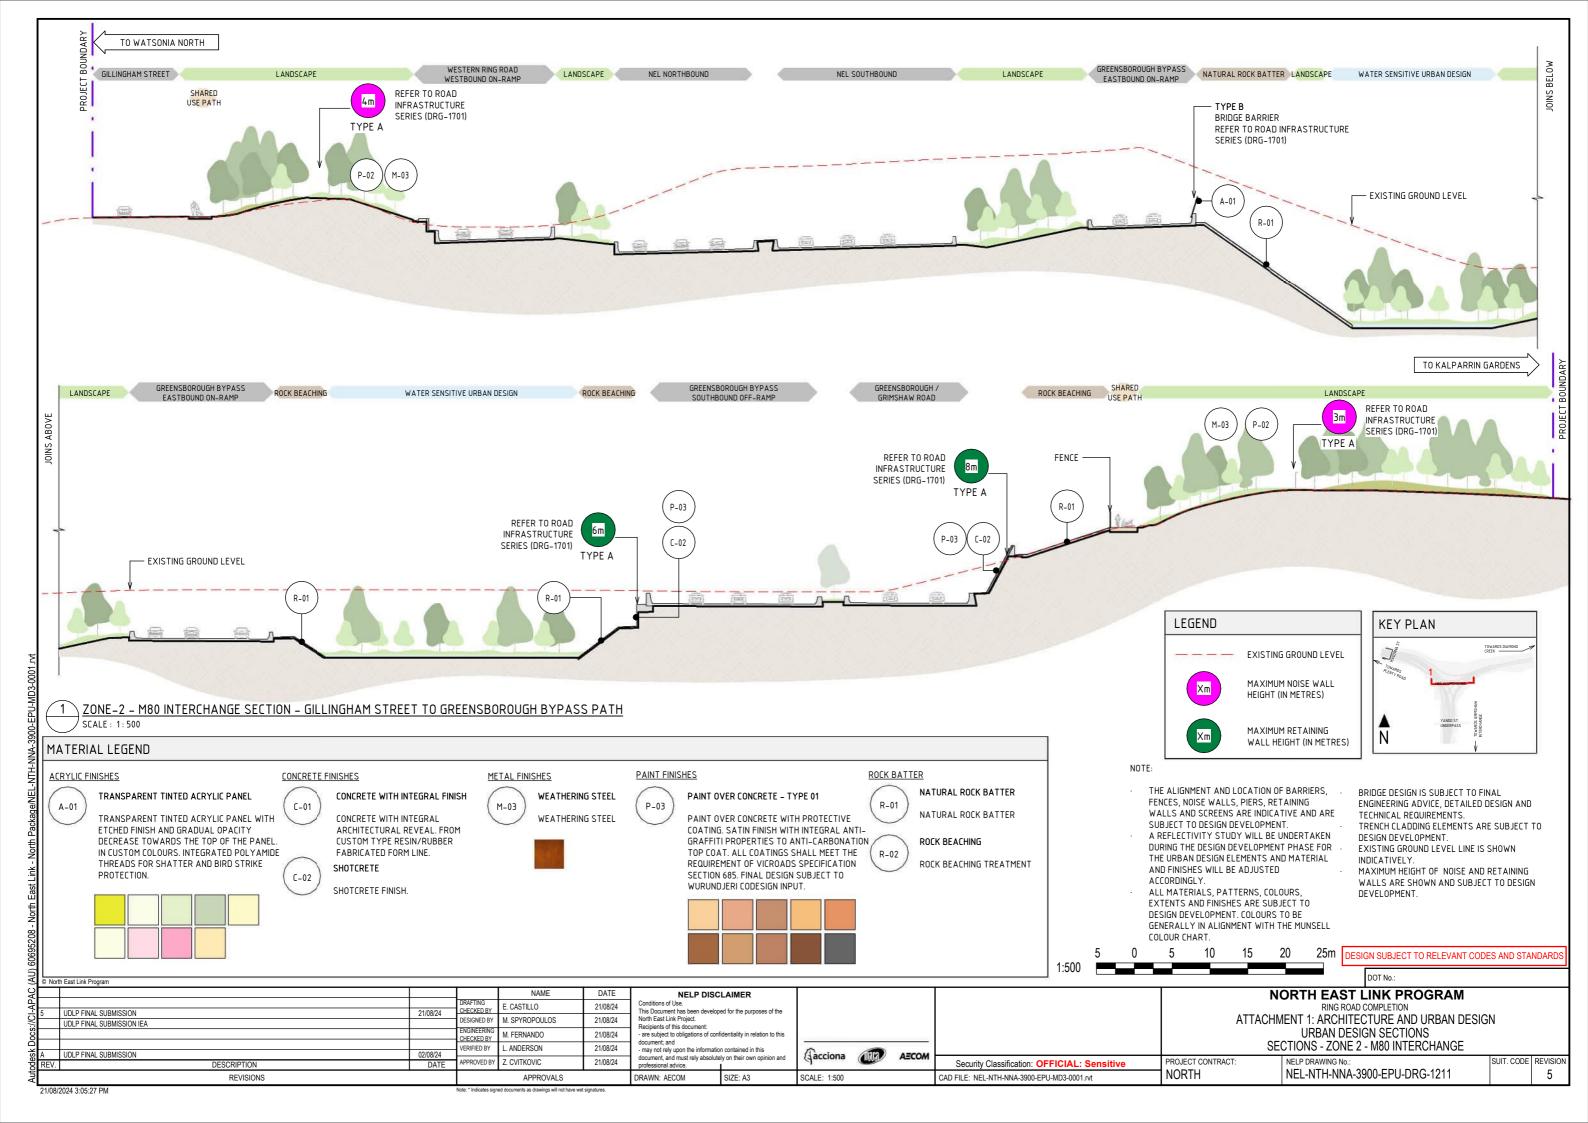
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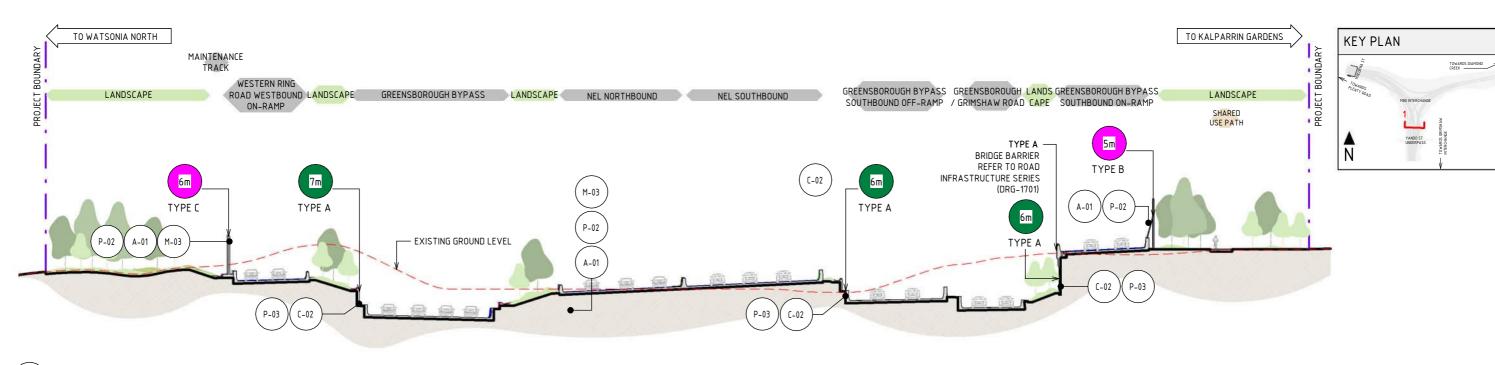
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REVISIONS













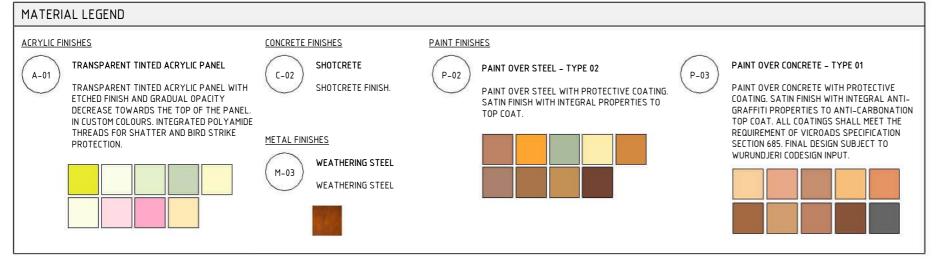

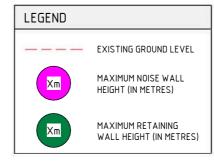

NOTE:

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- EXISTING GROUND LEVEL LINE IS SHOWN INDICATIVELY.

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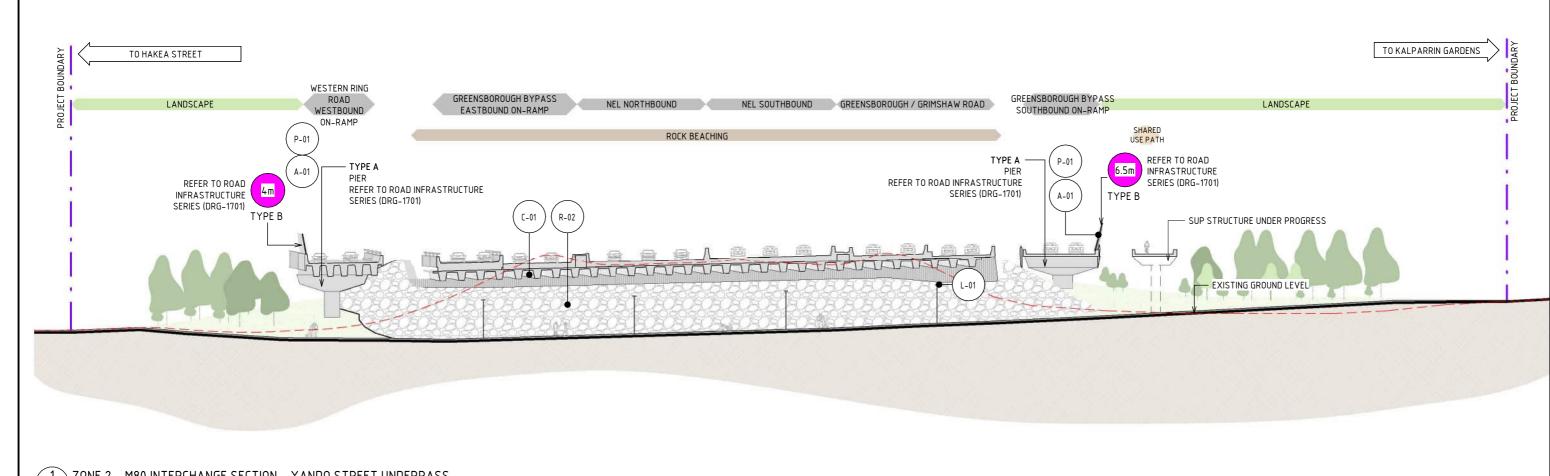
MAXIMUM HEIGHT OF NOISE AND RETAINING WALLS ARE SHOWN AND SUBJECT TO DESIGN DEVELOPMENT.

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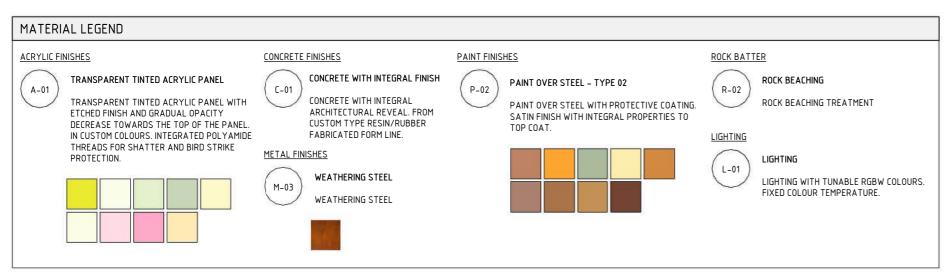
North East Link Program 1:500
DOT No.
50 5 10 15 20 25III DESIGN SUBJECT

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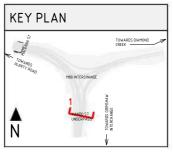



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5 10 20 25m DESIGN SUBJECT TO RELEVANT CODES AND STANDARD 1:500

NORTH EAST LINK PROGRAM

RING ROAD COMPLETION ATTACHMENT 1: ARCHITECTURE AND URBAN DESIGN **URBAN DESIGN SECTIONS**

SECTIONS - ZONE 2 - M80 INTERCHANGE

NEL-NTH-NNA-3900-EPU-DRG-1213
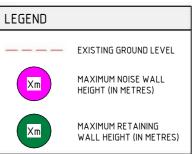
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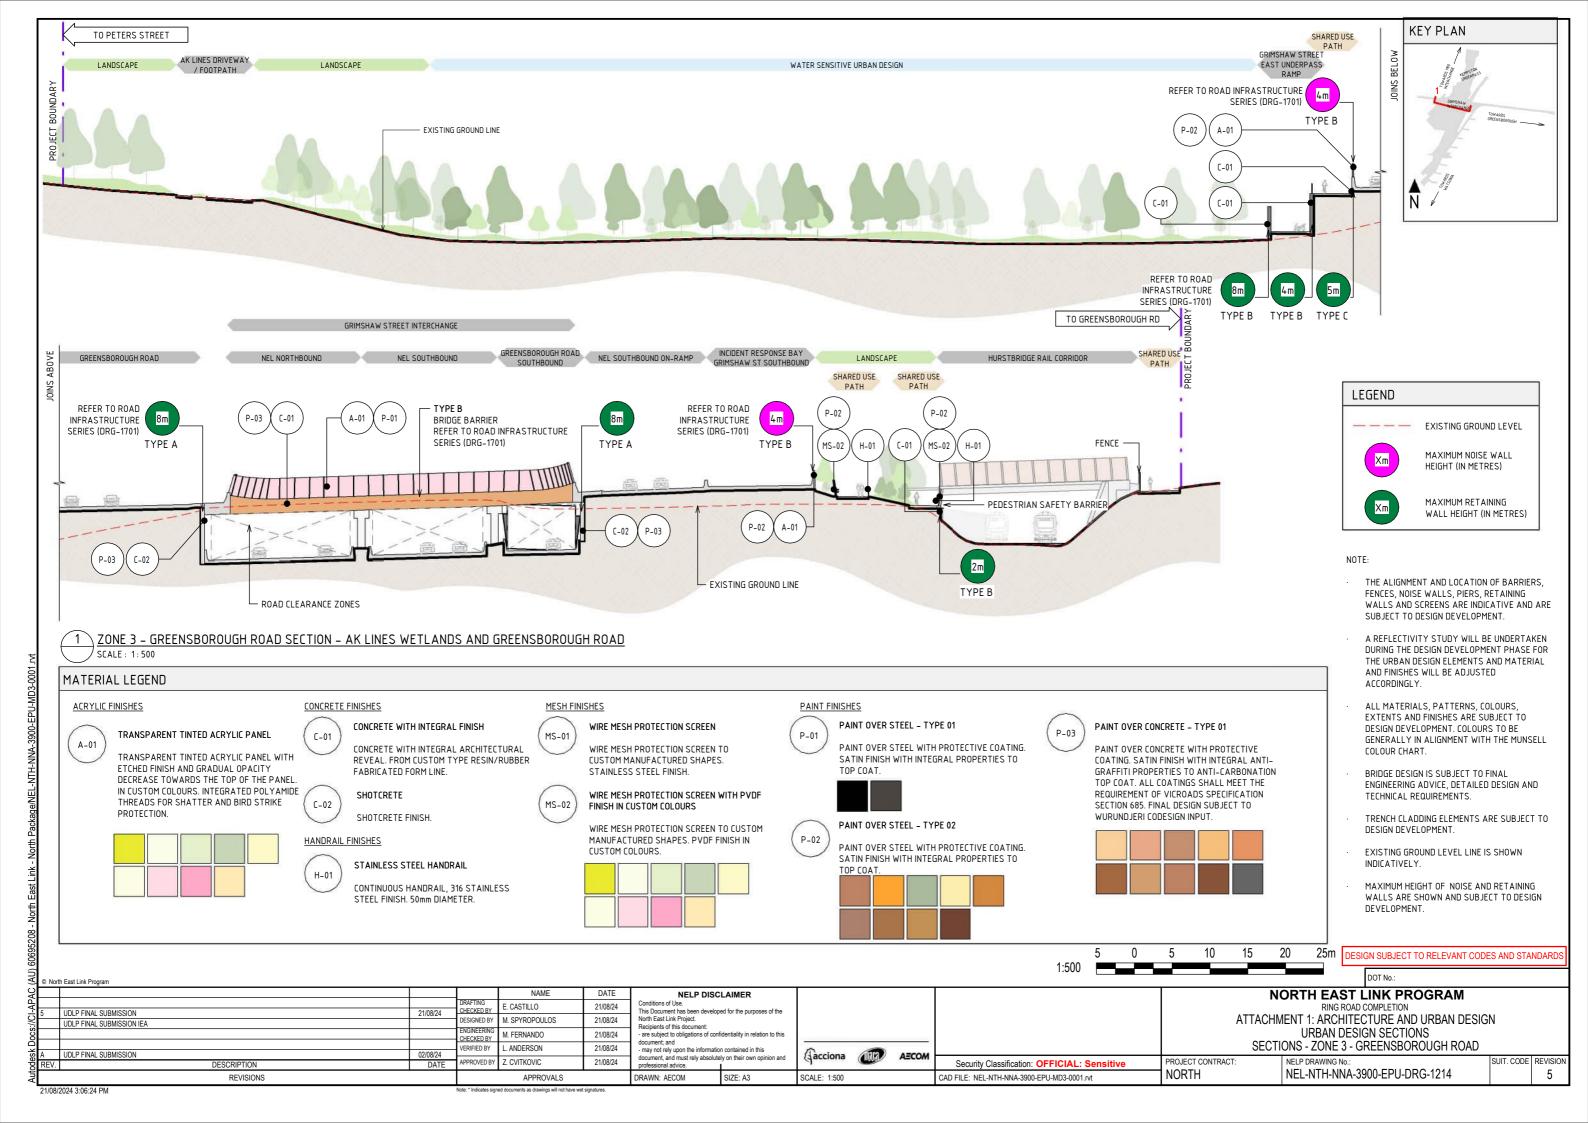
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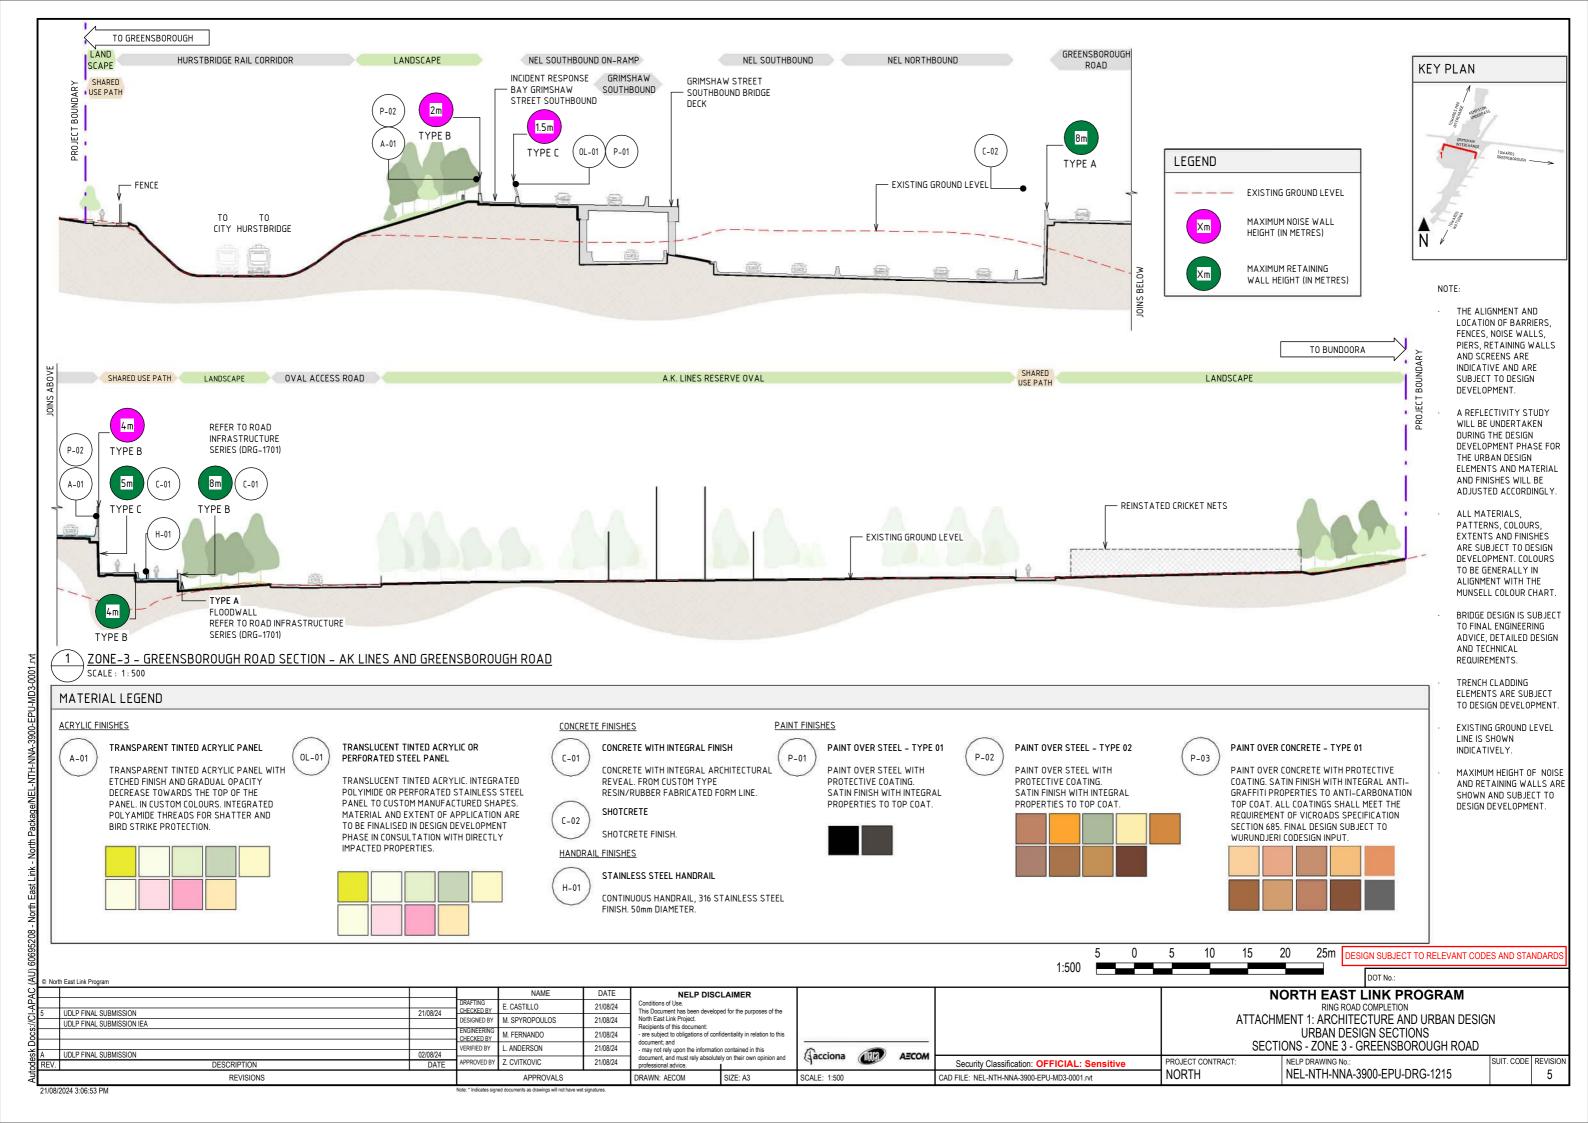
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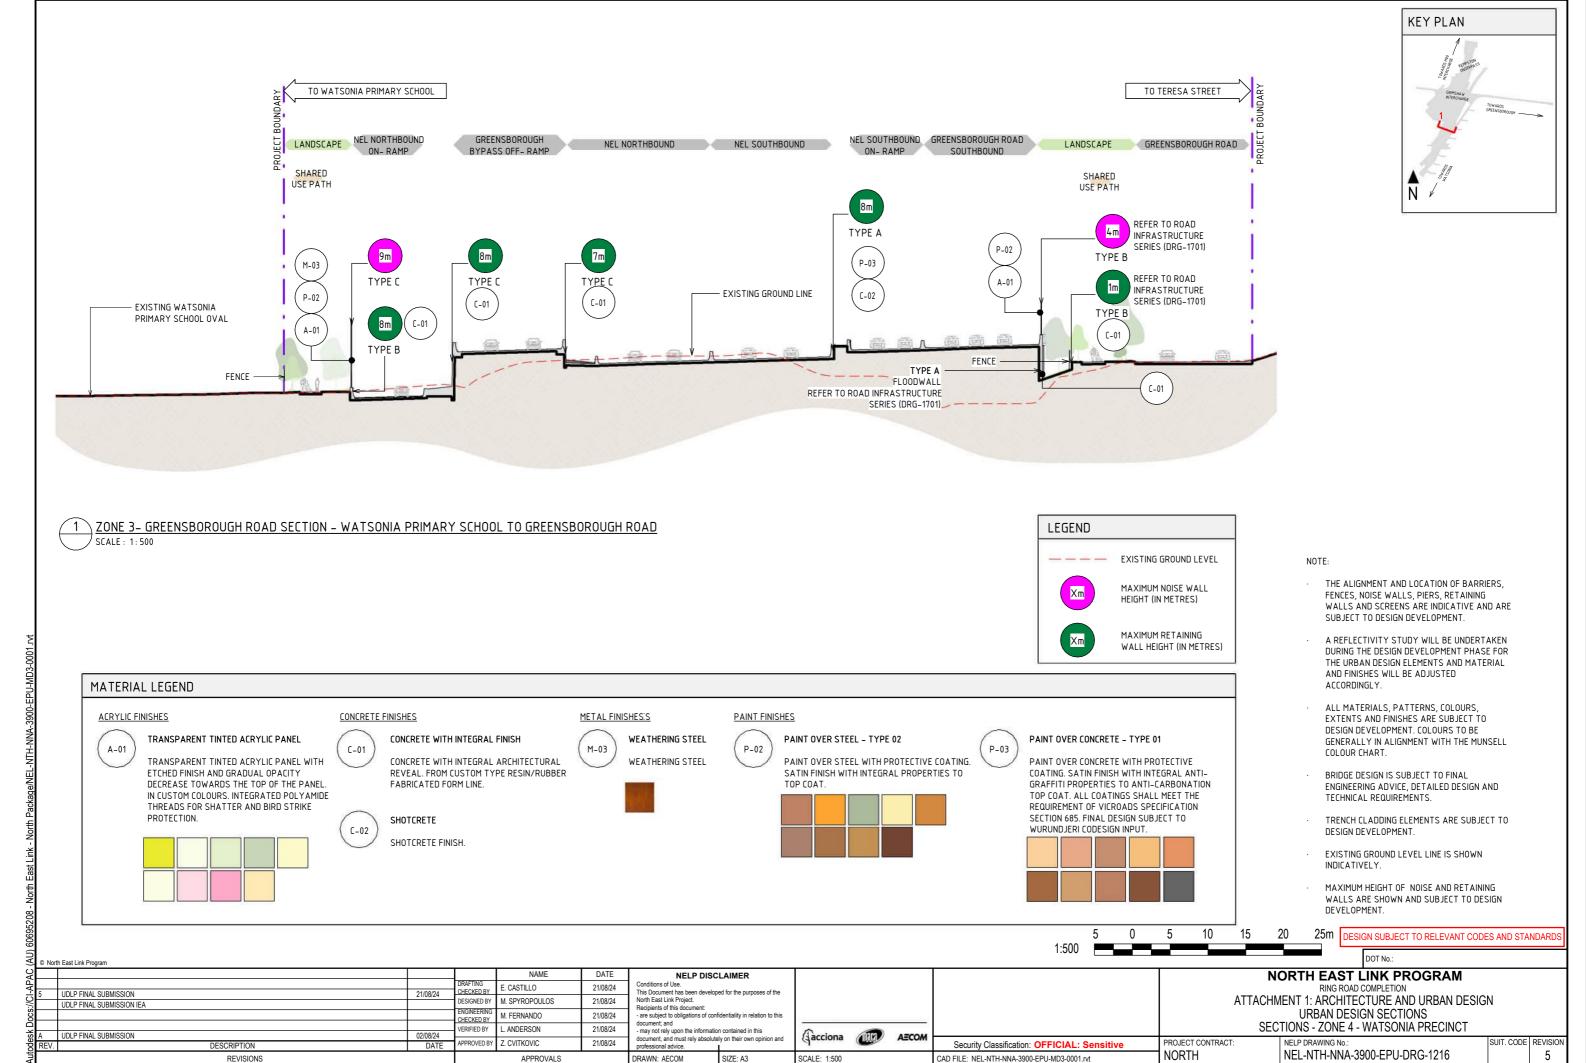
PROJECT CONTRACT NORTH

NELP DRAWING No.

SUIT. CODE REVISION 5








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NEL-NTH-NNA-3900-EPU-DRG-1251

NORTH
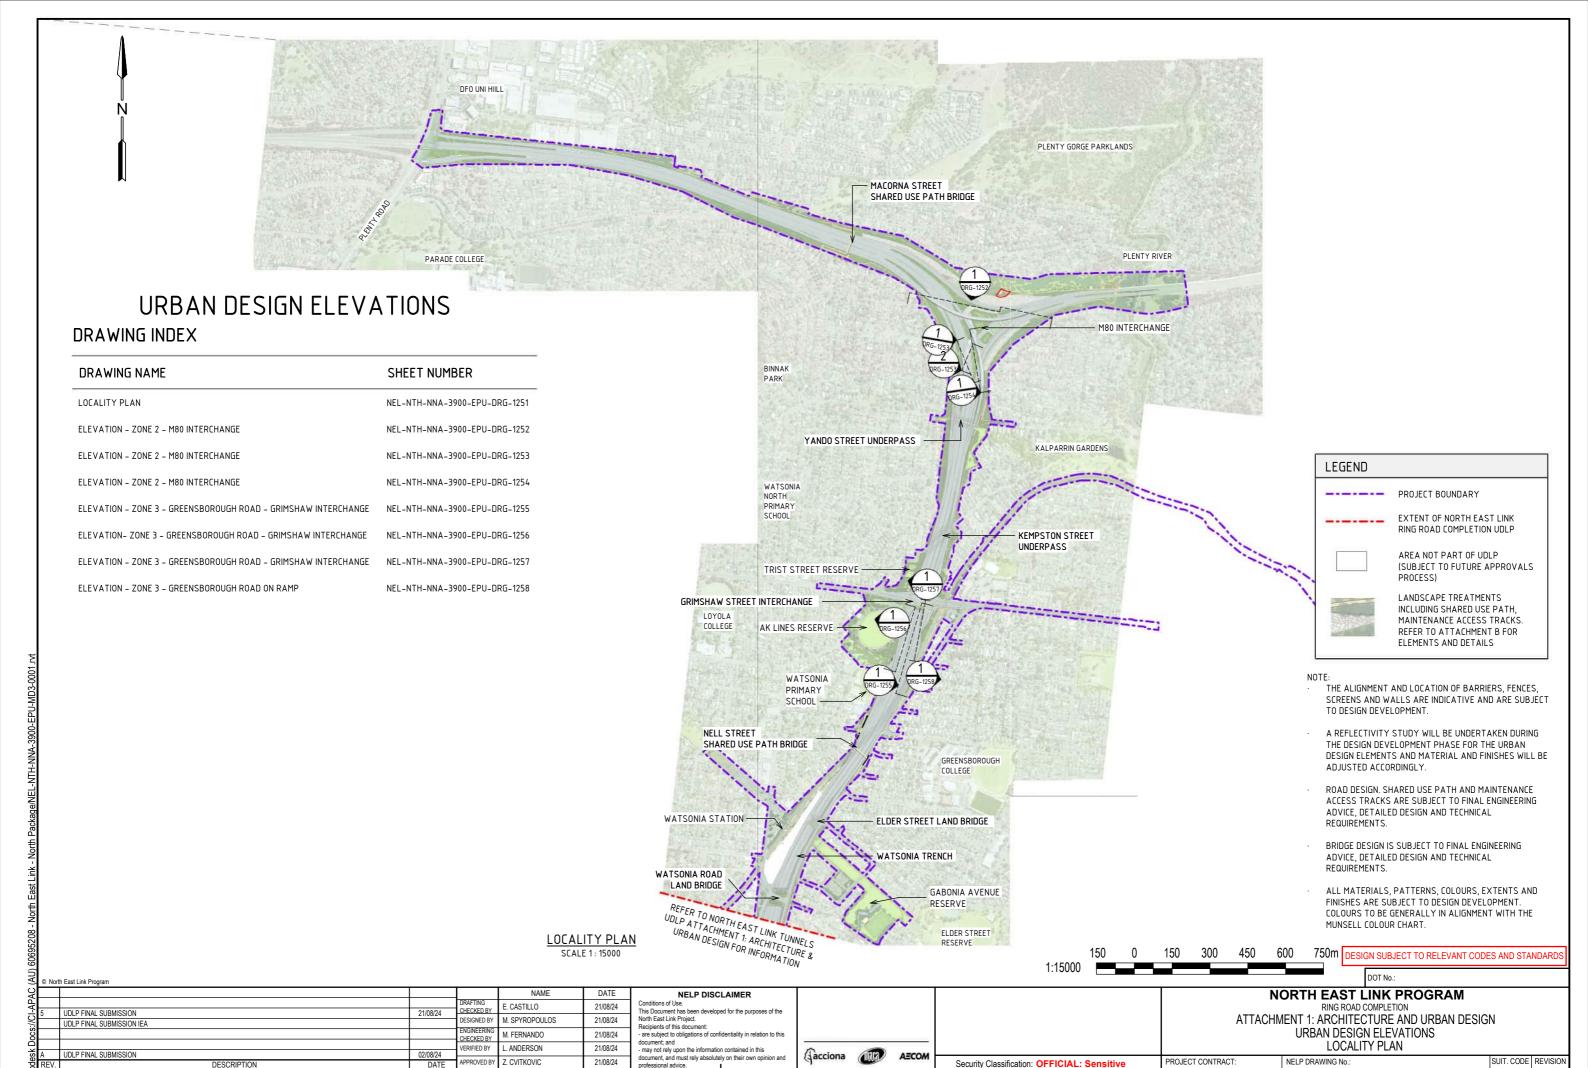
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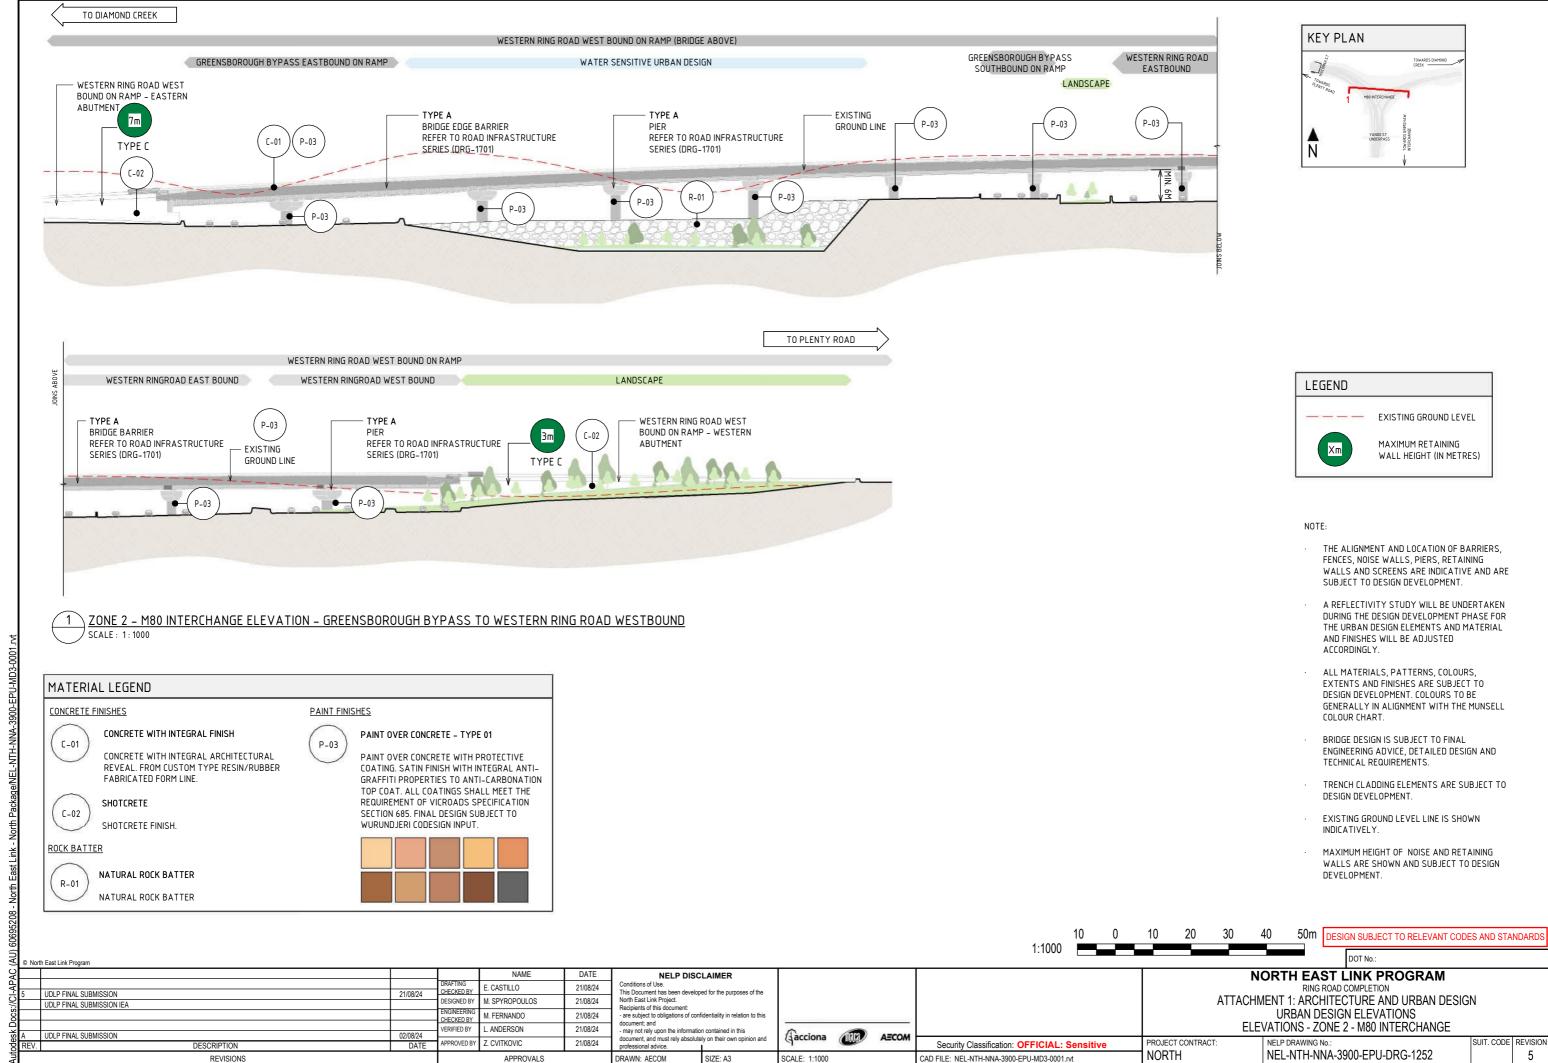
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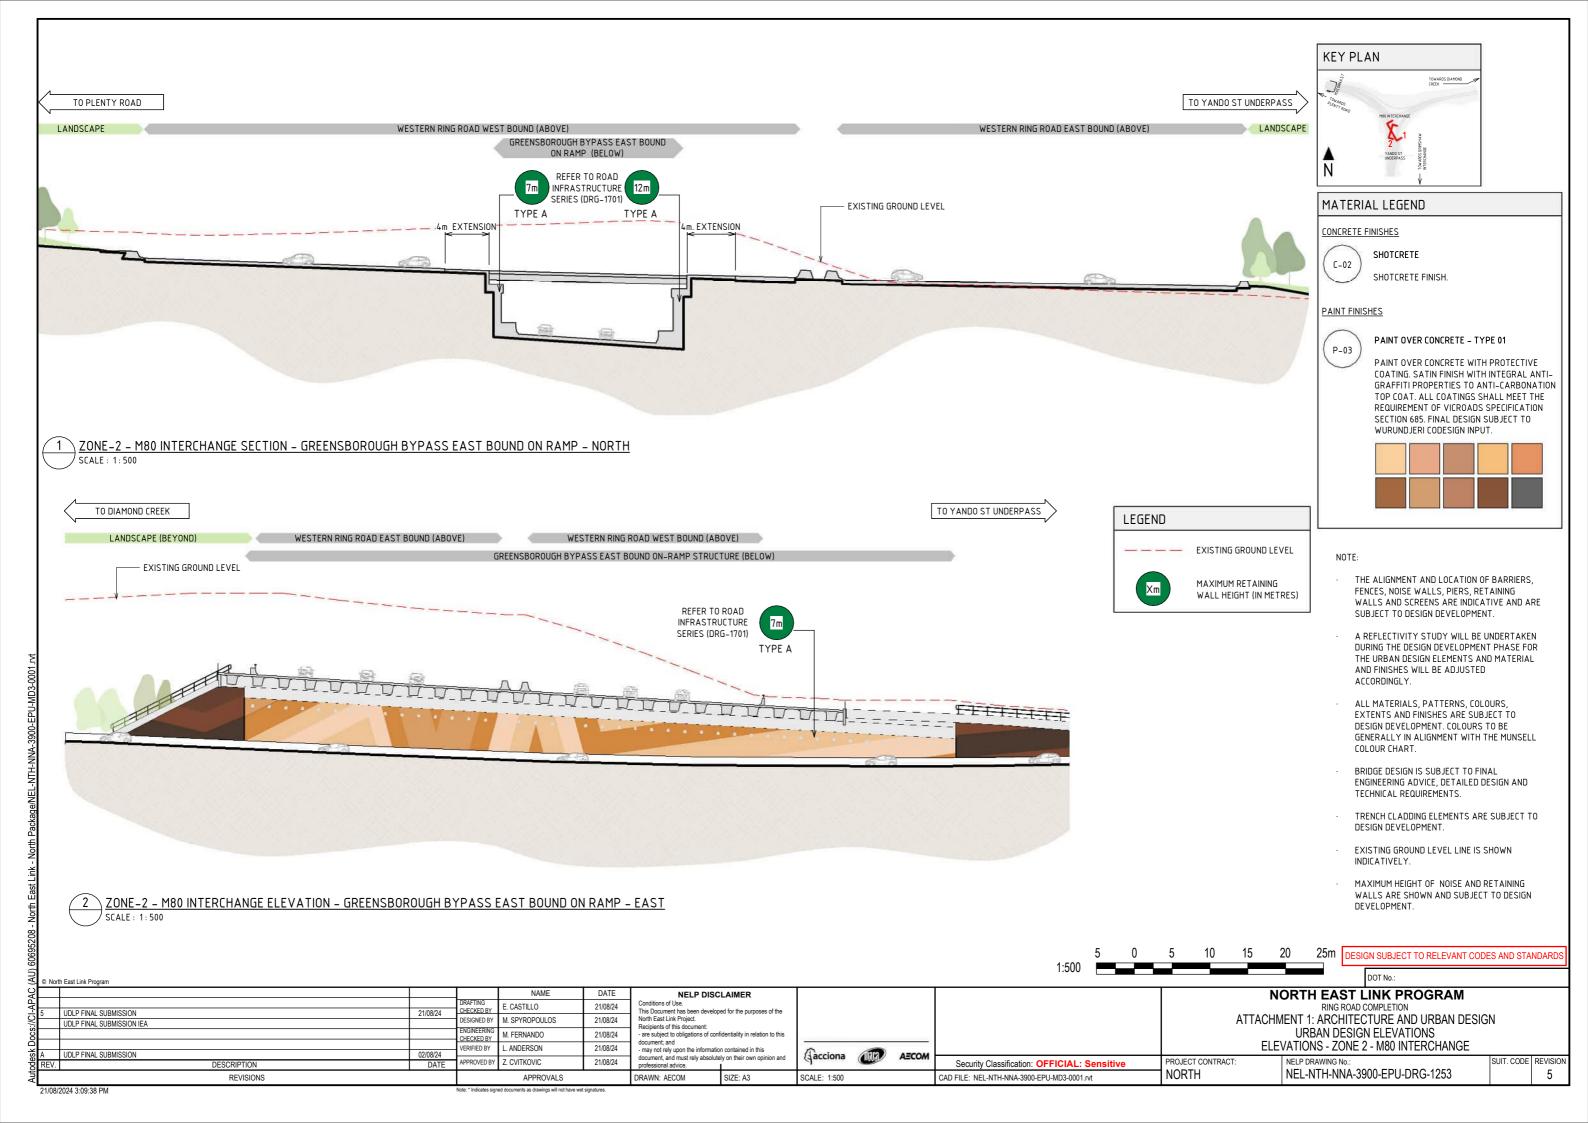
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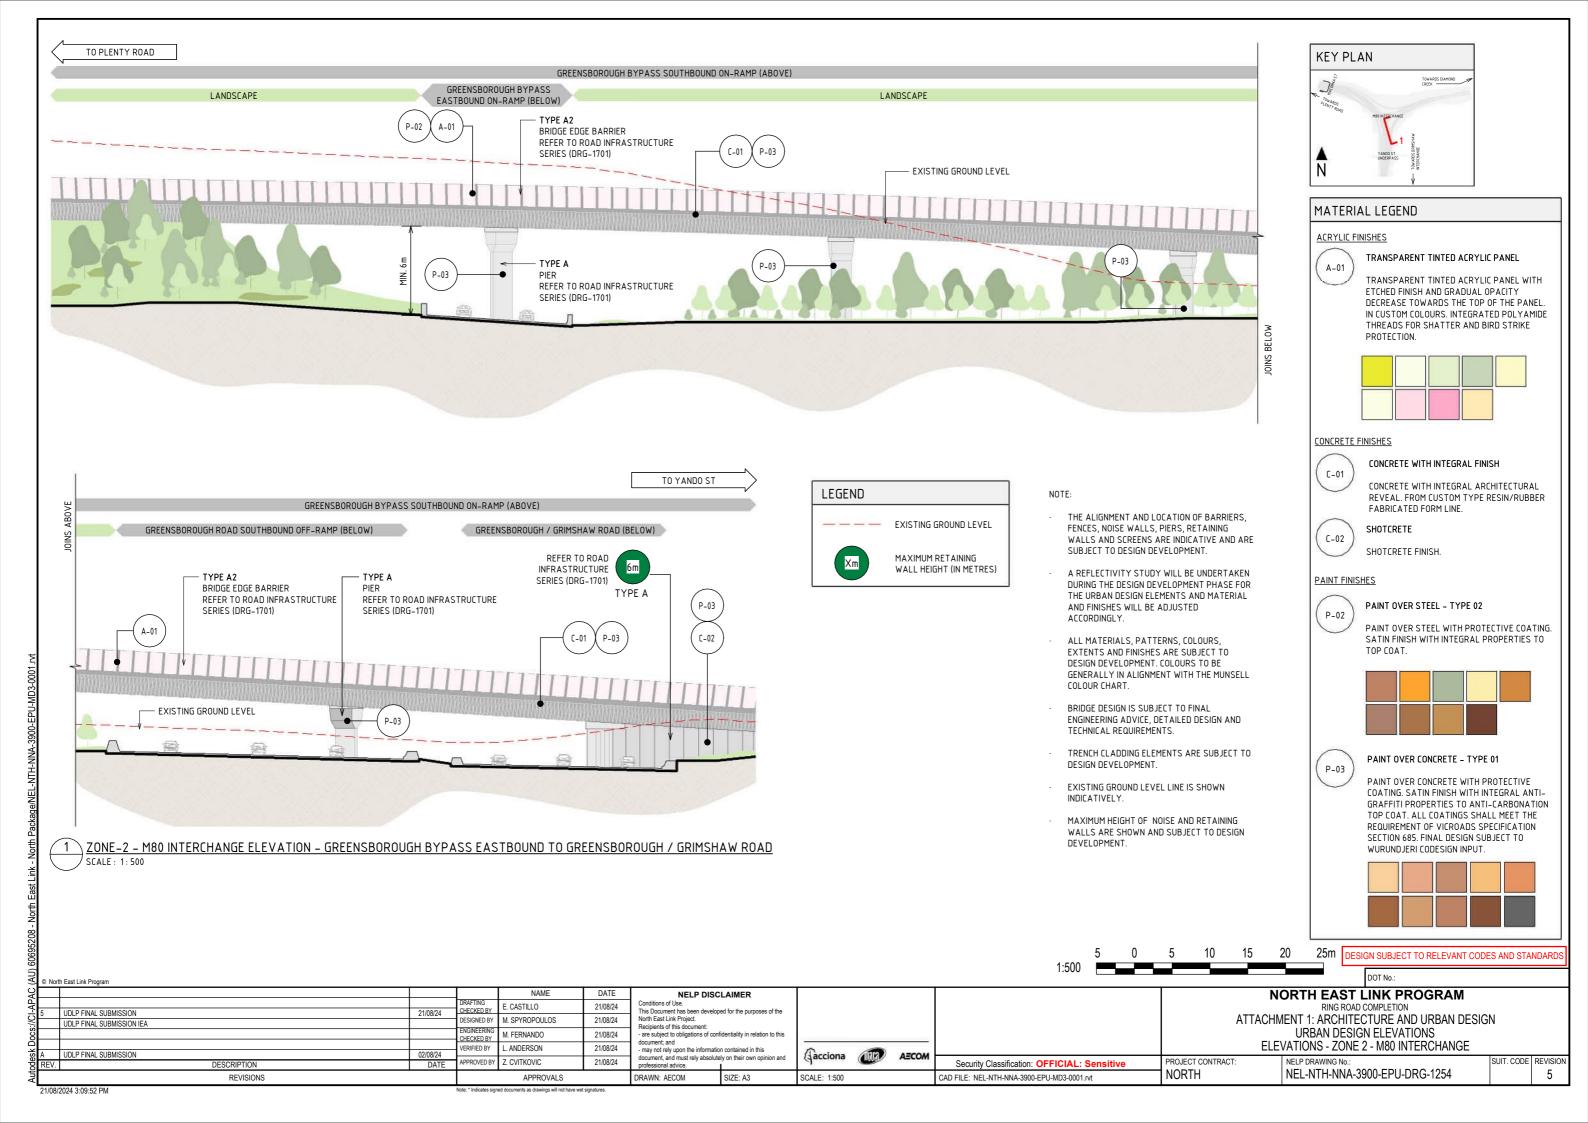
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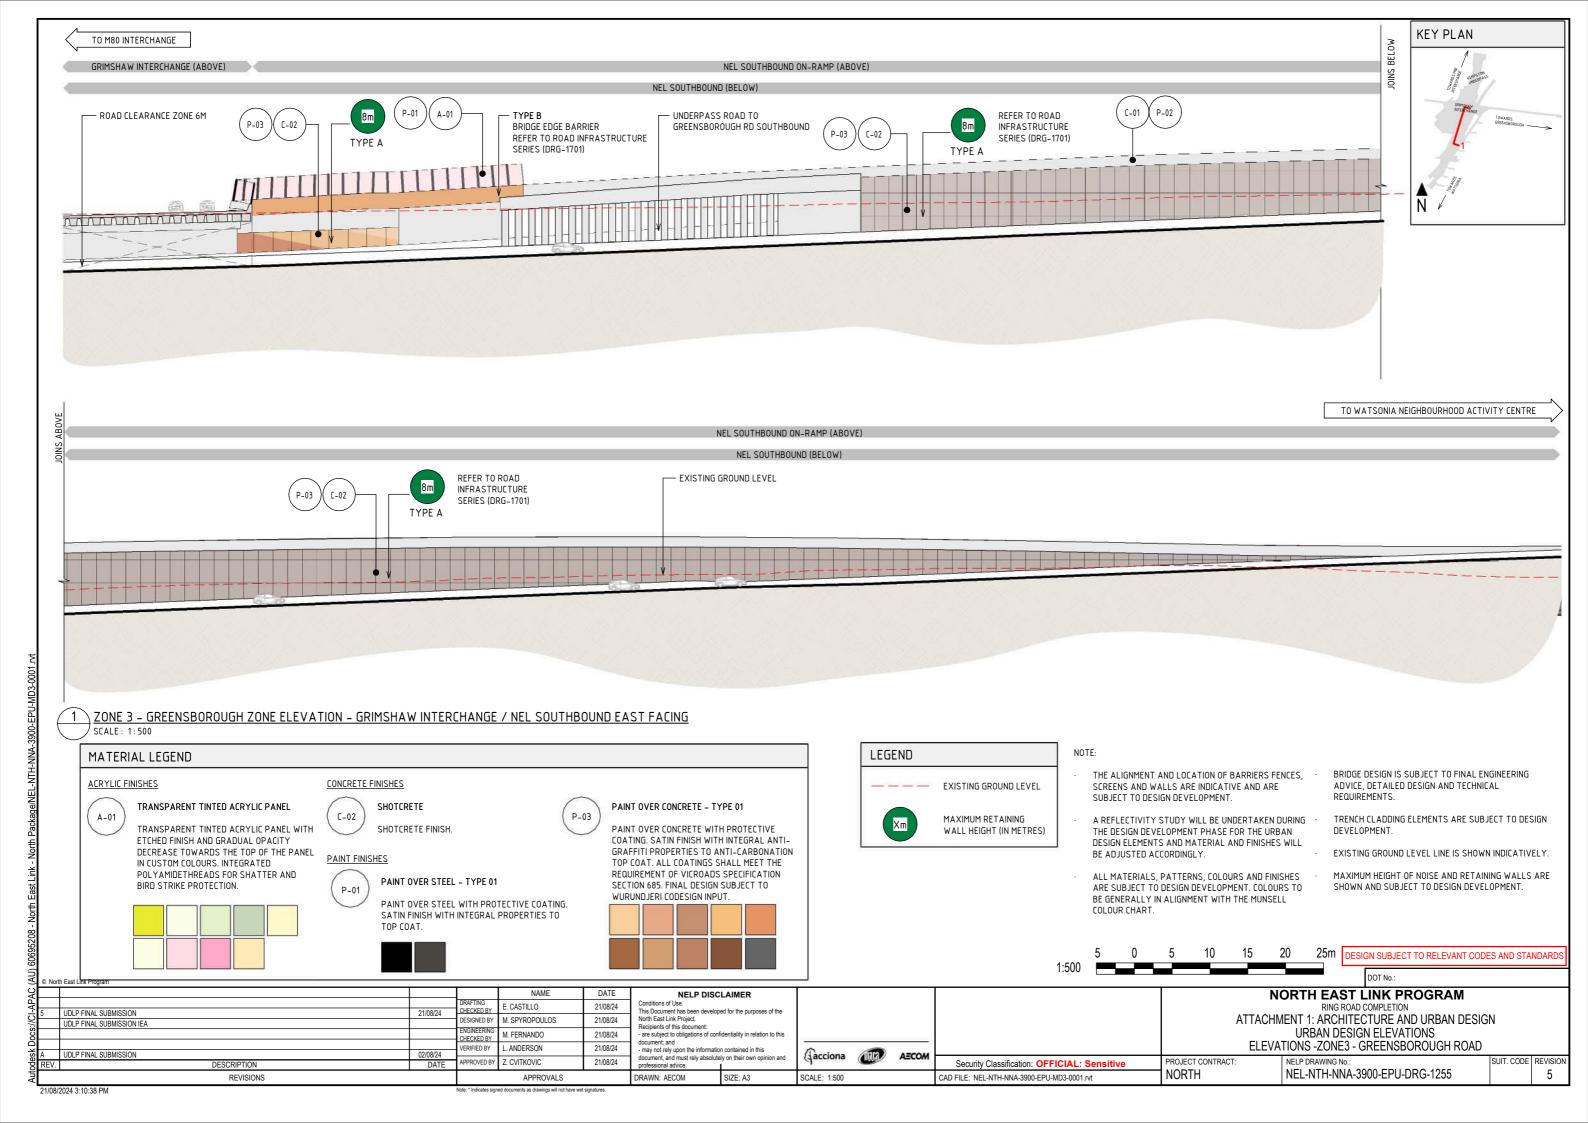



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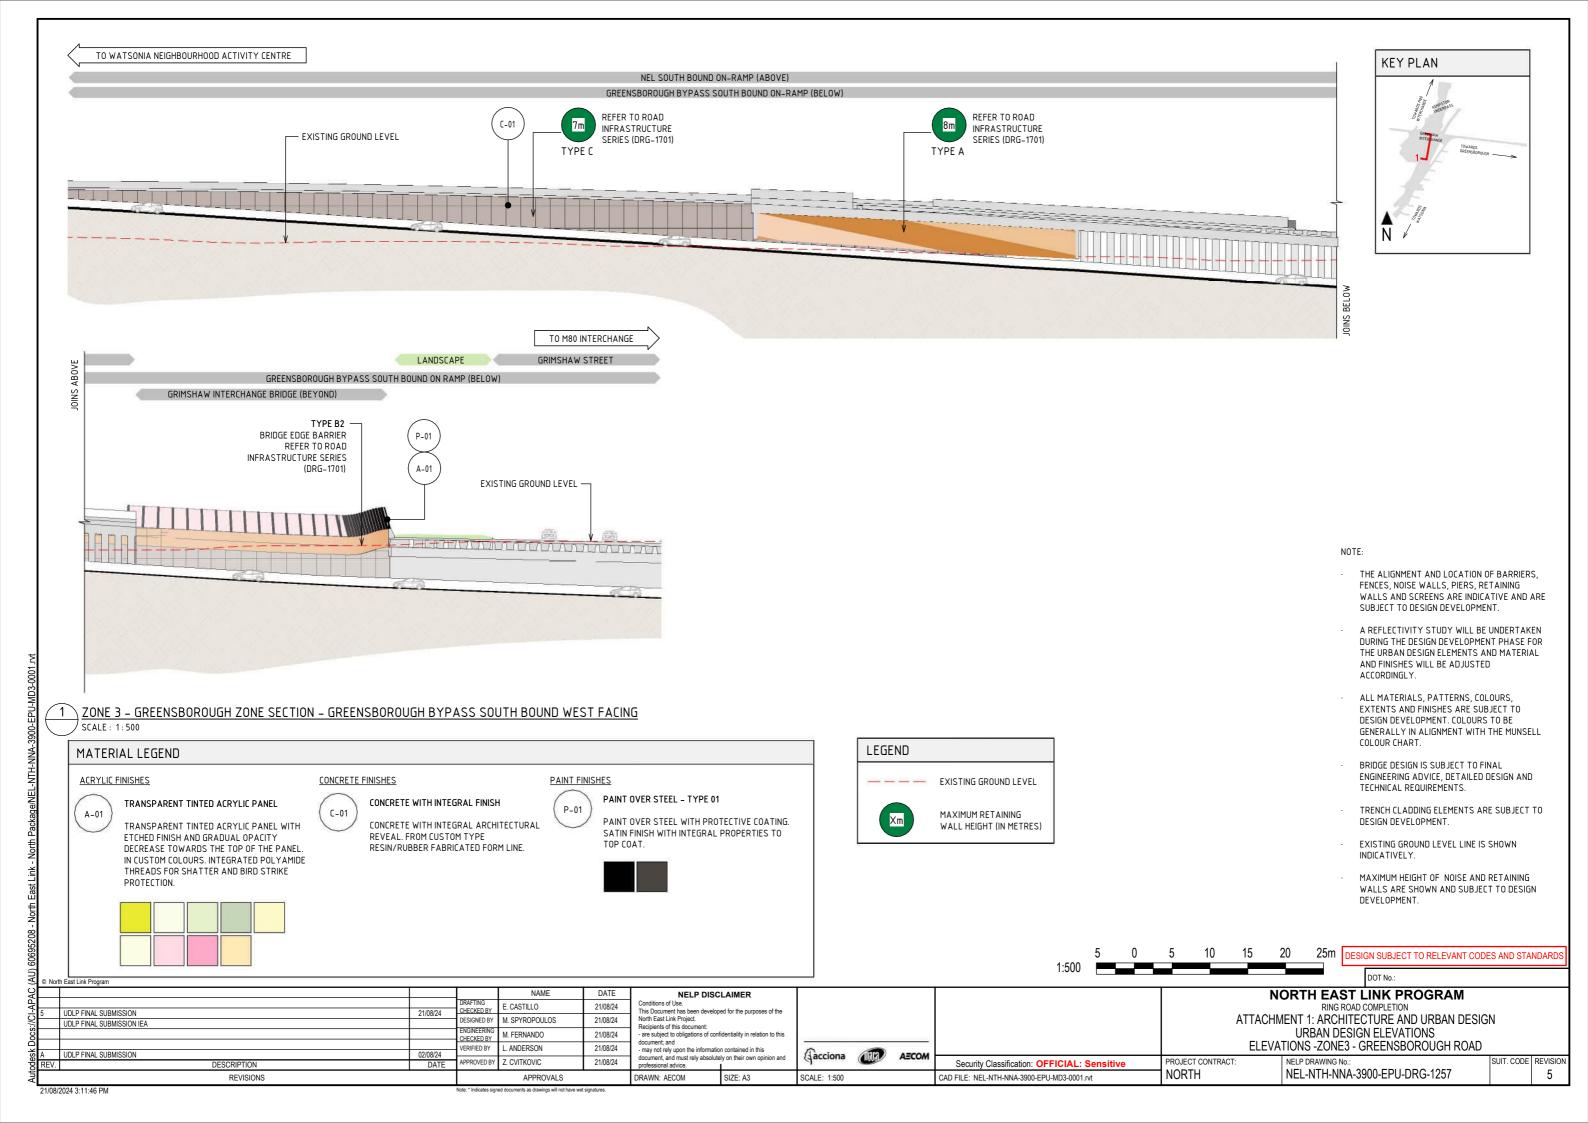
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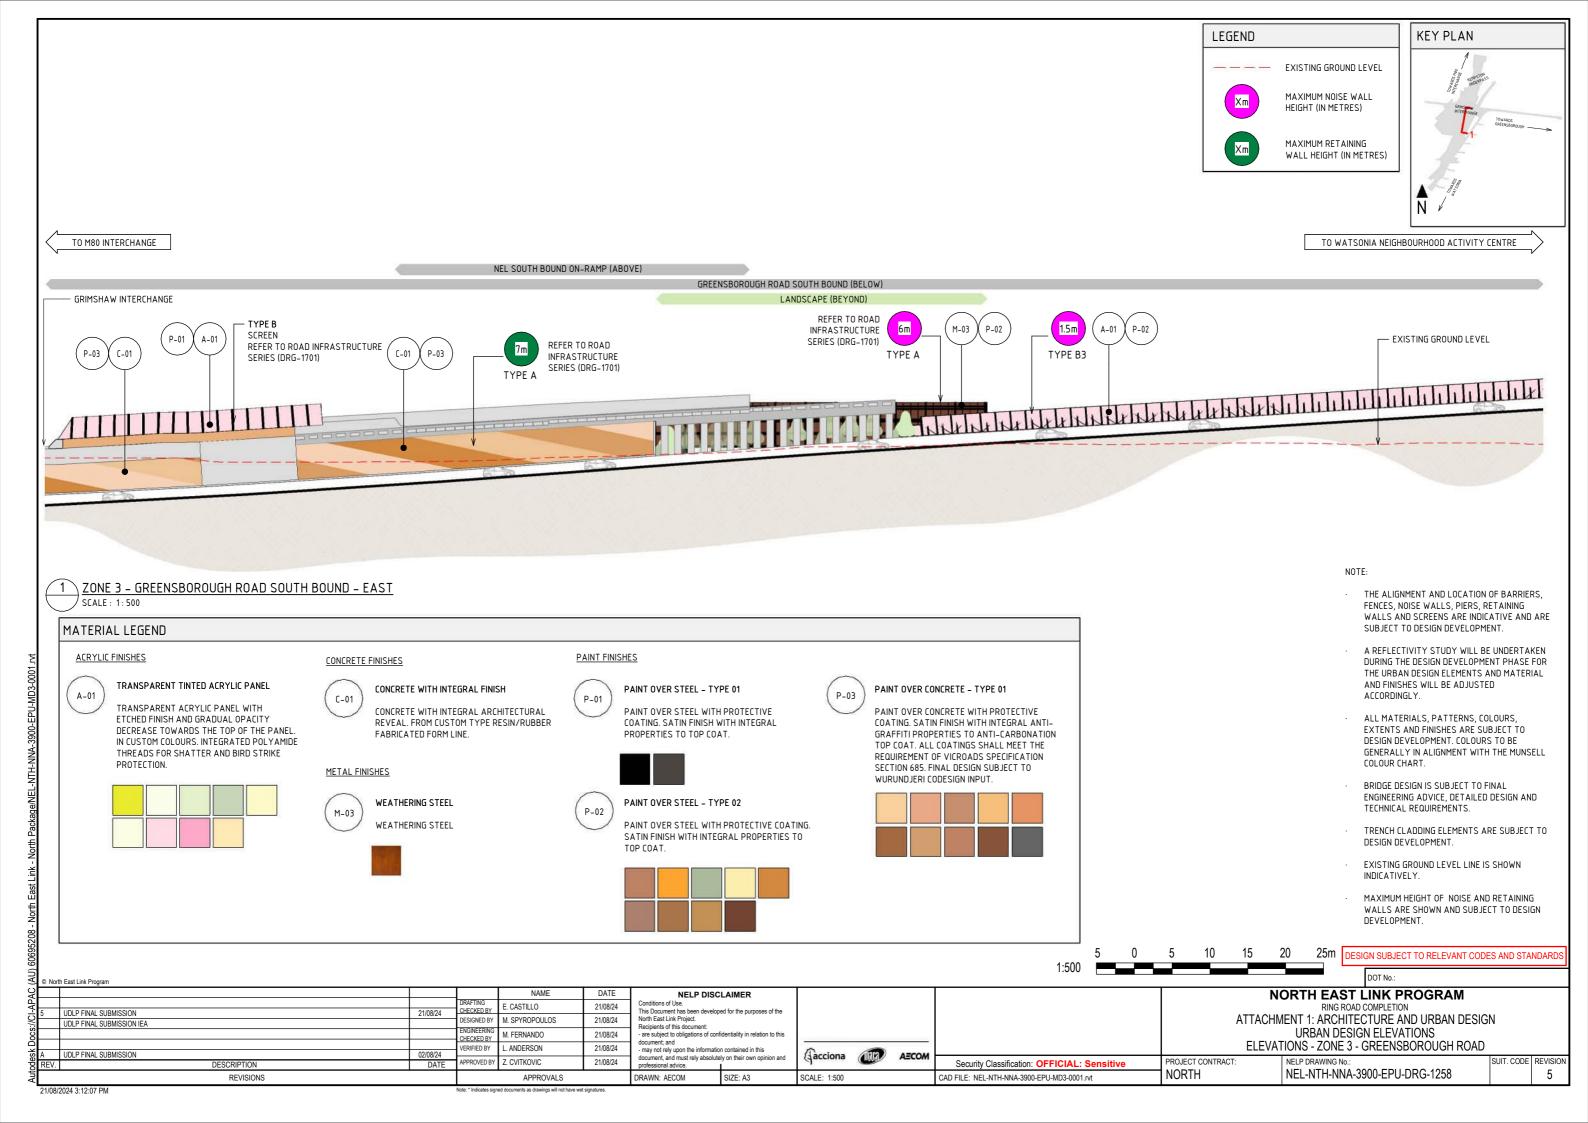











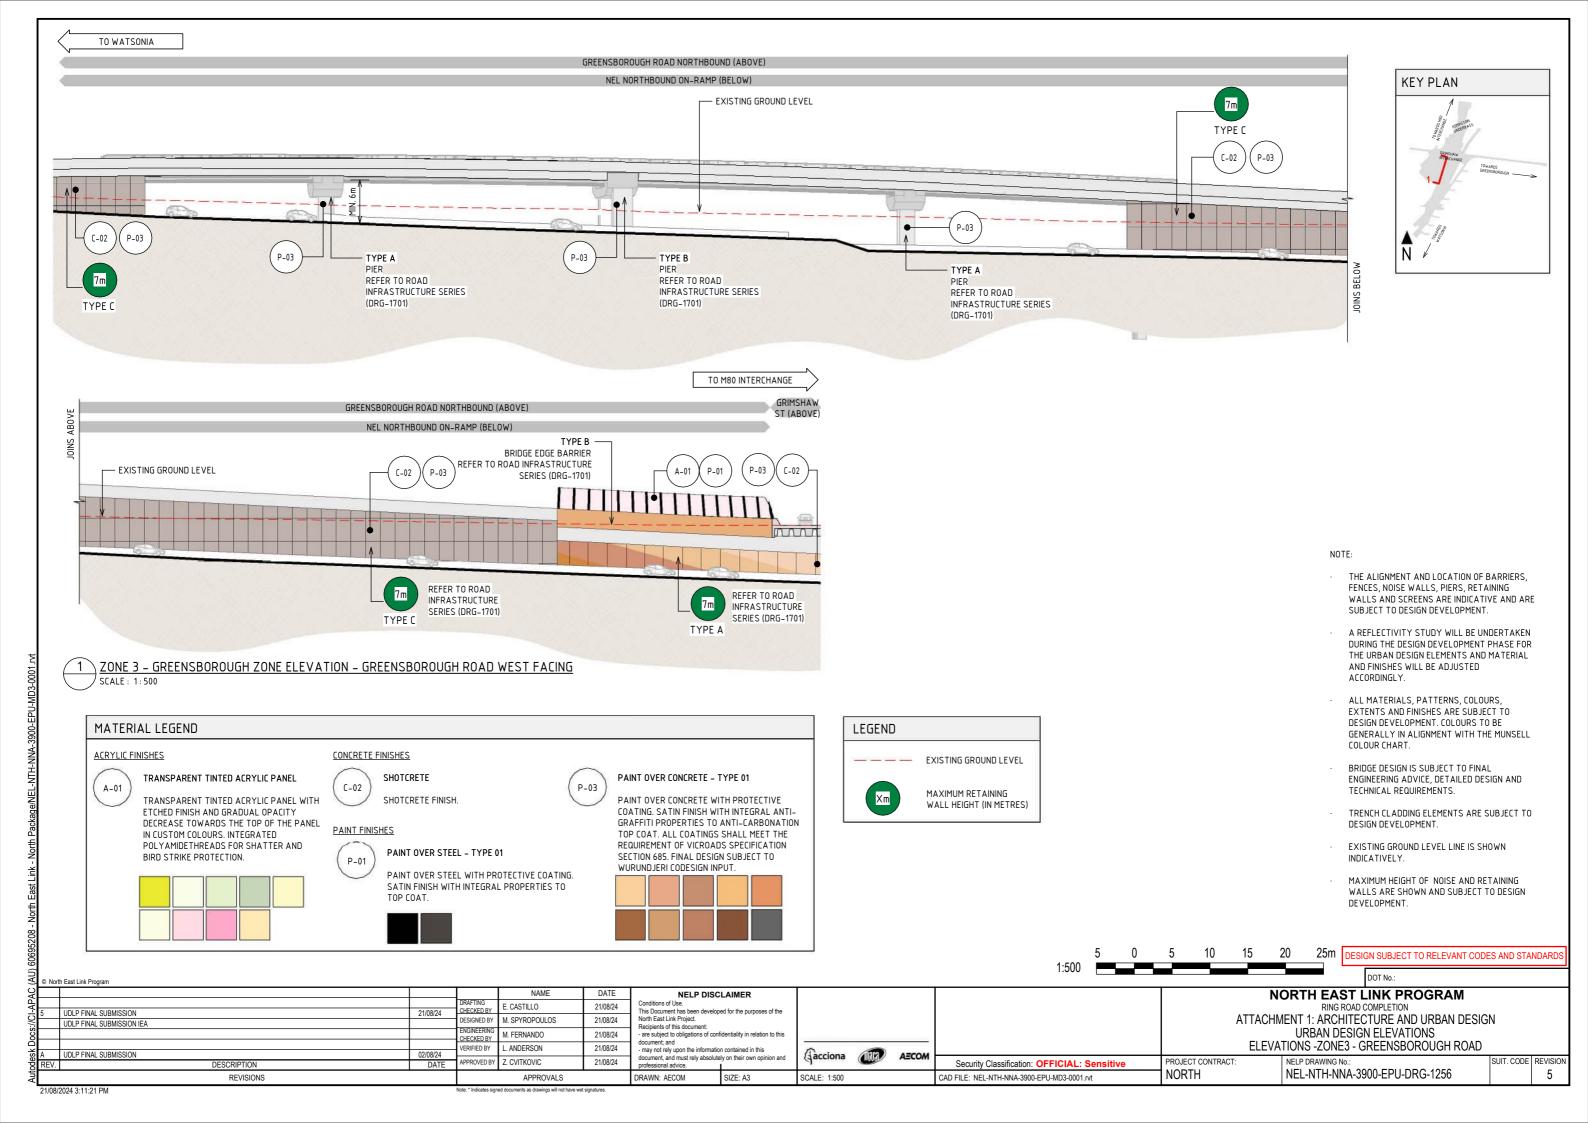

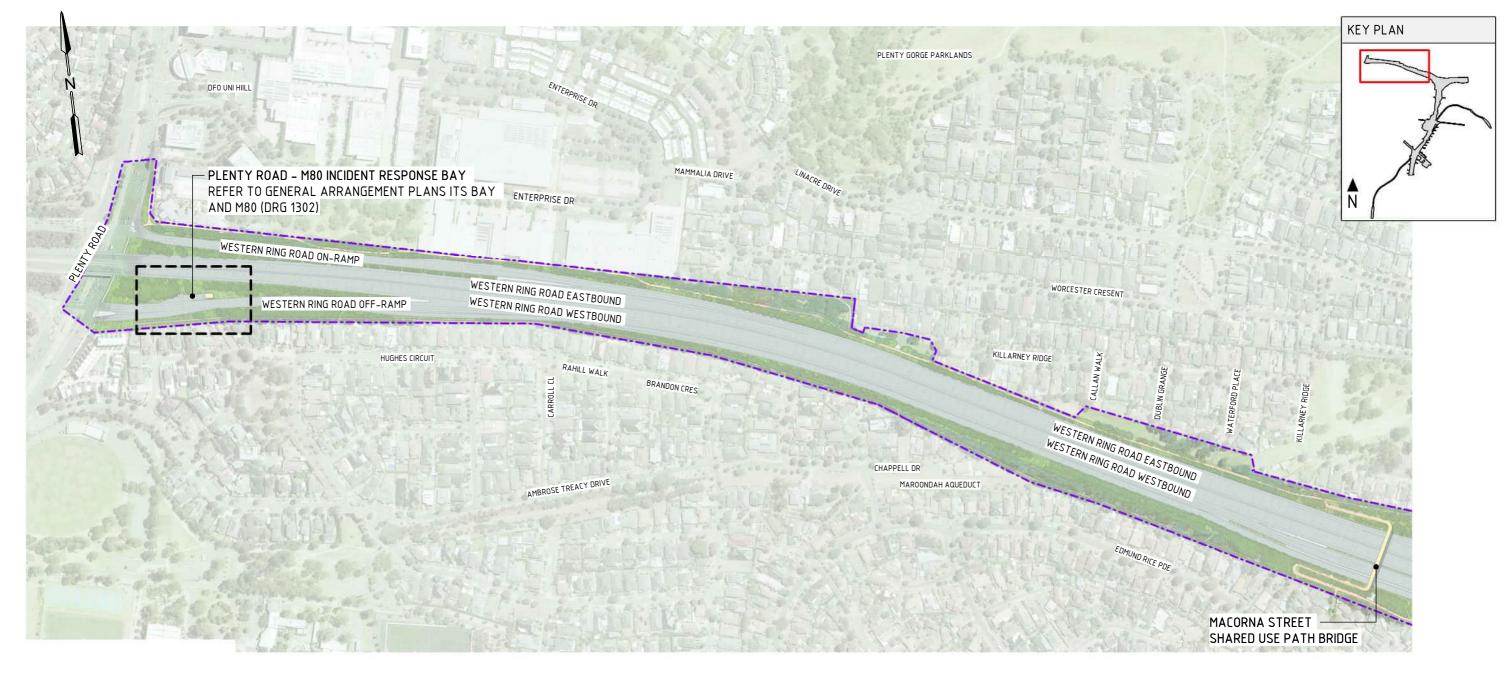

ZONE 1 M80 RING ROAD

LOCALITY PLAN

DRAWING INDEX

GENERAL ARRANGEMENT PLANS - ITS BAY AND M80

DRAWING NAME SHEET NUMBER

LOCALITY PLAN NEL-NTH-NNA-3900-EPU-DRG-1301

LEGEND

PROJECT BOUNDARY

LANDSCAPE TREATMENTS
INCLUDING SHARED USE
PATH, MAINTENANCE ACCESS
TRACKS.
REFER TO ATTACHMENT B
FOR ELEMENTS AND DETAILS

DRAWN: AECOM

SIZE: A3

NOTE

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NORTH

- BRIDGE DESIGN IS SUBJECT TO FINAL ENGINEERING ADVICE, DETAILED DESIGN AND TECHNICAL REQUIREMENTS.
- FOR DETAIL OF THE LANDSCAPE DESIGN, PLEASE REFER TO ATTACHMENT 2 LANDSCAPE DESIGN
- FOR DESIGN VISUALISATIONS, PLEASE REFER TO ATTACHMENT 3 URBAN DESIGN VISUALISATIONS
- FOR DETAILS ON THE OVERSHADOWING AND OVERLOOKING, PLEASE REFER TO ATTACHMENT 4 URBAN DESIGN OVERSHADWOING AND OVERLOOKING ASSESSMENT

1:5000 50 100 150 200 250m DESIGN SUBJECT TO RELEVANT CODES AND STANDARDS

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SCALE: 1:5000


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NORTH EAST LINK PROGRAM
RING ROAD COMPLETION
ATTACHMENT 1: ARCHITECTURE AND URBAN DESIGN
ZONE 1 M80 RING ROAD
LOCALITY PLAN

PROJECT CONTRACT: | NELP DRAWING NO: | SUIT. CODE | REVISION


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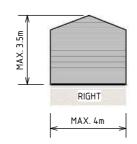
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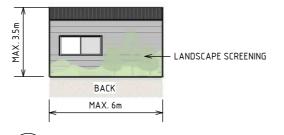
NORTH ELEVATION - INCIDENT RESPONSE SITE OFFICE SCALE: 1:200

DESCRIPTION

REVISIONS

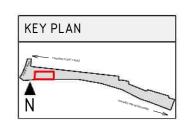


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SOUTH ELEVATION - INCIDENT RESPONSE SITE OFFICE SCALE: 1:200
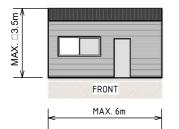
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6 8 10m 0 7.5 15 22.5 30 37.5m DESIGN SUBJECT TO RELEVANT CODES AND STANDARD

NORTH

NORTH EAST LINK PROGRAM

RING ROAD COMPLETION ATTACHMENT 1: ARCHITECTURE AND URBAN DESIGN ZONE 1 M80 RING ROAD

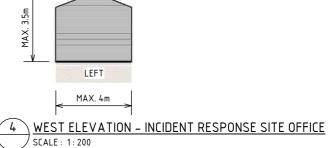PROJECT CONTRACT

GENERAL ARRANGEMENT - M80 INCIDENT RESPONSE BAY

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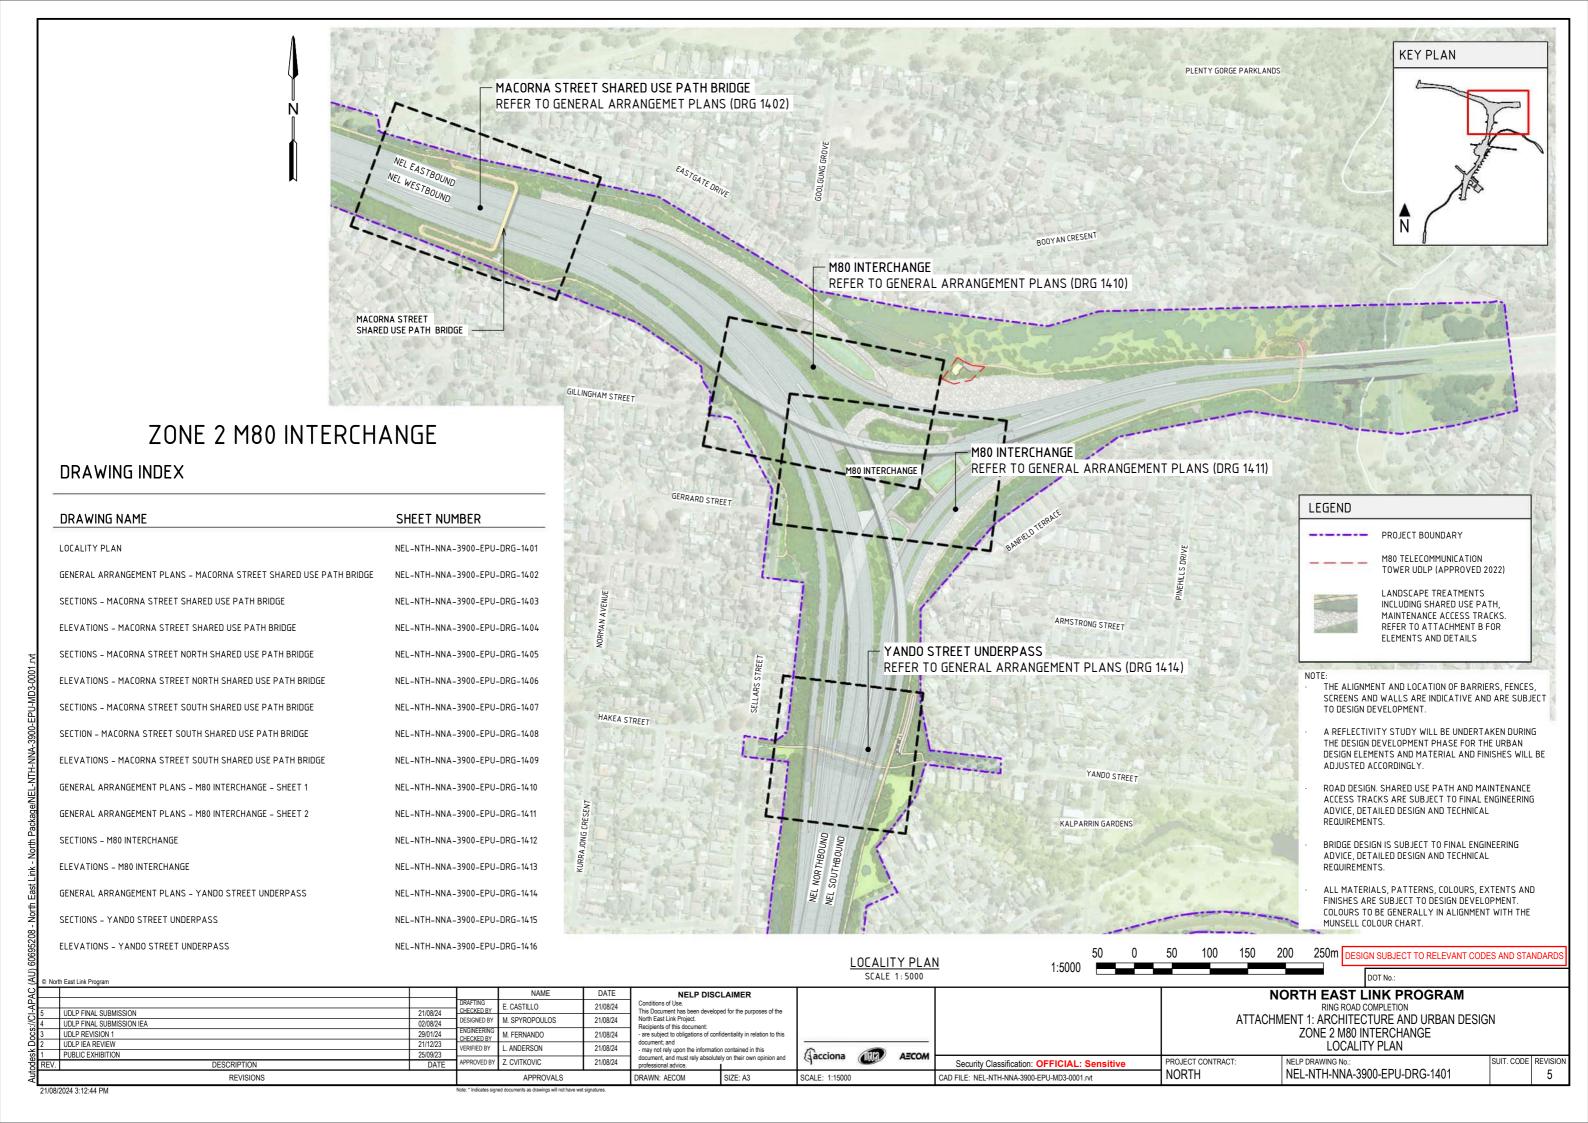
NOISE WALL LANDSCAPE TREATMENTS INCLUDING SHARED USE


PATH, MAINTENANCE ACCESS TRACKS. REFER TO ATTACHMENT B FOR ELEMENTS AND DETAILS

LEGEND


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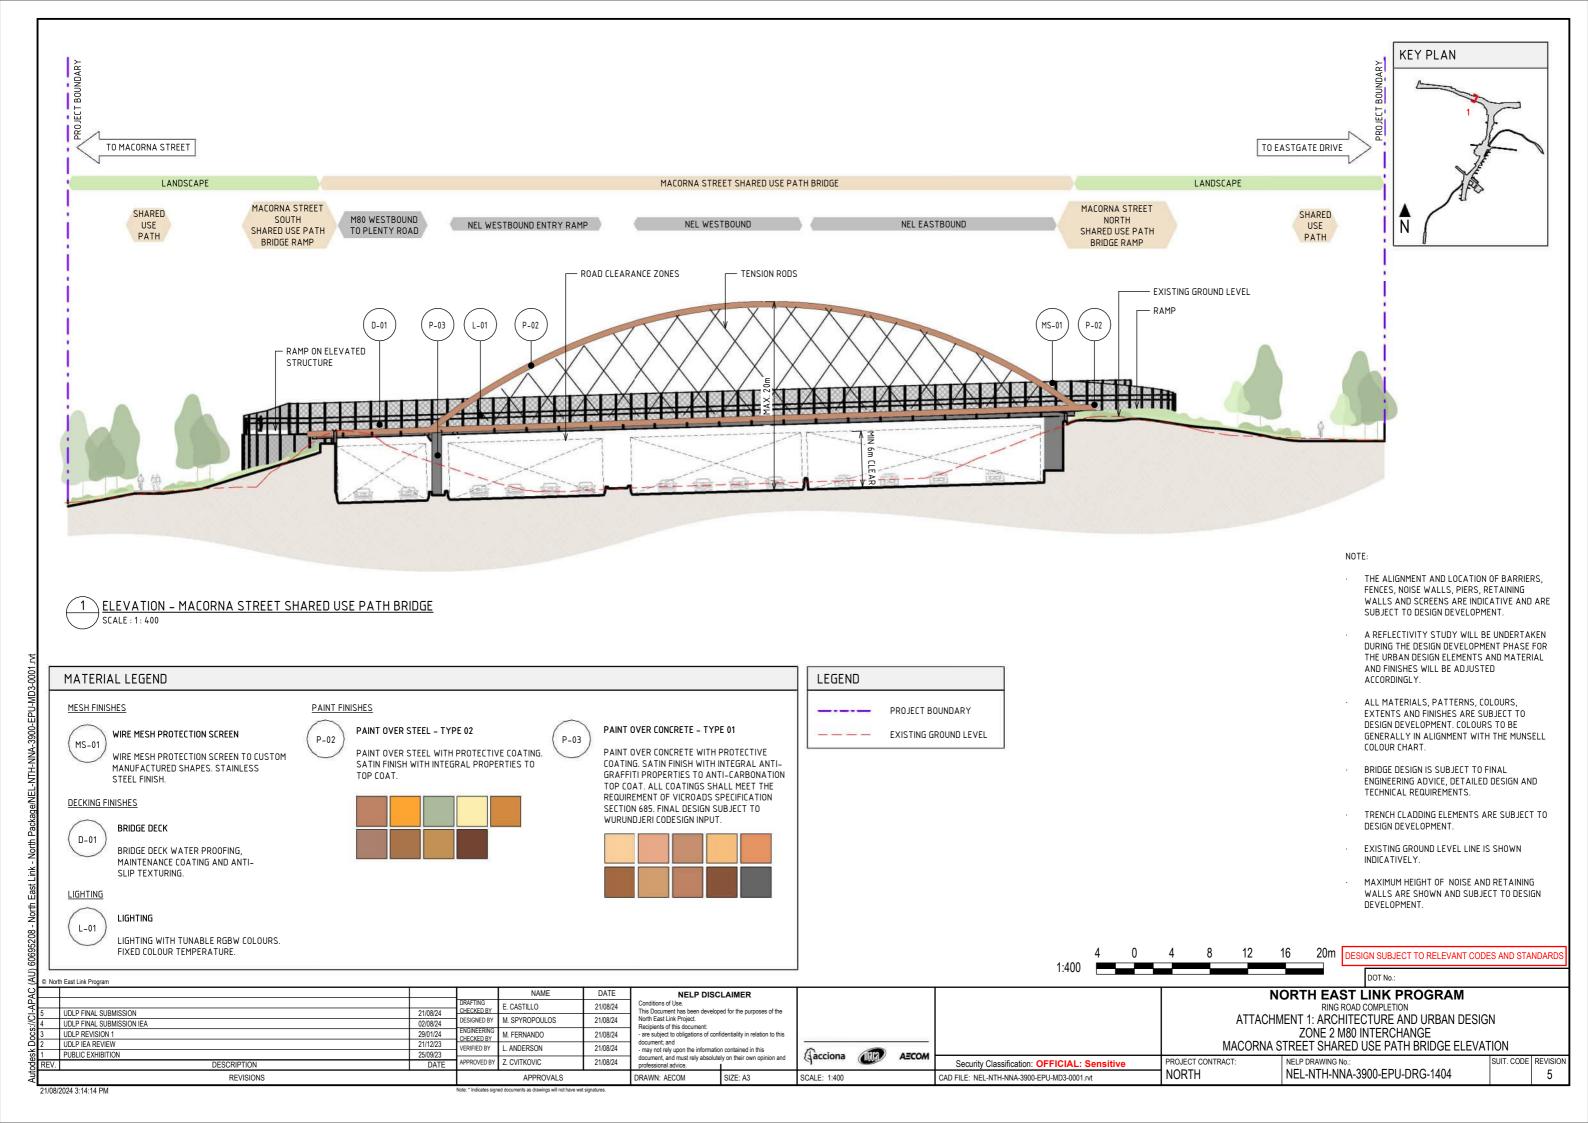
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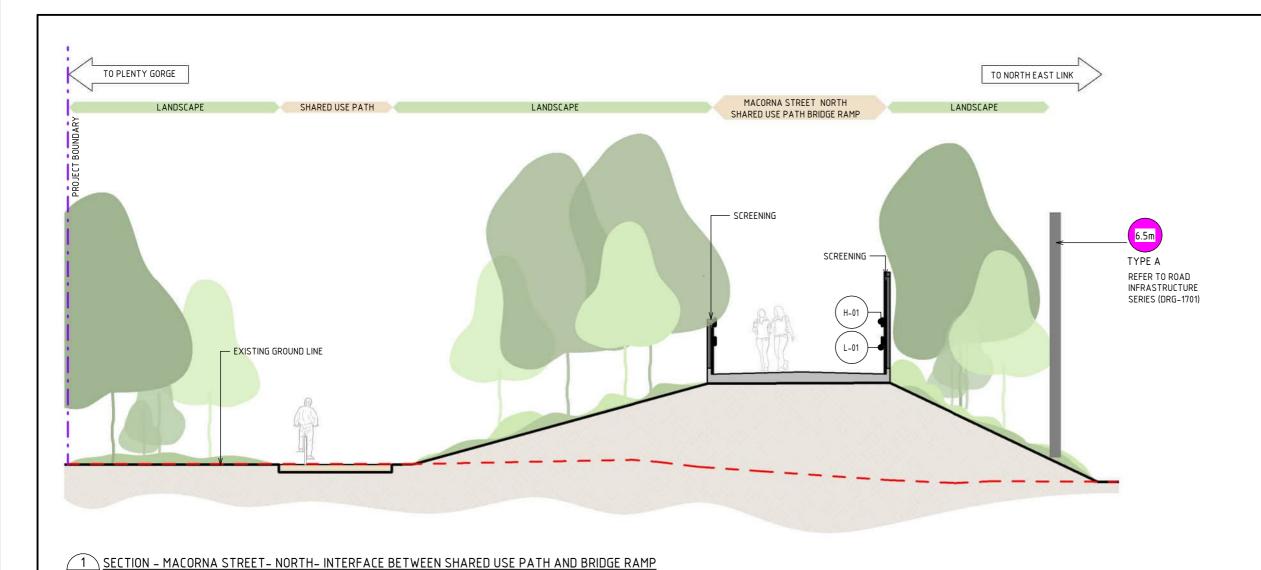




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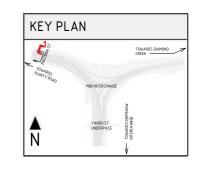
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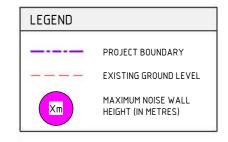
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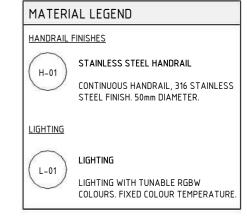
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DESIGN SUBJECT TO RELEVANT CODES AND STANDARD
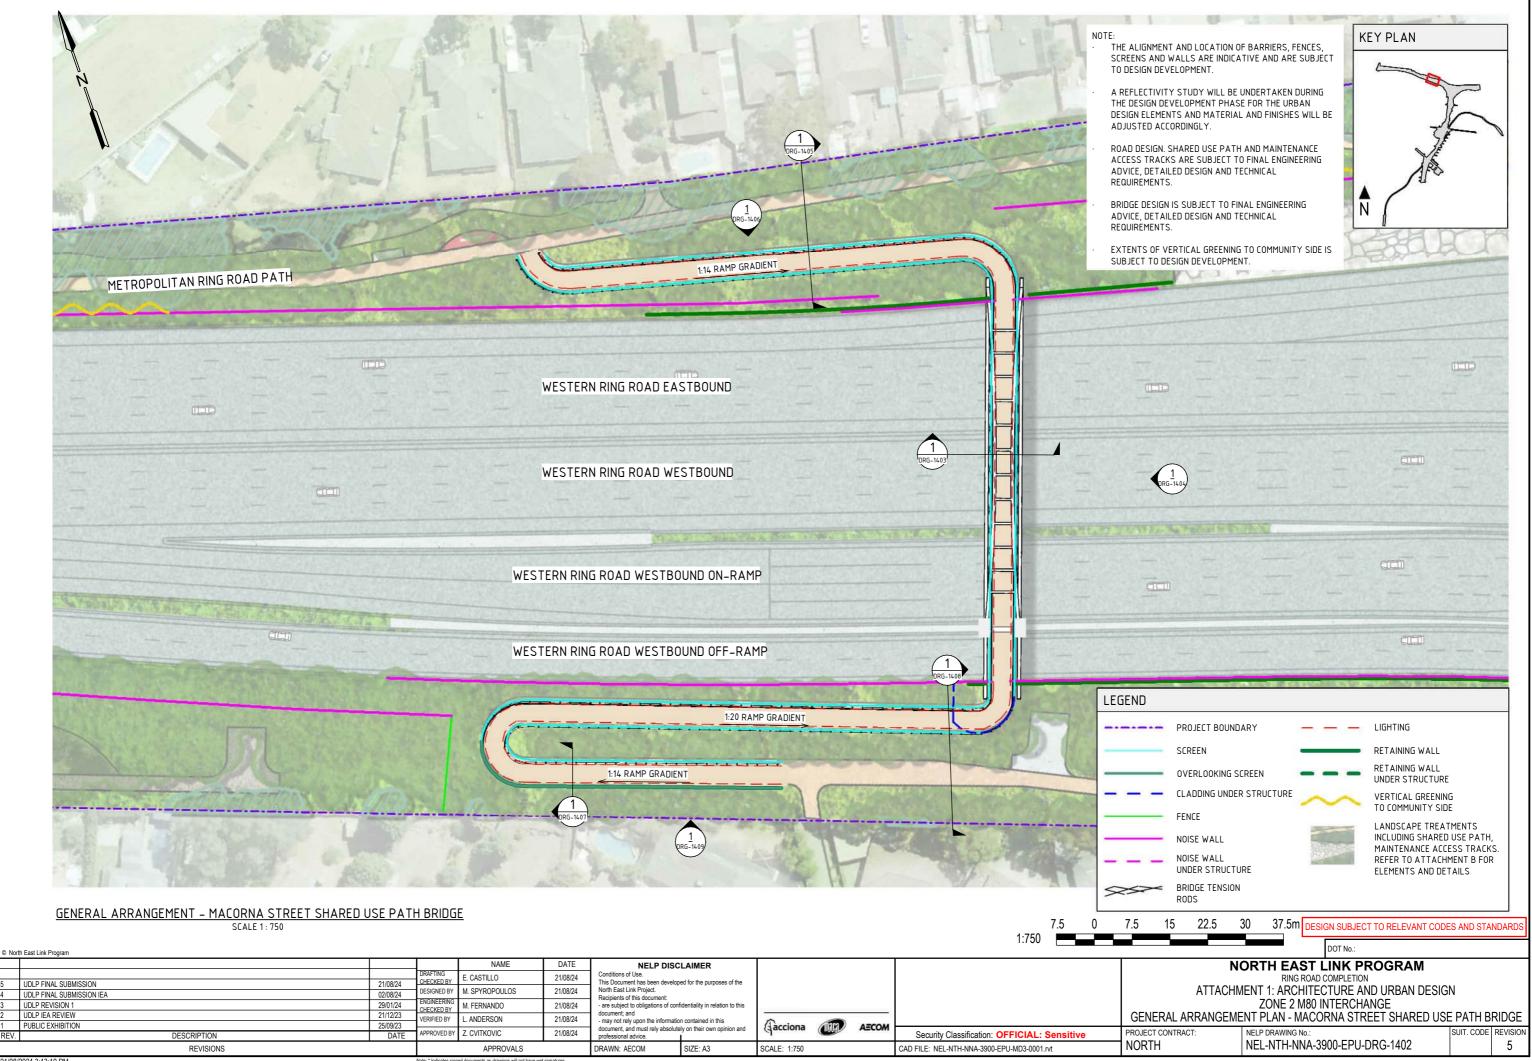
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RING ROAD COMPLETION	
TACHMENT 1: ARCHITECTURE AND URBAN DESIGN	
70NE 2 M80 INTERCHANGE	

ΑT MACORNA STREET NORTH SHARED USE PATH BRIDGE SECTION
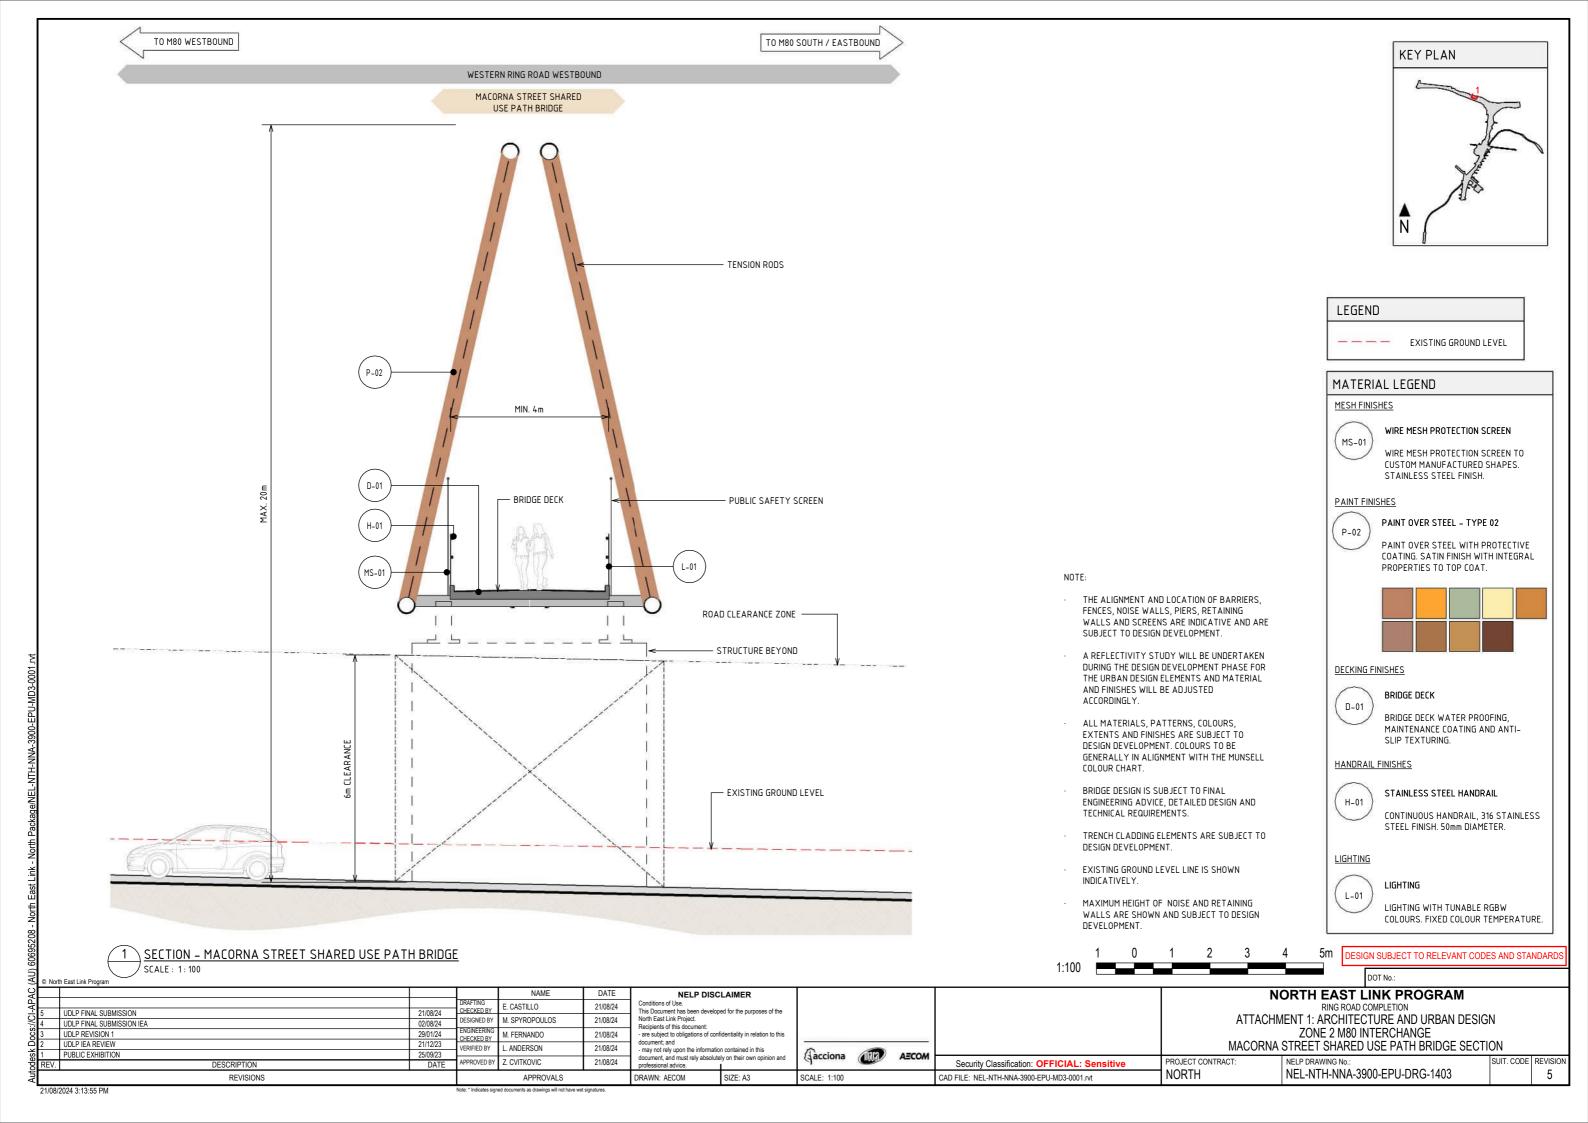
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DESCRIPTION

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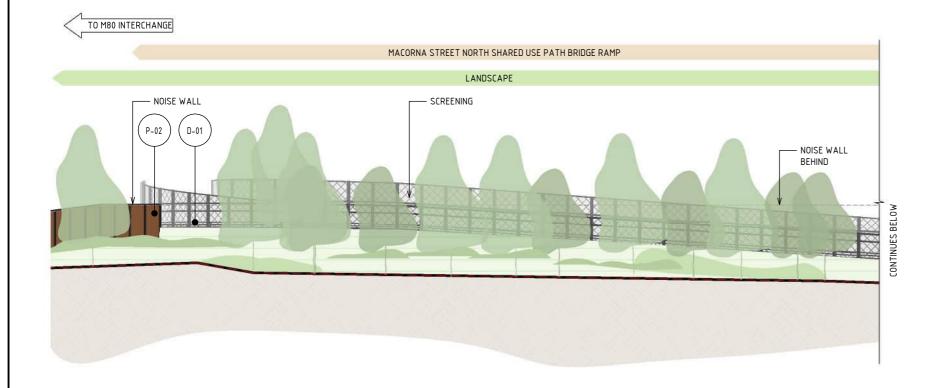
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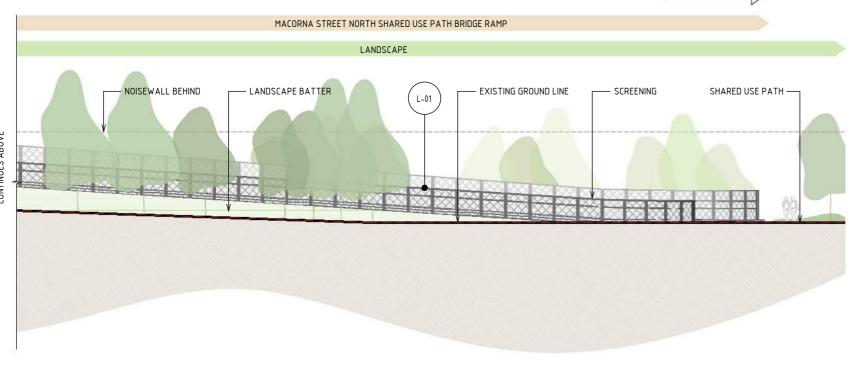
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PROJECT CONTRACT NORTH

NELP DRAWING No.: NEL-NTH-NNA-3900-EPU-DRG-1405 SUIT, CODE REVISION 5





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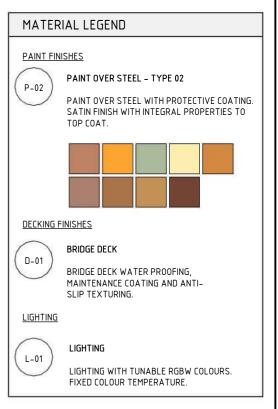
\ ELEVATION – MACORNA STREET– NORTH– INTERFACE BETWEEN SHARED USE PATH AND BRIDGE SCALE: 1: 250



NOTE:

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12.5m DESIGN SUBJECT TO RELEVANT CODES AND STANDAR 2.5 0 2.5 5 7.5 10 1:250

NORTH EAST LINK PROGRAM

RING ROAD COMPLETION ATTACHMENT 1: ARCHITECTURE AND URBAN DESIGN ZONE 2 M80 INTERCHANGE

MACORNA STREET NORTH SHARED USE PATH BRIDGE ELEVATION

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PROJECT CONTRACT NORTH

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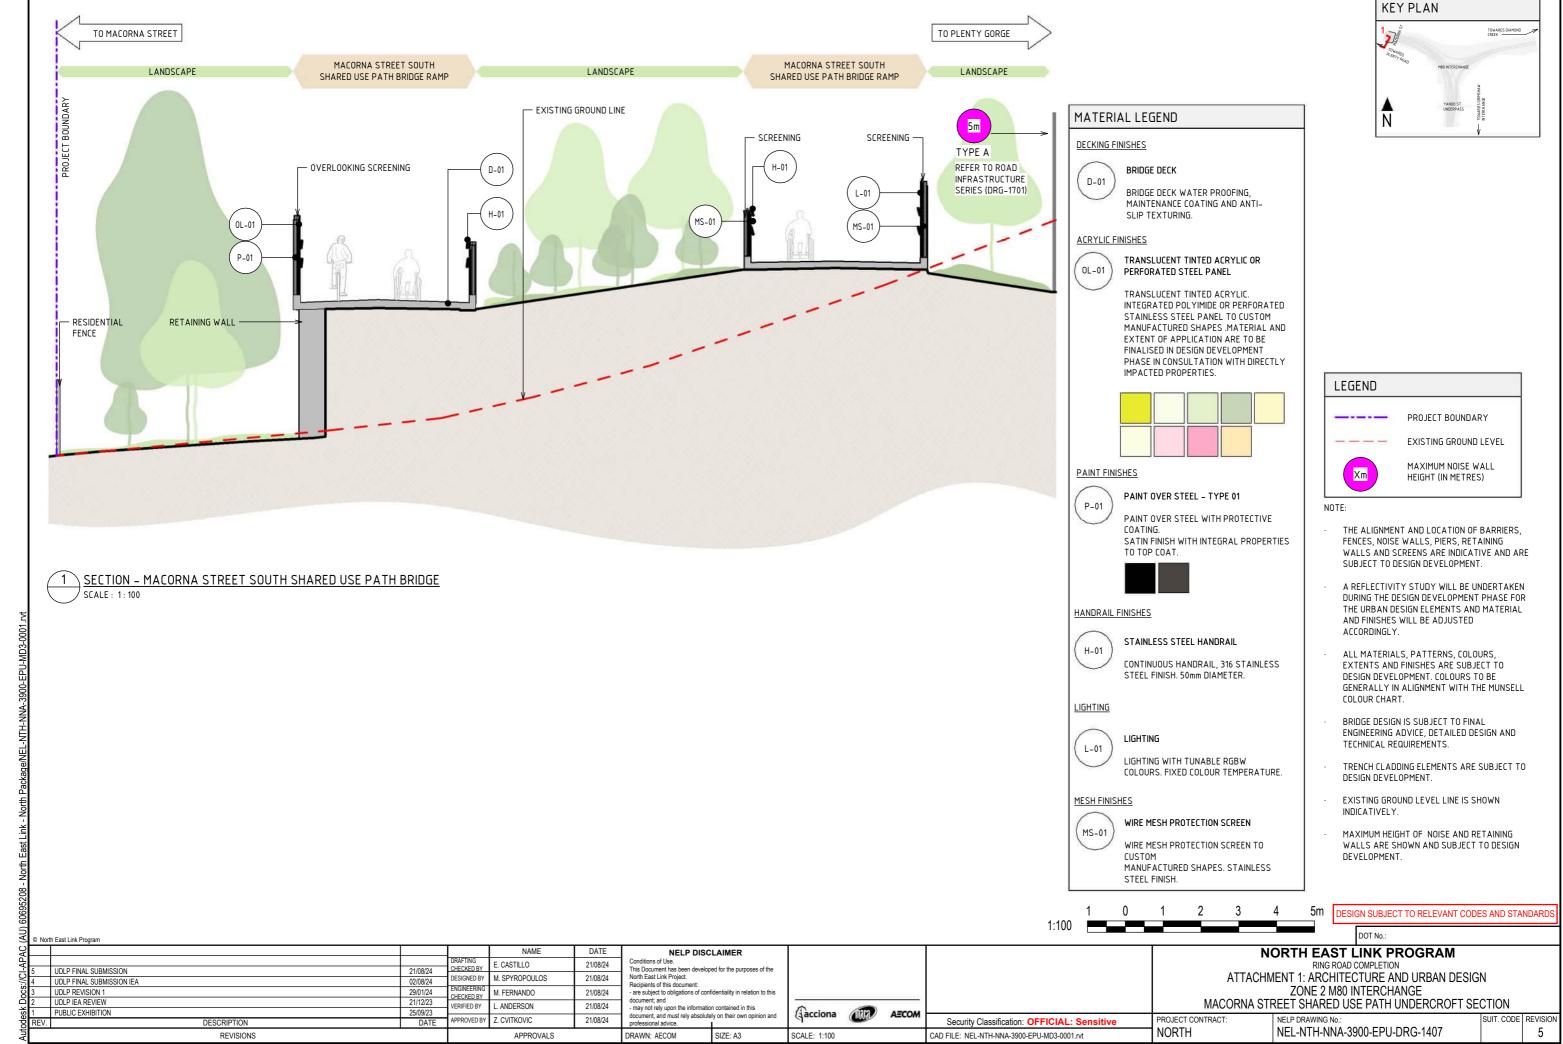
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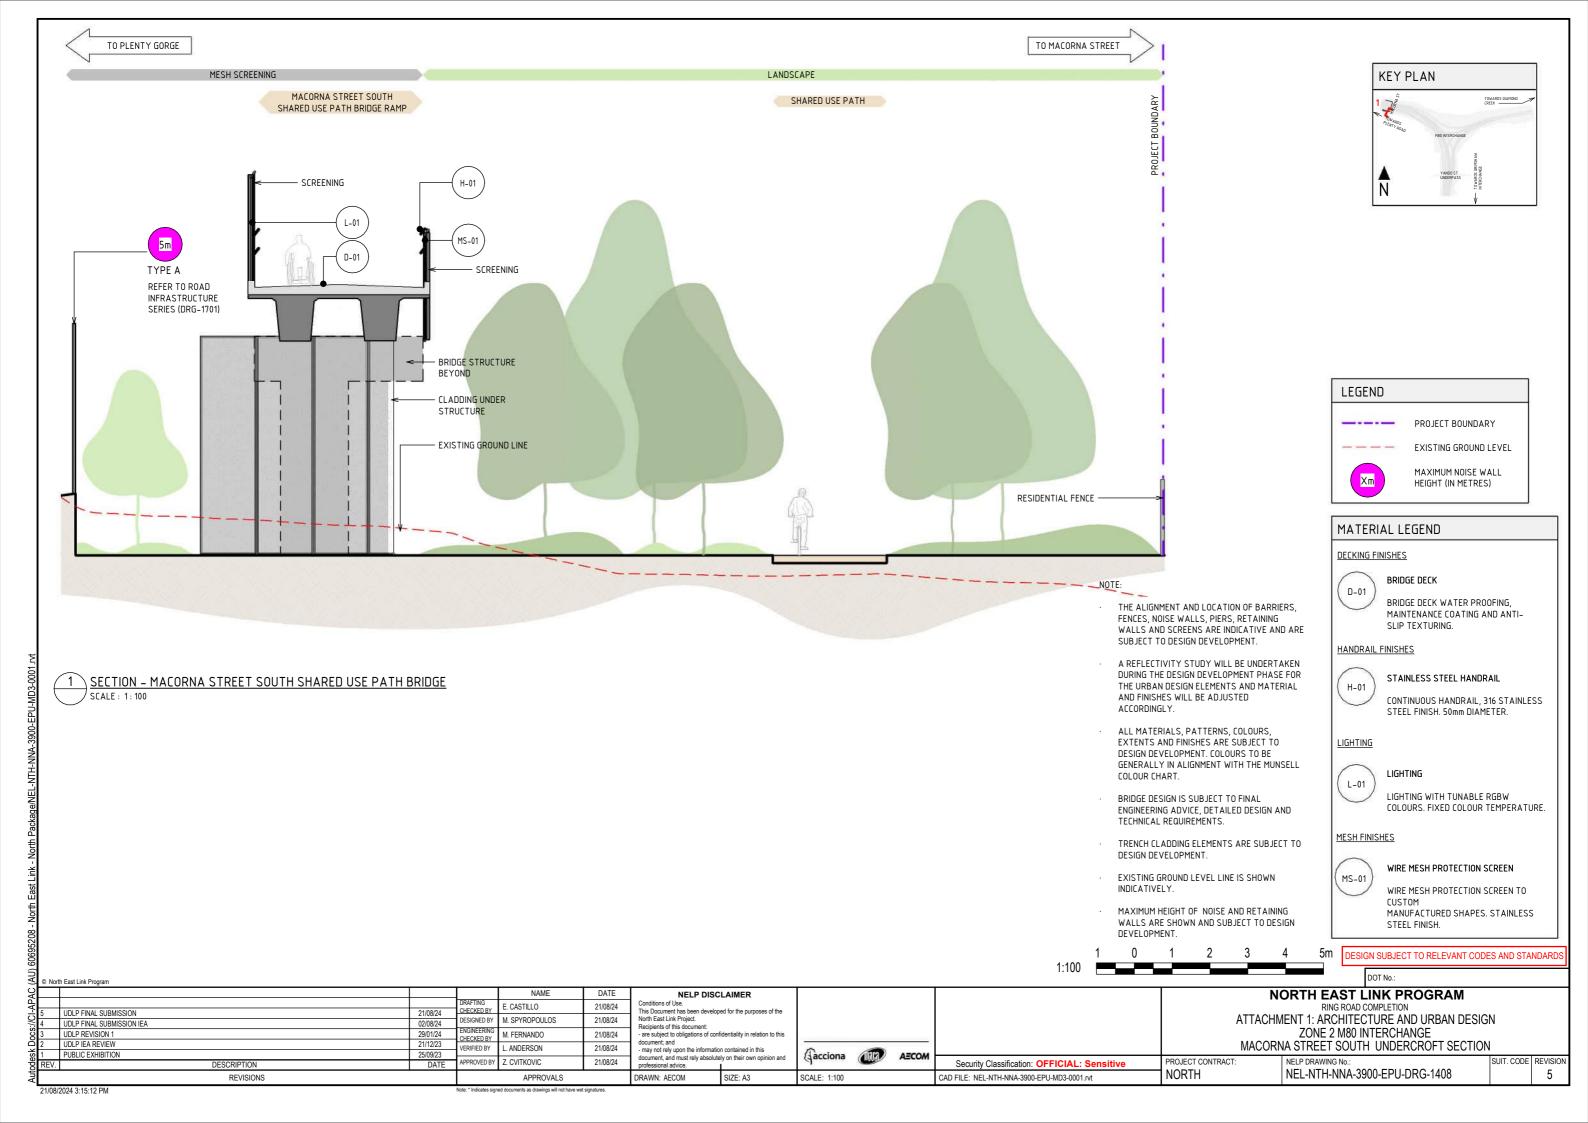
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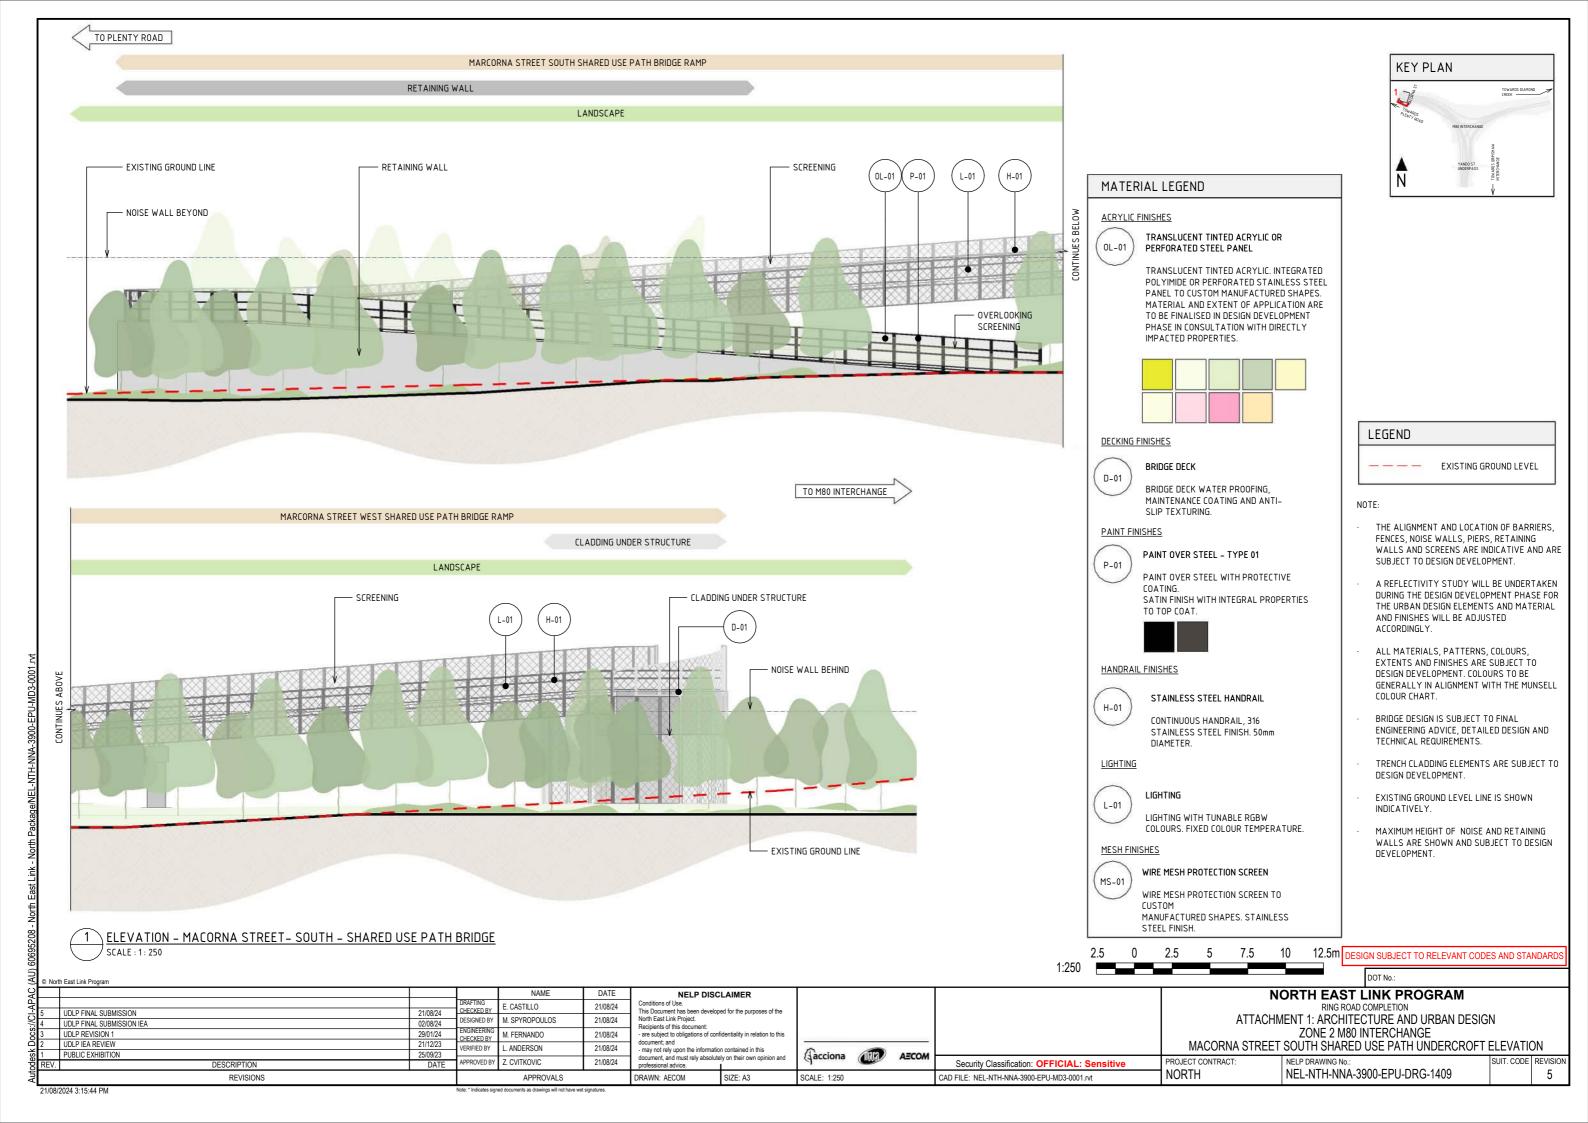
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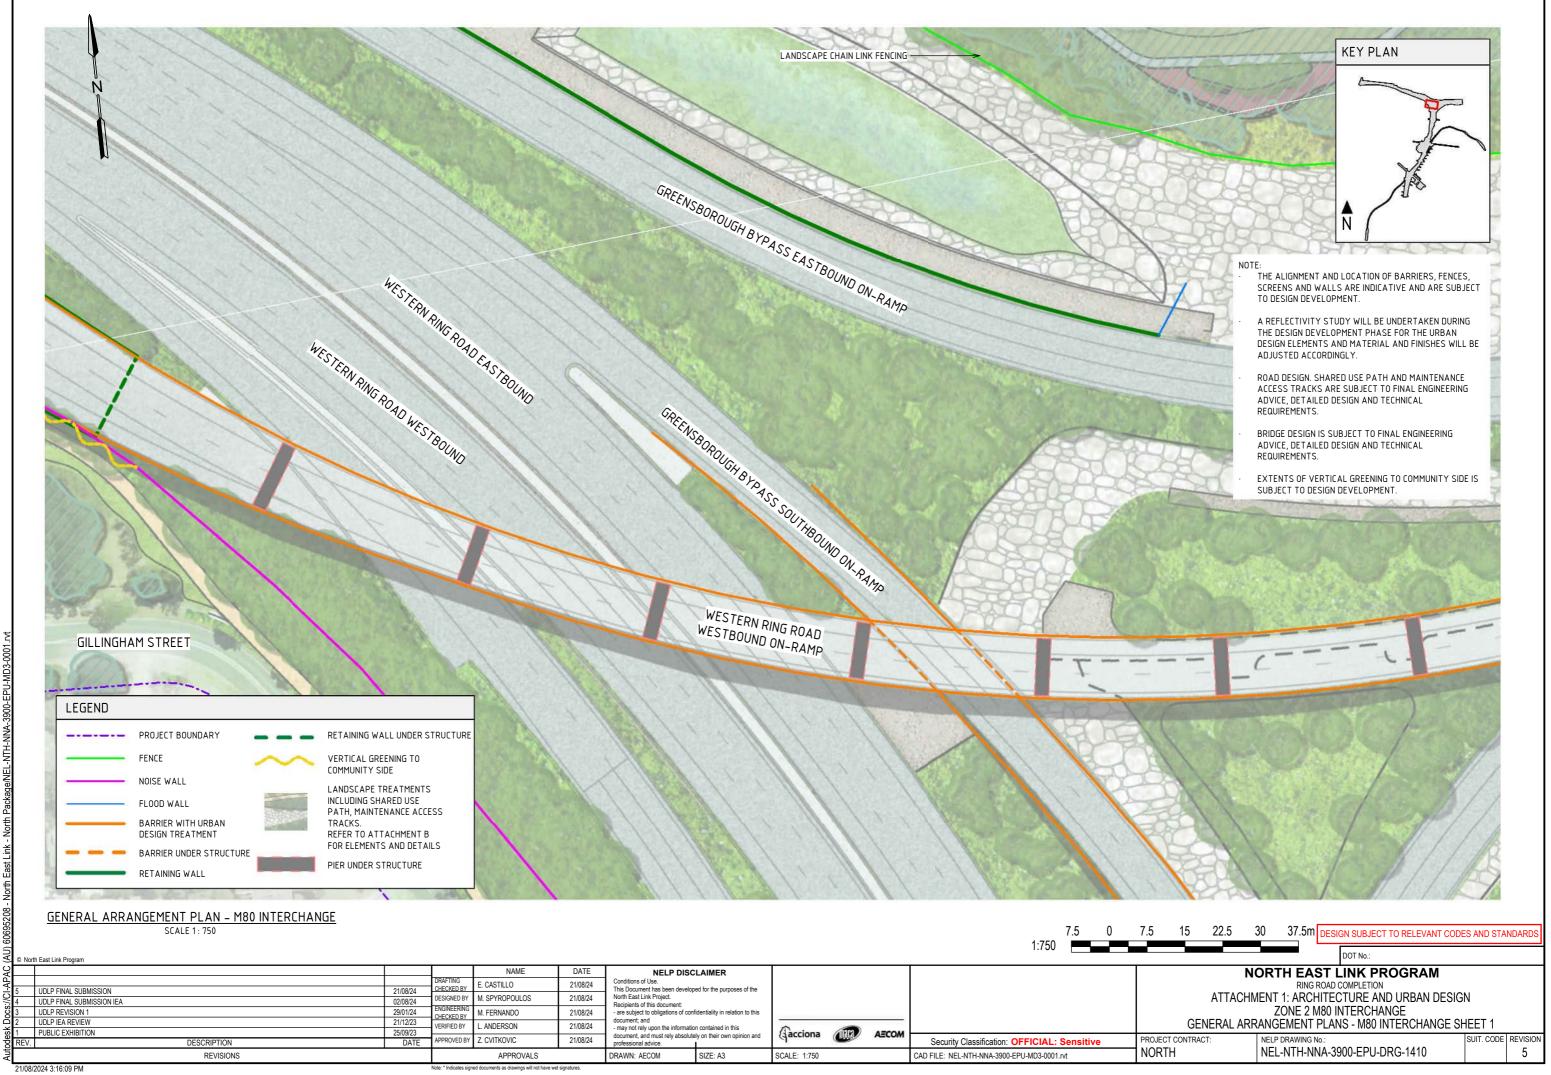



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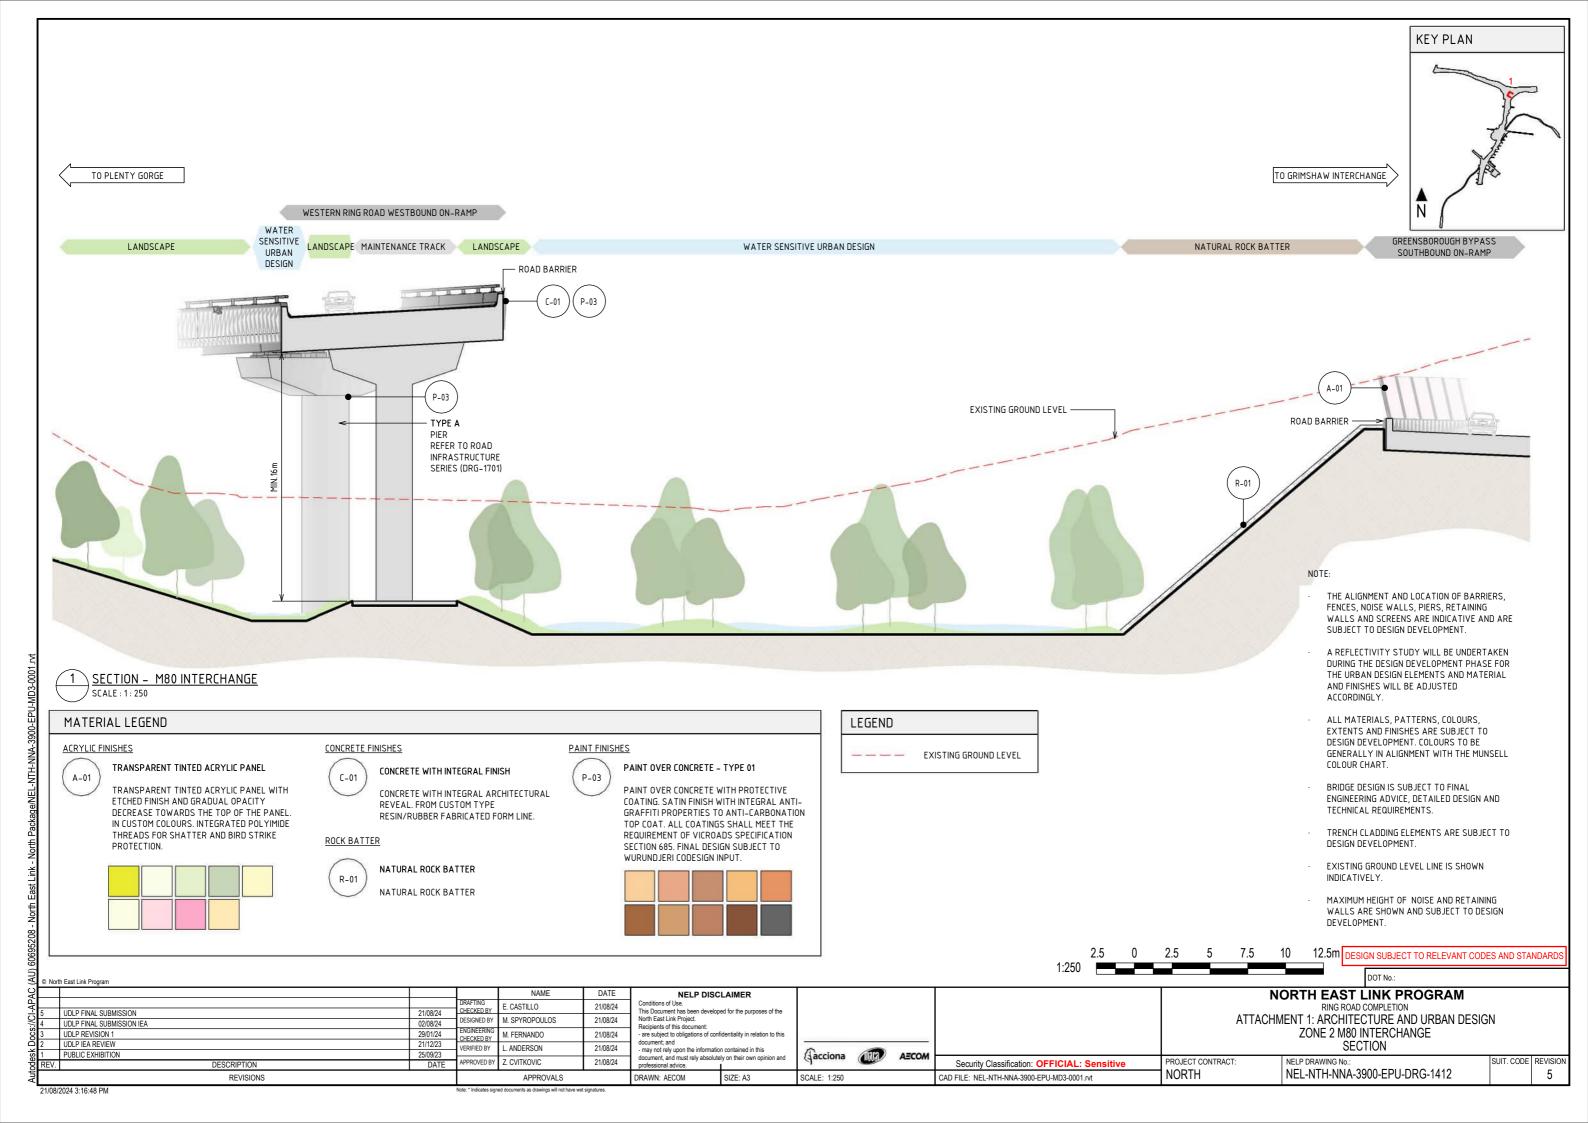
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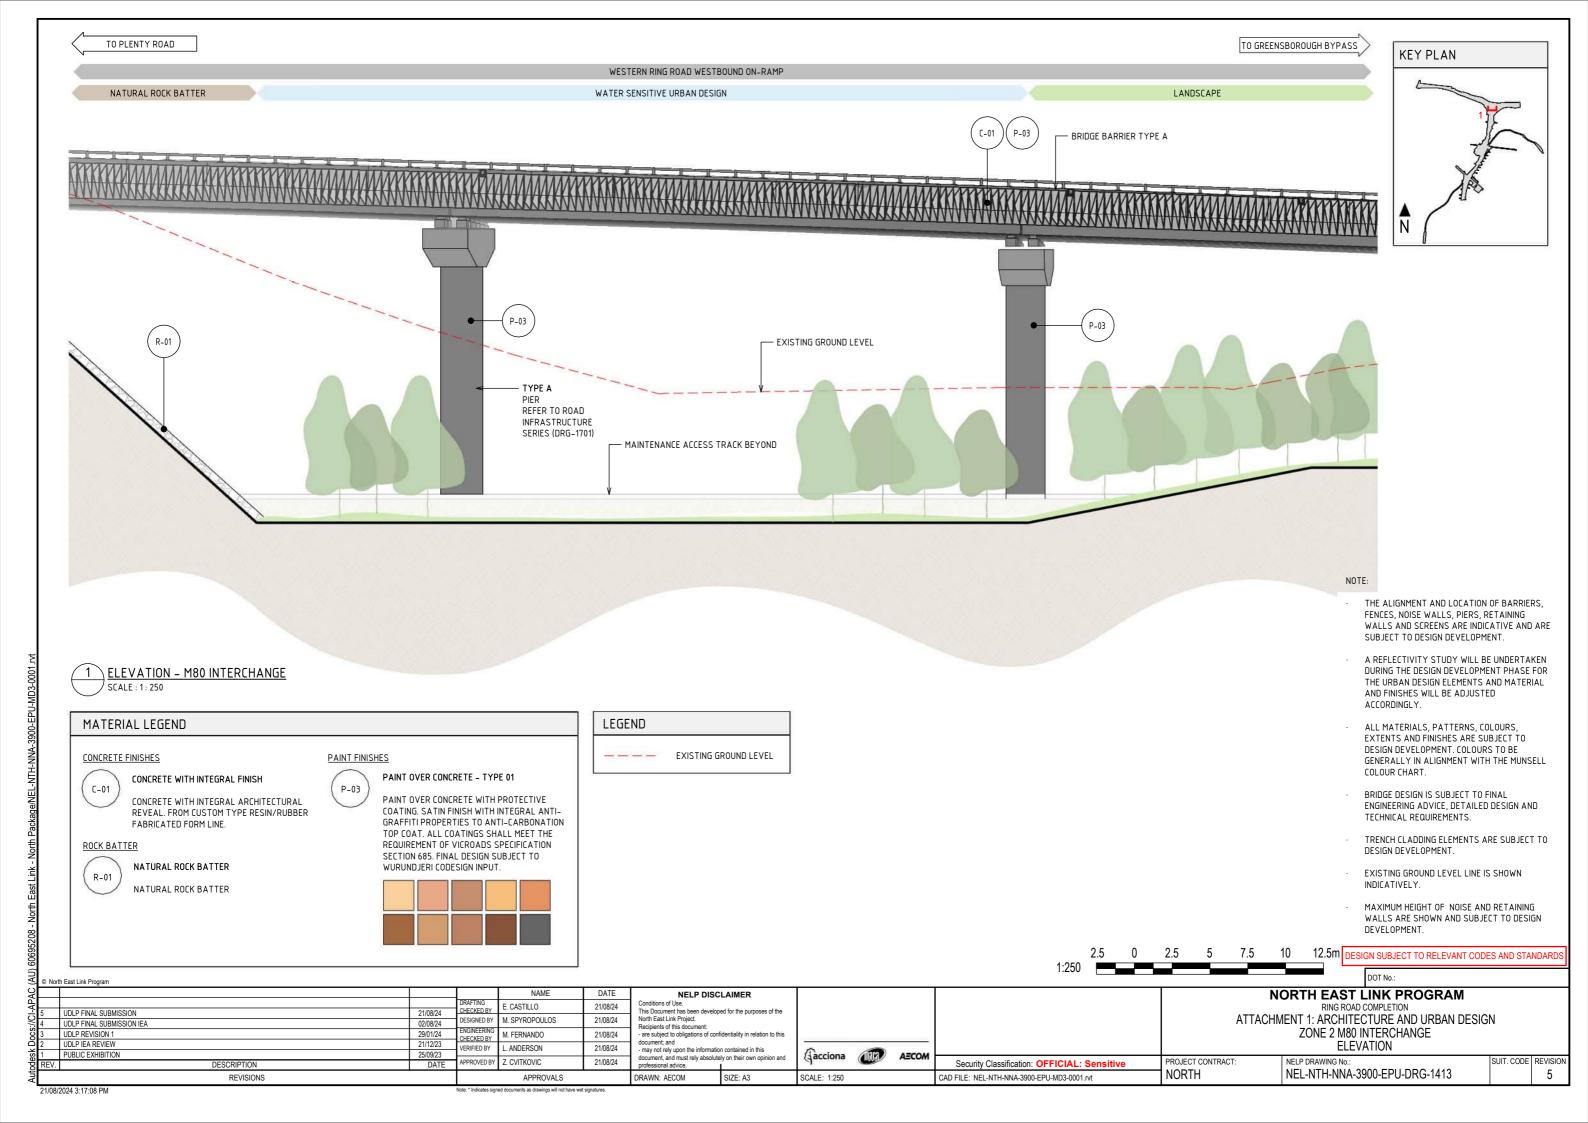











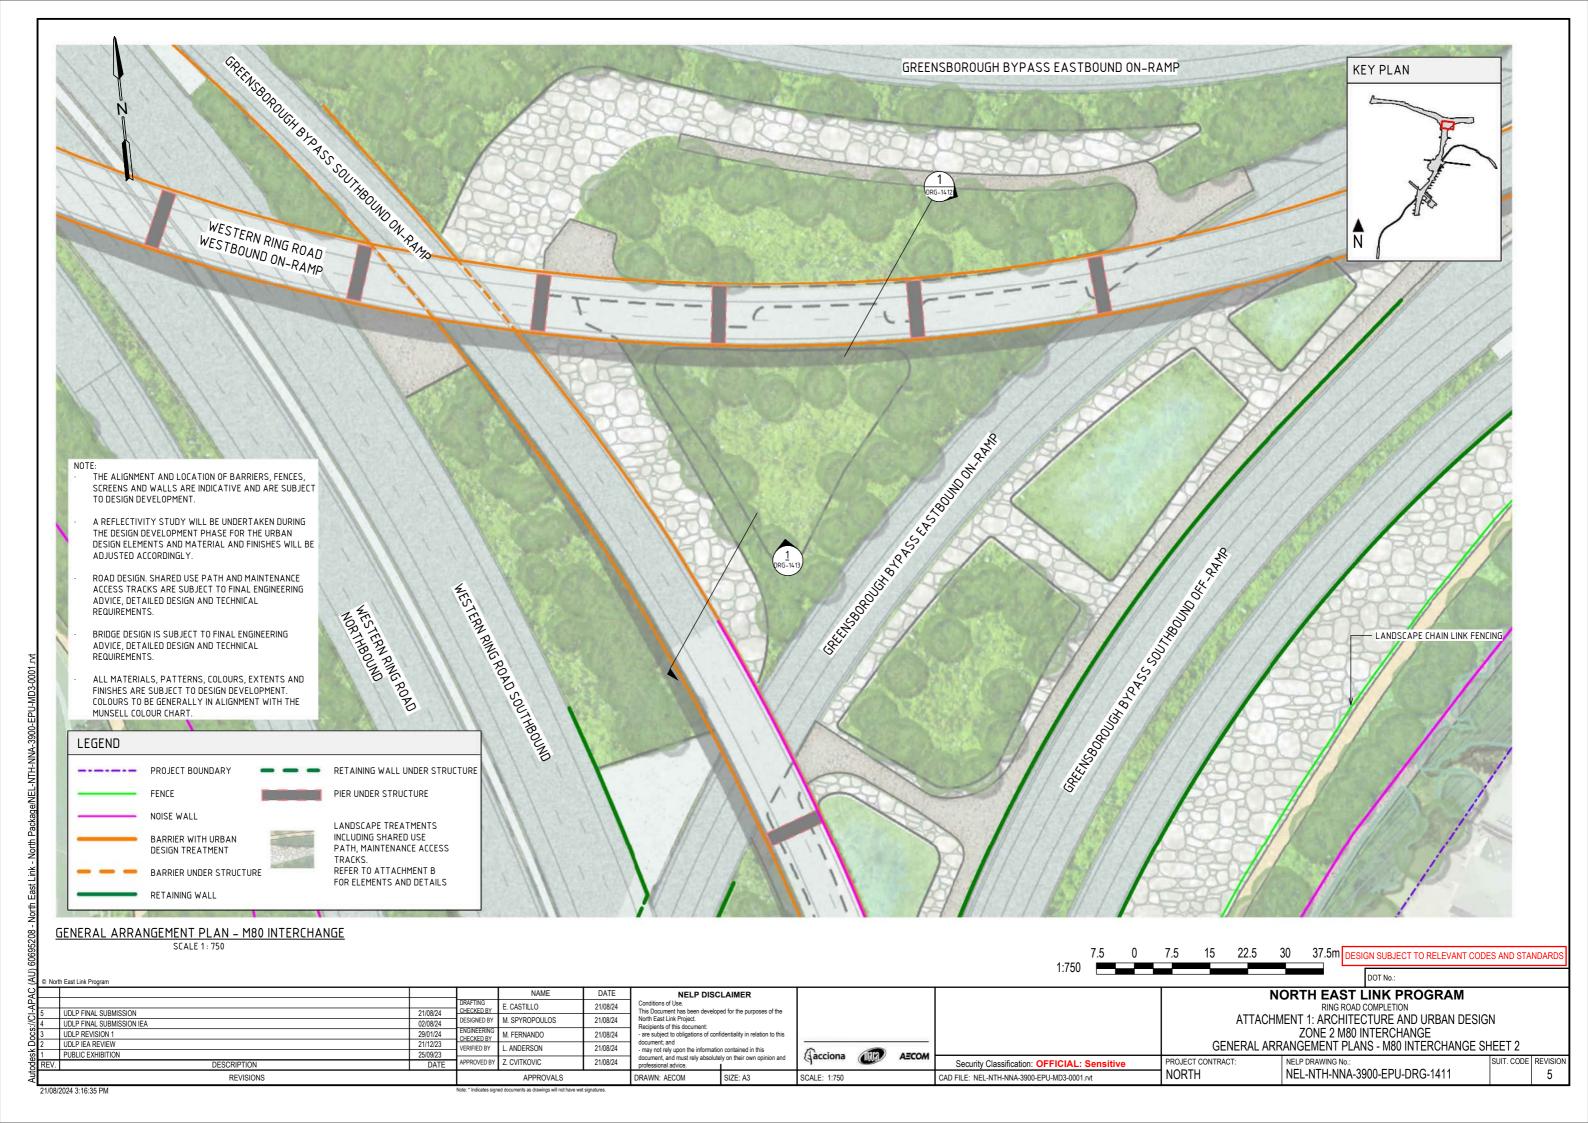

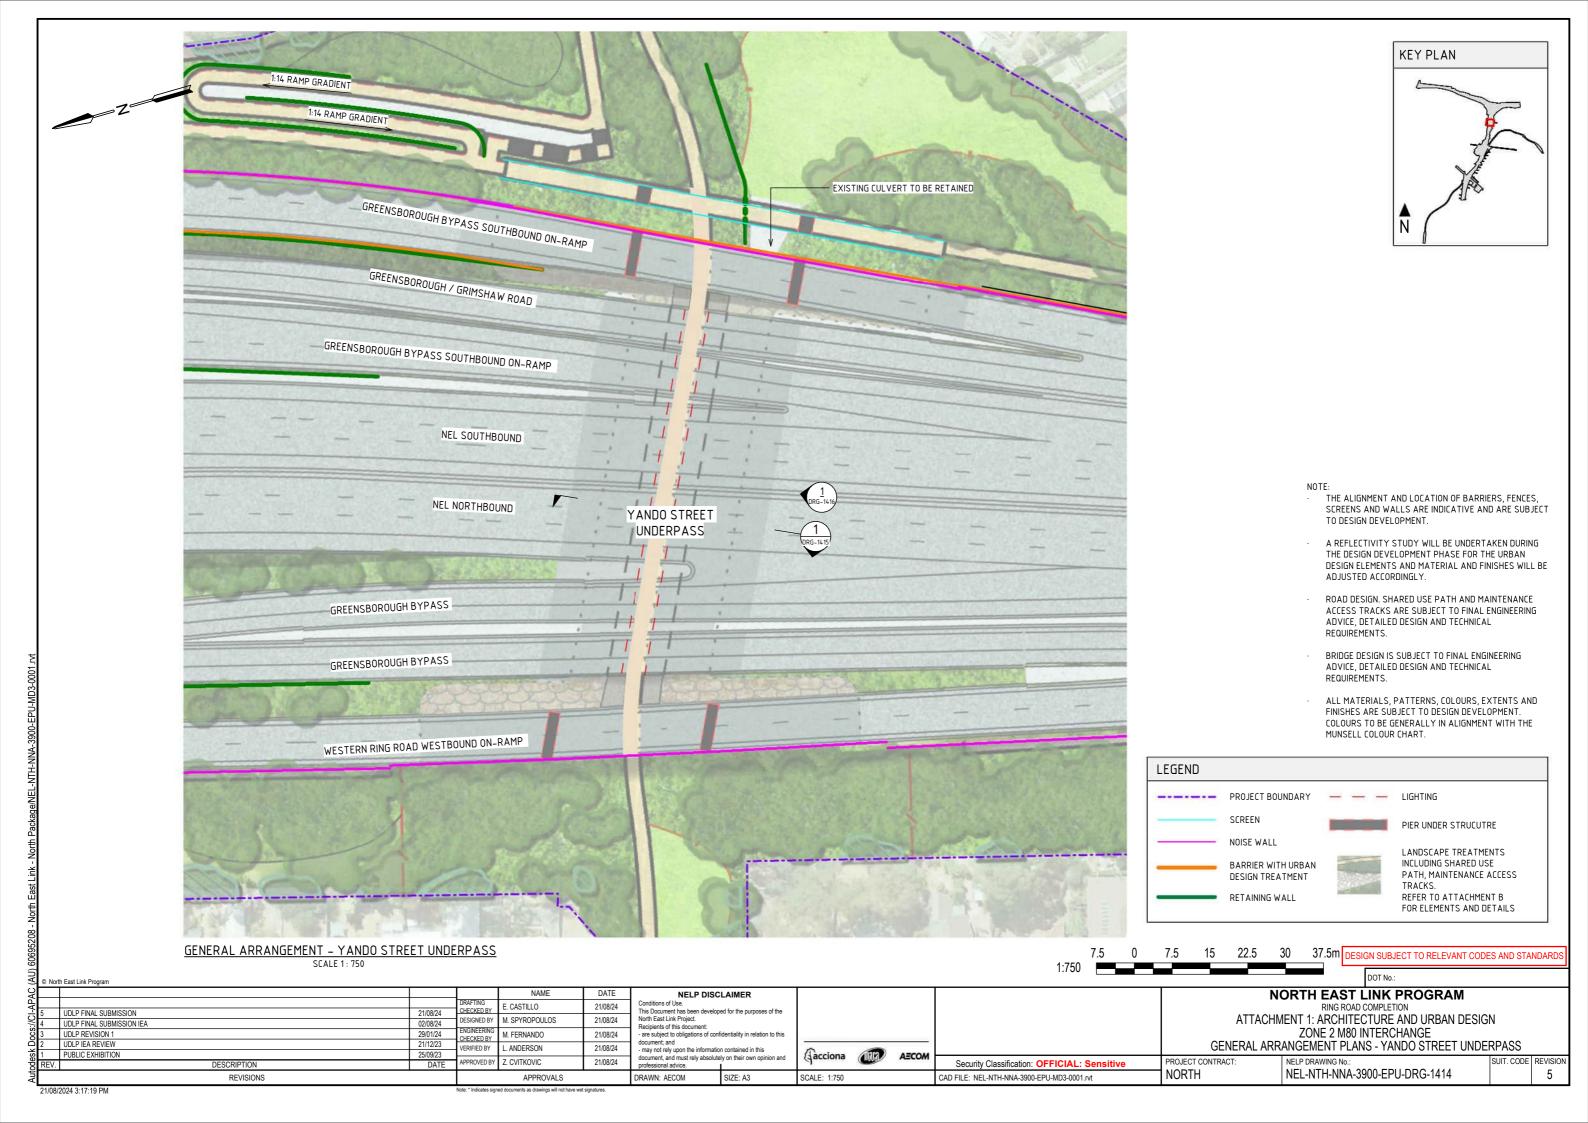

TO GRIMSHAW STREET INTERCHANGE

- EXISTING GROUND LEVEL

KEY PLAN N

ROCK BEACHING SHARED USE PATH ROCK BEACHING

BRIDGE ABUTMENT WITH INTEGRAL ARCHITECTURAL REVEAL YANDO STREET UNDERPASS BRIDGE ABUTMENT WITH INTEGRAL ARCHITECTURAL REVEAL - EXISTING CULVERT TO BE RETAINED CULVERT

LEGEND — — — EXISTING GROUND LEVEL

MATERIAL LEGEND

LIGHTING



LIGHTING WITH TUNABLE RGBW COLOURS. FIXED COLOUR TEMPERATURE.

ROCK BATTER



ROCK BEACHING

ROCK BEACHING TREATMENT

SECTION - YANDO STREET UNDERPASS

REVISIONS

SCALE: 1:100

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NORTH EAST	INK PRO	GRAN

RING ROAD COMPLETION ATTACHMENT 1: ARCHITECTURE AND URBAN DESIGN **ZONE 2 M80 INTERCHANGE**

YANDO STREET UNDERPASS - SECTION

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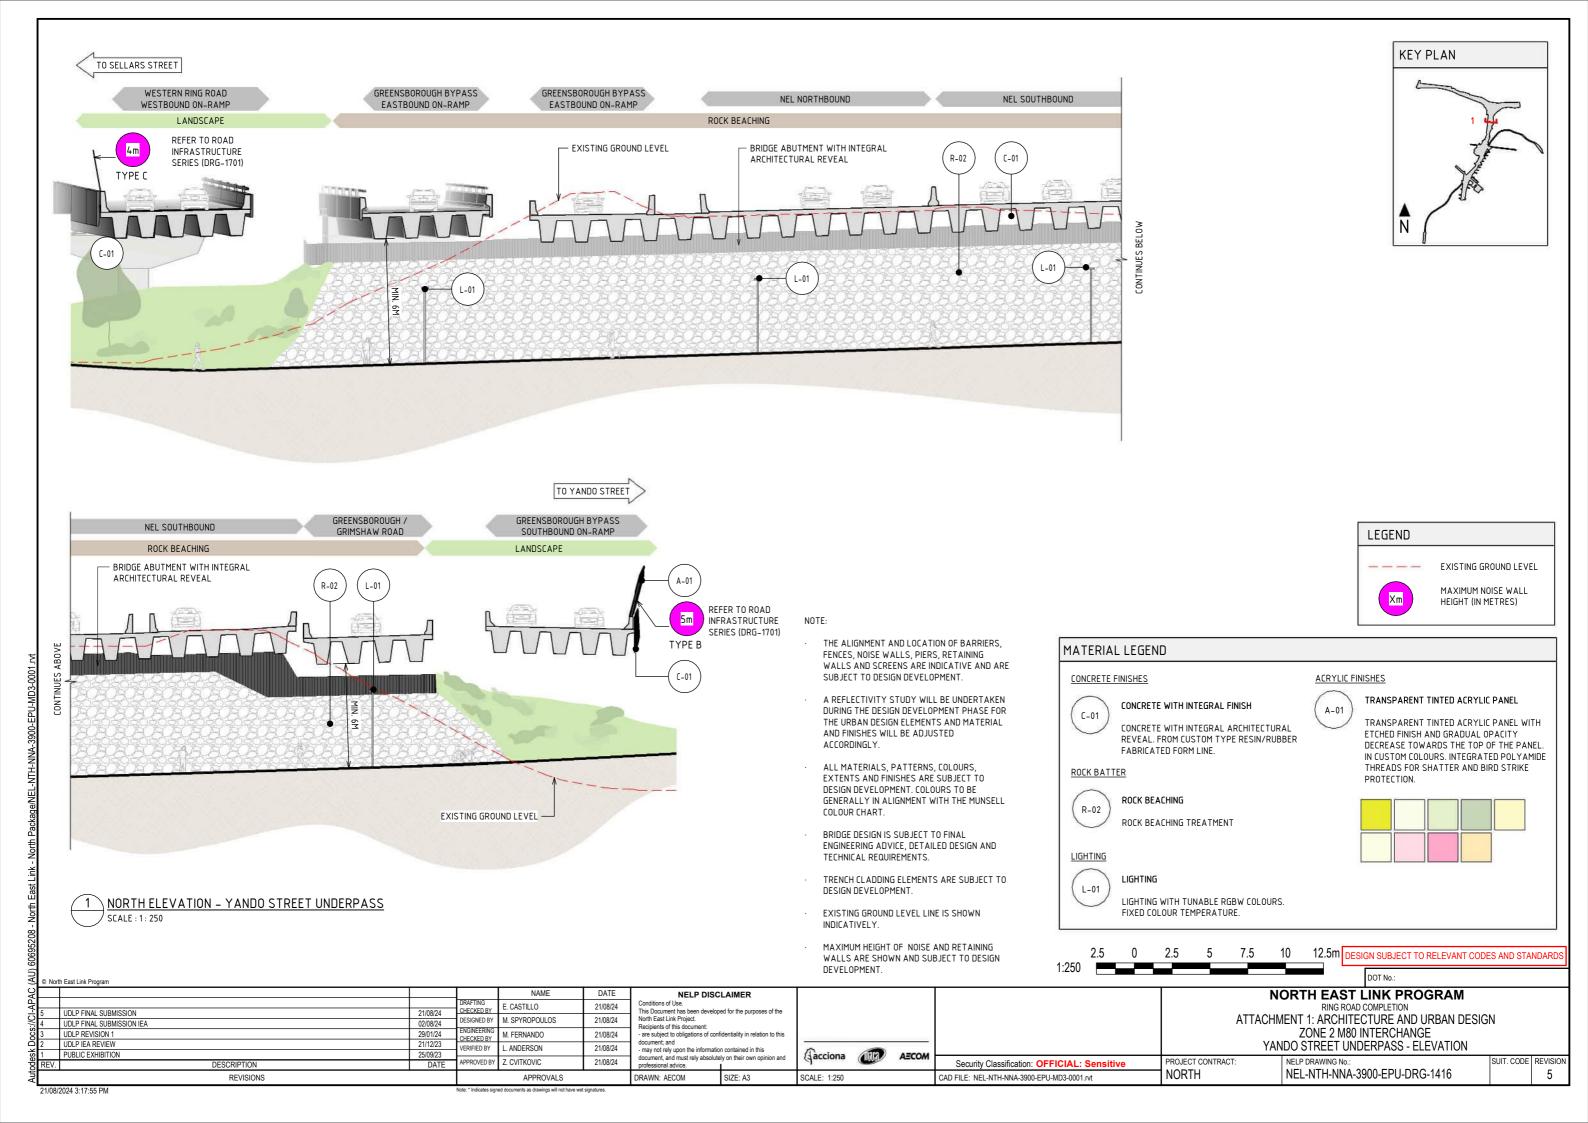
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APPROVALS



ZONE 3 GREENSBOROUGH ROAD

DRAWING INDEX

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DRAWING NAME	SHEET NUMBER
LOCALITY PLAN	NEL-NTH-NNA-3900-EPU-DRG-1501
GENERAL ARRANGEMENT PLANS - KEMPSTON STREET UNDERPASS	NEL-NTH-NNA-3900-EPU-DRG-1502
SECTIONS - KEMPSTON STREET UNDERPASS	NEL-NTH-NNA-3900-EPU-DRG-1503
ELEVATIONS - KEMPSTON STREET UNDERPASS	NEL-NTH-NNA-3900-EPU-DRG-1504
GENERAL ARRANGEMENT PLANS - GRIMSHAW STREET INTERCHANGE	NEL-NTH-NNA-3900-EPU-DRG-1505
GENERAL ARRANGEMENT PLANS - GRIMSHAW STREET EAST UNDERPASS	NEL-NTH-NNA-3900-EPU-DRG-1506
SECTIONS - GRIMSHAW STREET EAST UNDERPASS	NEL-NTH-NNA-3900-EPU-DRG-1507
ELEVATIONS - GRIMSHAW STREET EAST UNDERPASS	NEL-NTH-NNA-3900-EPU-DRG-1508
GENERAL ARRANGEMENT PLANS - GRIMSHAW STREET WEST UNDERPASS	NEL-NTH-NNA-3900-EPU-DRG-1509
SECTIONS - GRIMSHAW STREET WEST UNDERPASS	NEL-NTH-NNA-3900-EPU-DRG-1510
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GENERAL ARRANGEMENT PLANS - GRIMSHAW STREET ITS BAY AND INCIDENT RESPONSE BAY	NEL-NTH-NNA-3900-EPU-DRG-1512
GENERAL ARRANGEMENT PLANS - NELL STREET SHARED USE PATH BRIDGE	NEL-NTH-NNA-3900-EPU-DRG-1513
SECTIONS - NELL STREET SHARED USE PATH BRIDGE	NEL-NTH-NNA-3900-EPU-DRG-1514
ELEVATIONS - NELL STREET SHARED USE PATH BRIDGE	NEL-NTH-NNA-3900-EPU-DRG-1515
SECTIONS - NELL STREET EAST SHARED USE PATH UNDERCROFT	NEL-NTH-NNA-3900-EPU-DRG-1516
ELEVATIONS - NELL STREET EAST SHARED USE PATH BRIDGE	NEL-NTH-NNA-3900-EPU-DRG-1517
SECTIONS - NELL STREET WEST SHARED USE PATH BRIDGE	NEL-NTH-NNA-3900-EPU-DRG-1518
ELEVATIONS - NELL STREET WEST SHARED USE PATH UNDERCROFT	NEL-NTH-NNA-3900-EPU-DRG-1519

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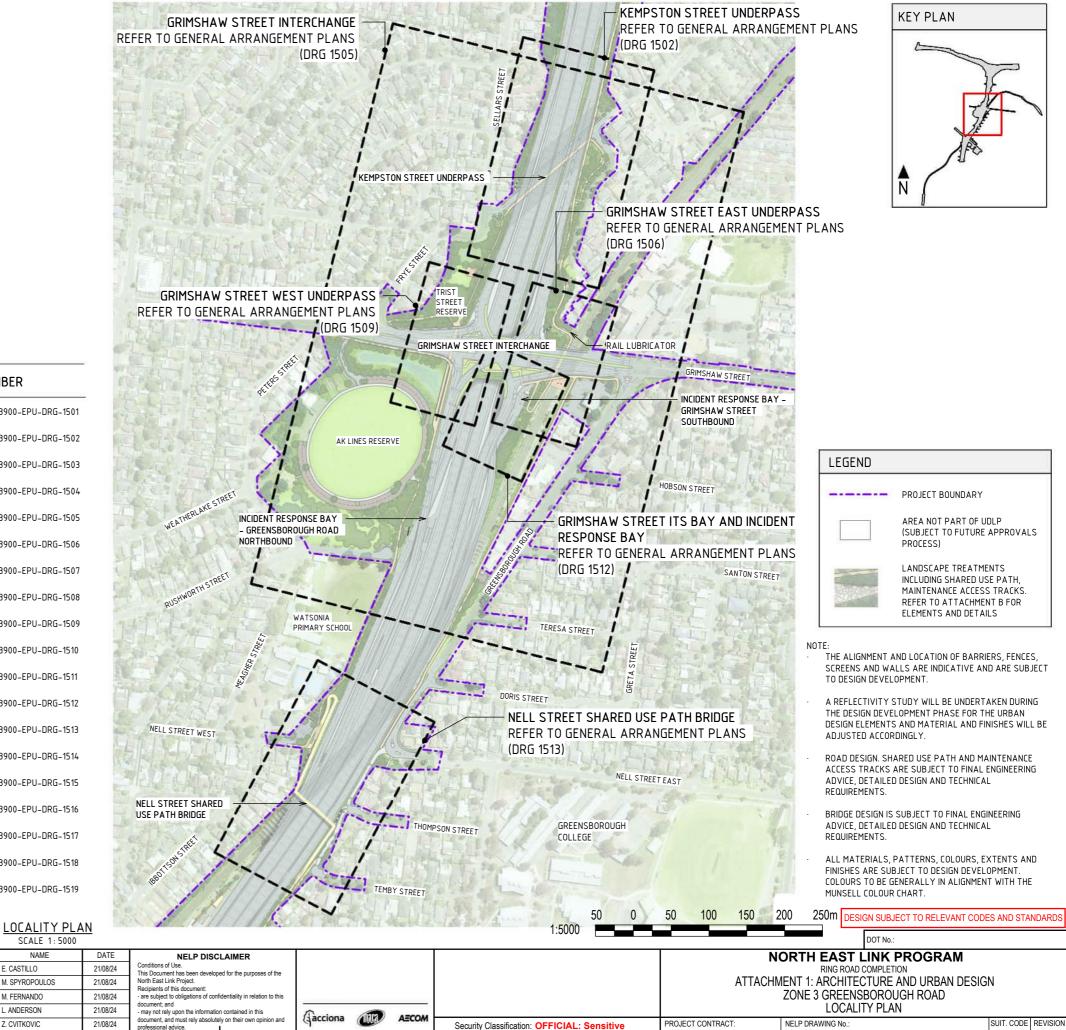
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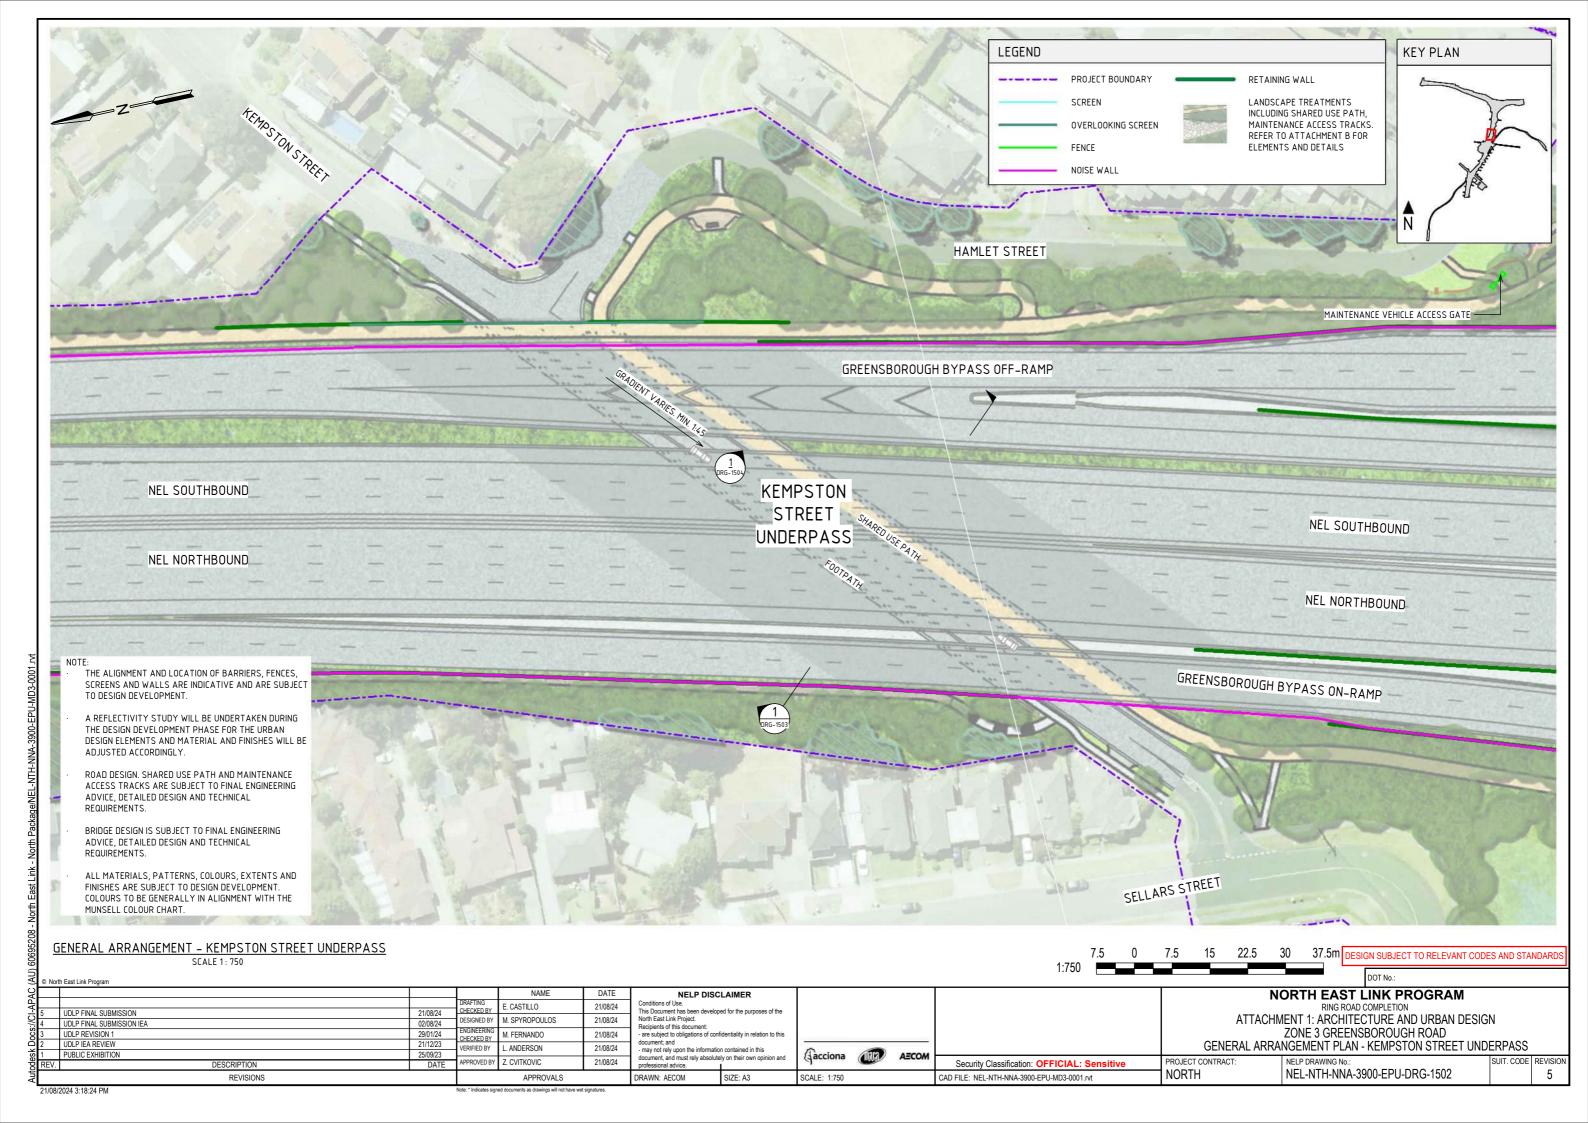
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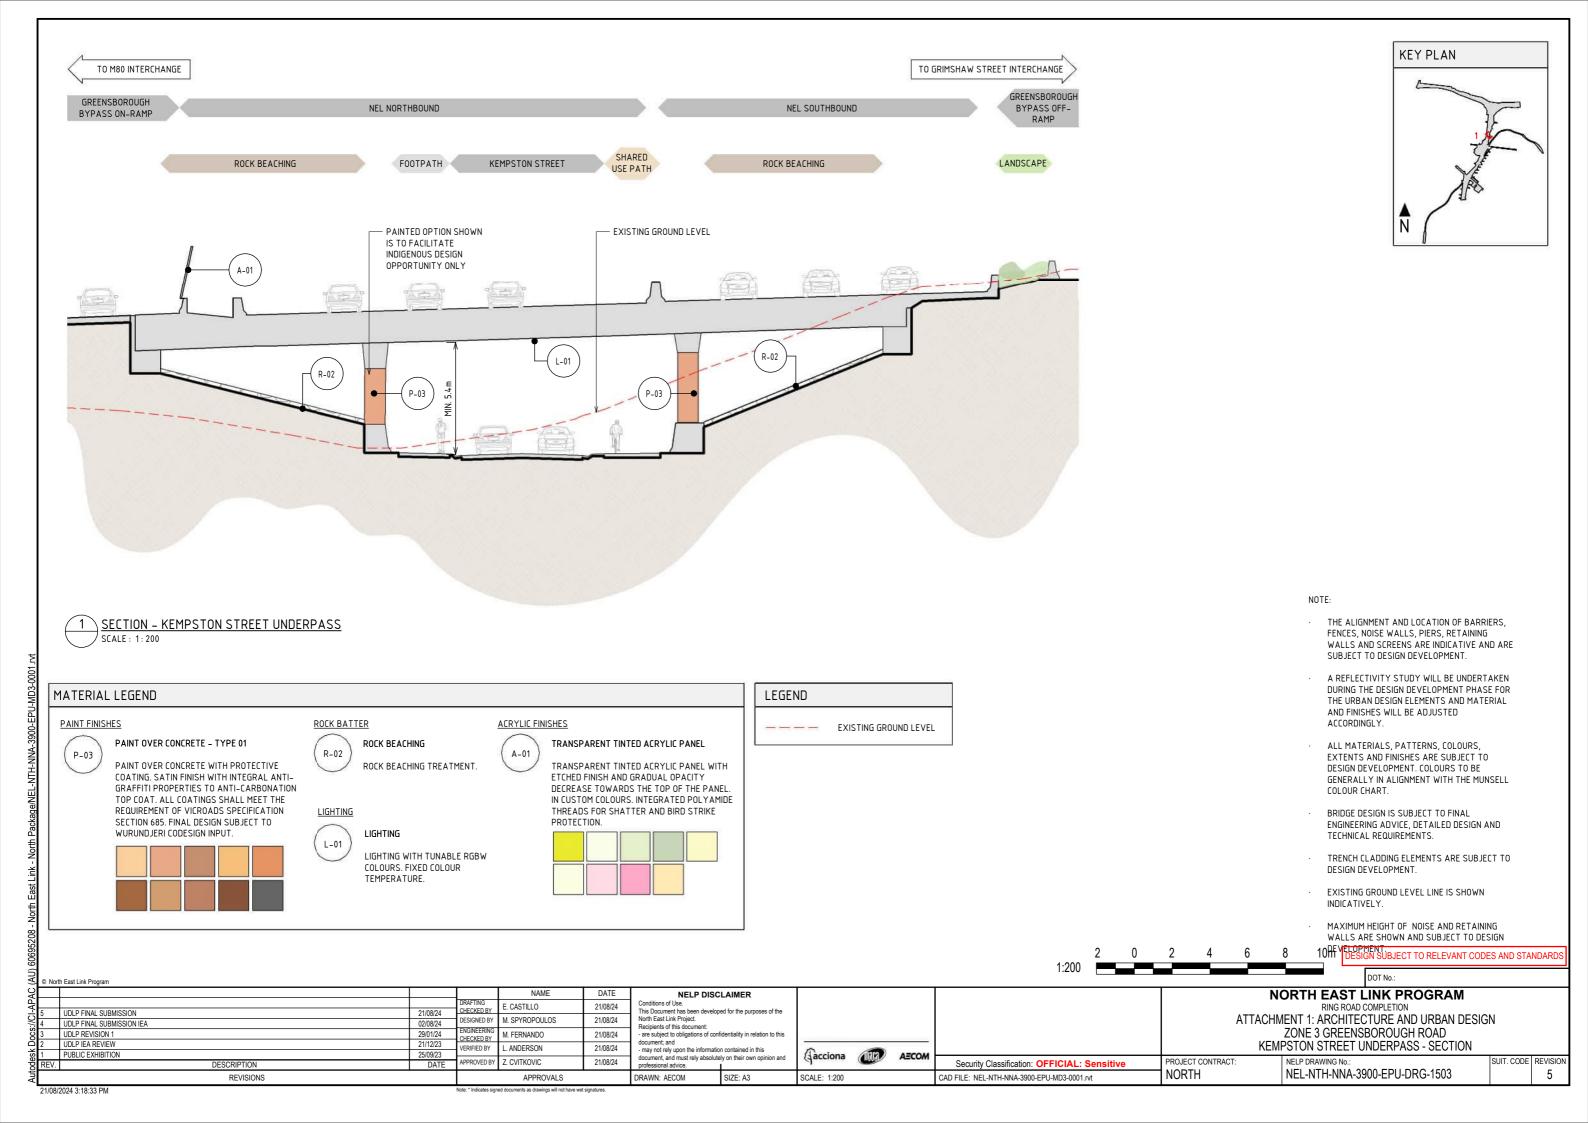
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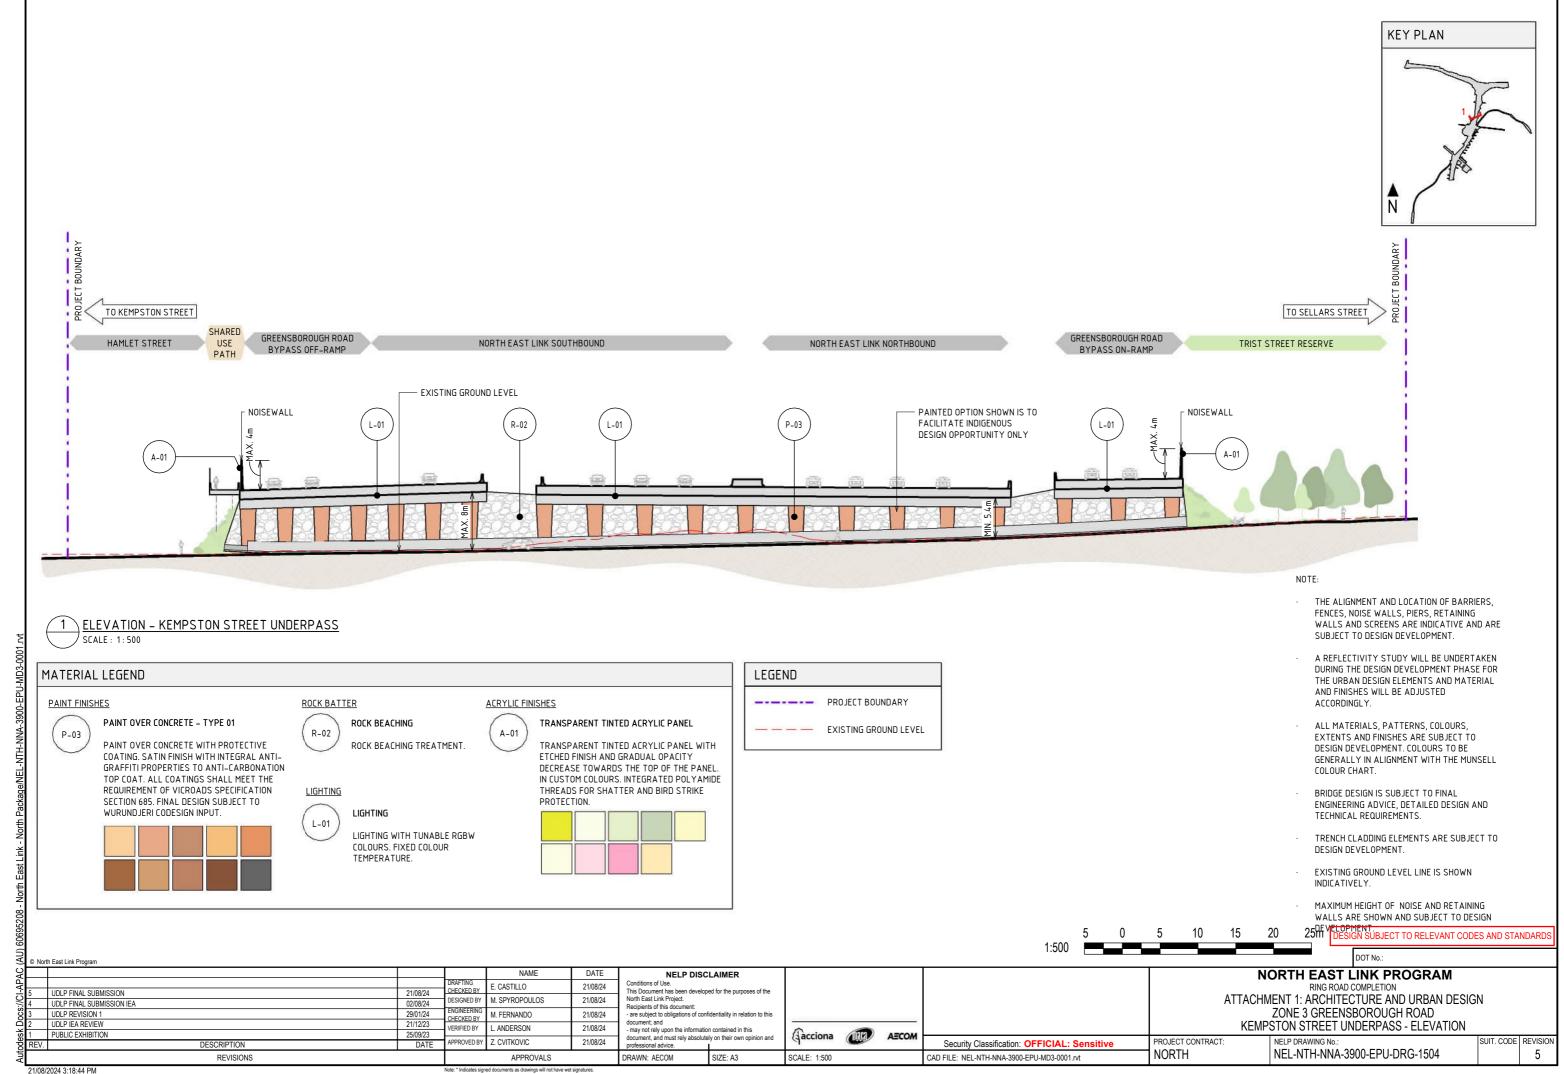
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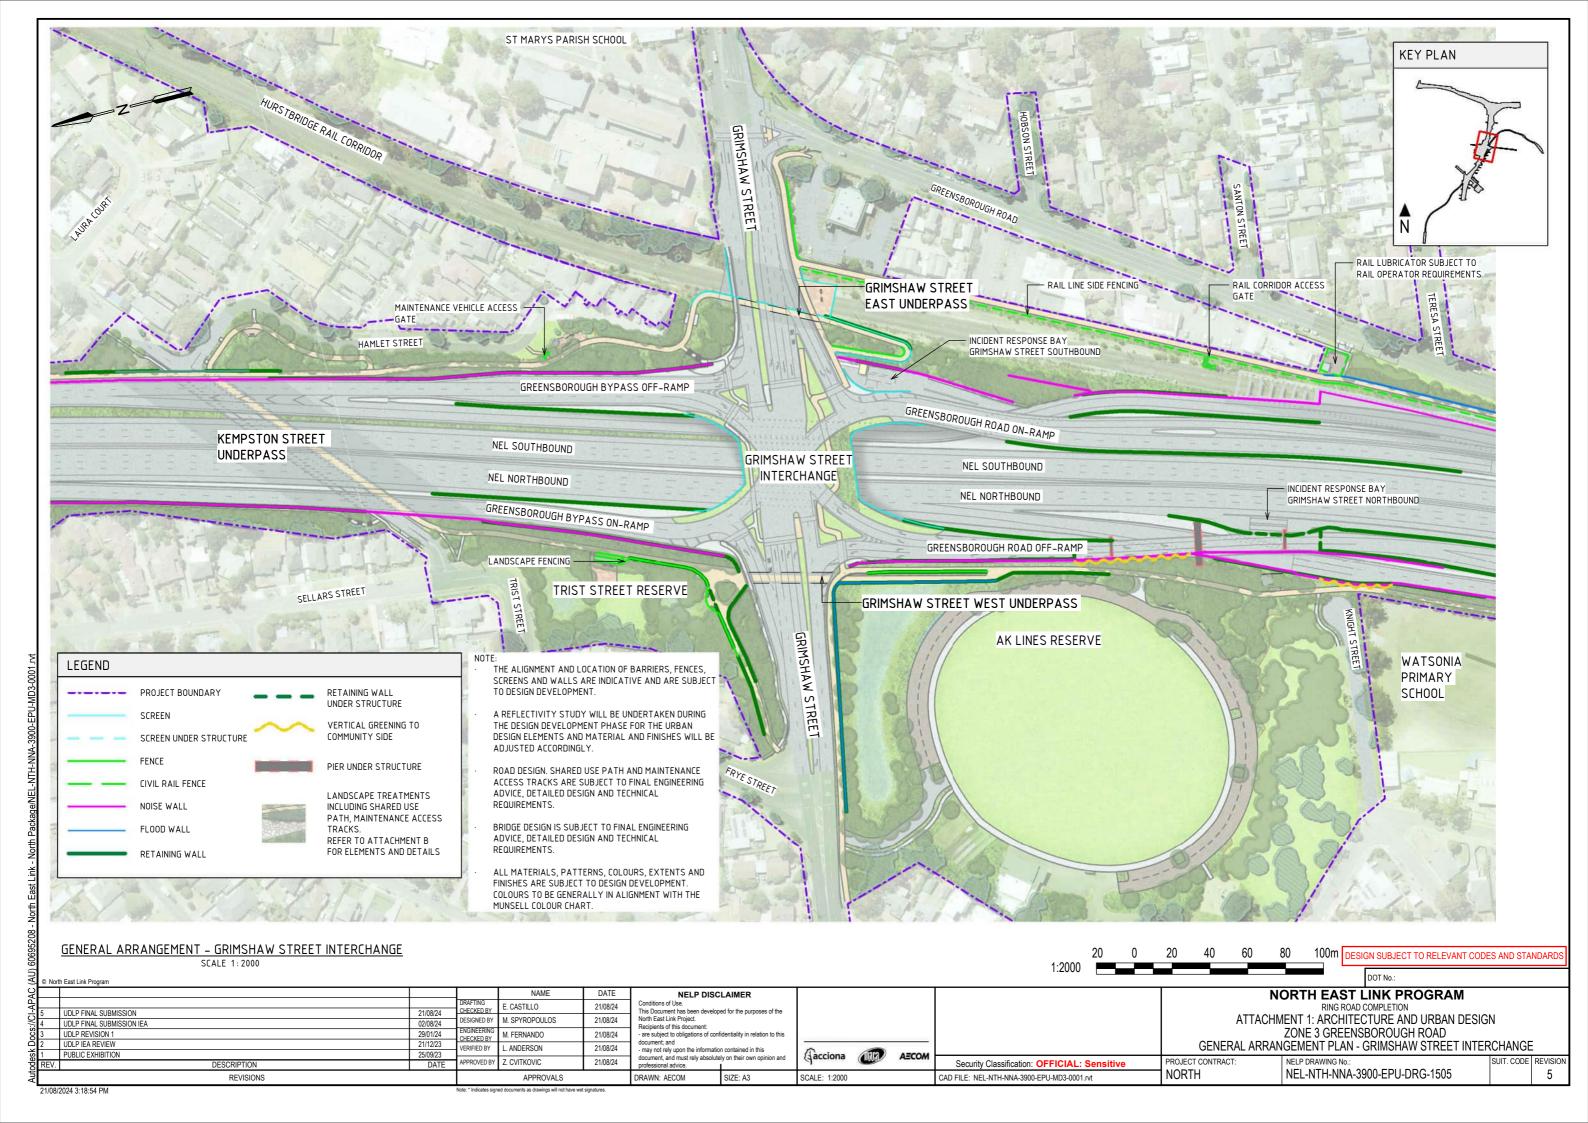
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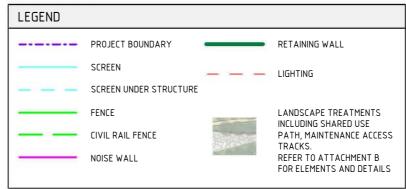


GENERAL ARRANGEMENT - GRIMSHAW STREET EAST UNDERPASS

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KEY PLAN

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NORTH FAST LINK PROGRAM

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RING ROAD COMPLETION
ATTACHMENT 1: ARCHITECTURE AND URBAN DESIGN
ZONE A OBSERVABOROUGH BOAR

ZONE 3 GREENSBOROUGH ROAD GENERAL ARRANGEMENT PLAN - GRIMSHAW STREET EAST UNDERPASS

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M SPYROPOULOS


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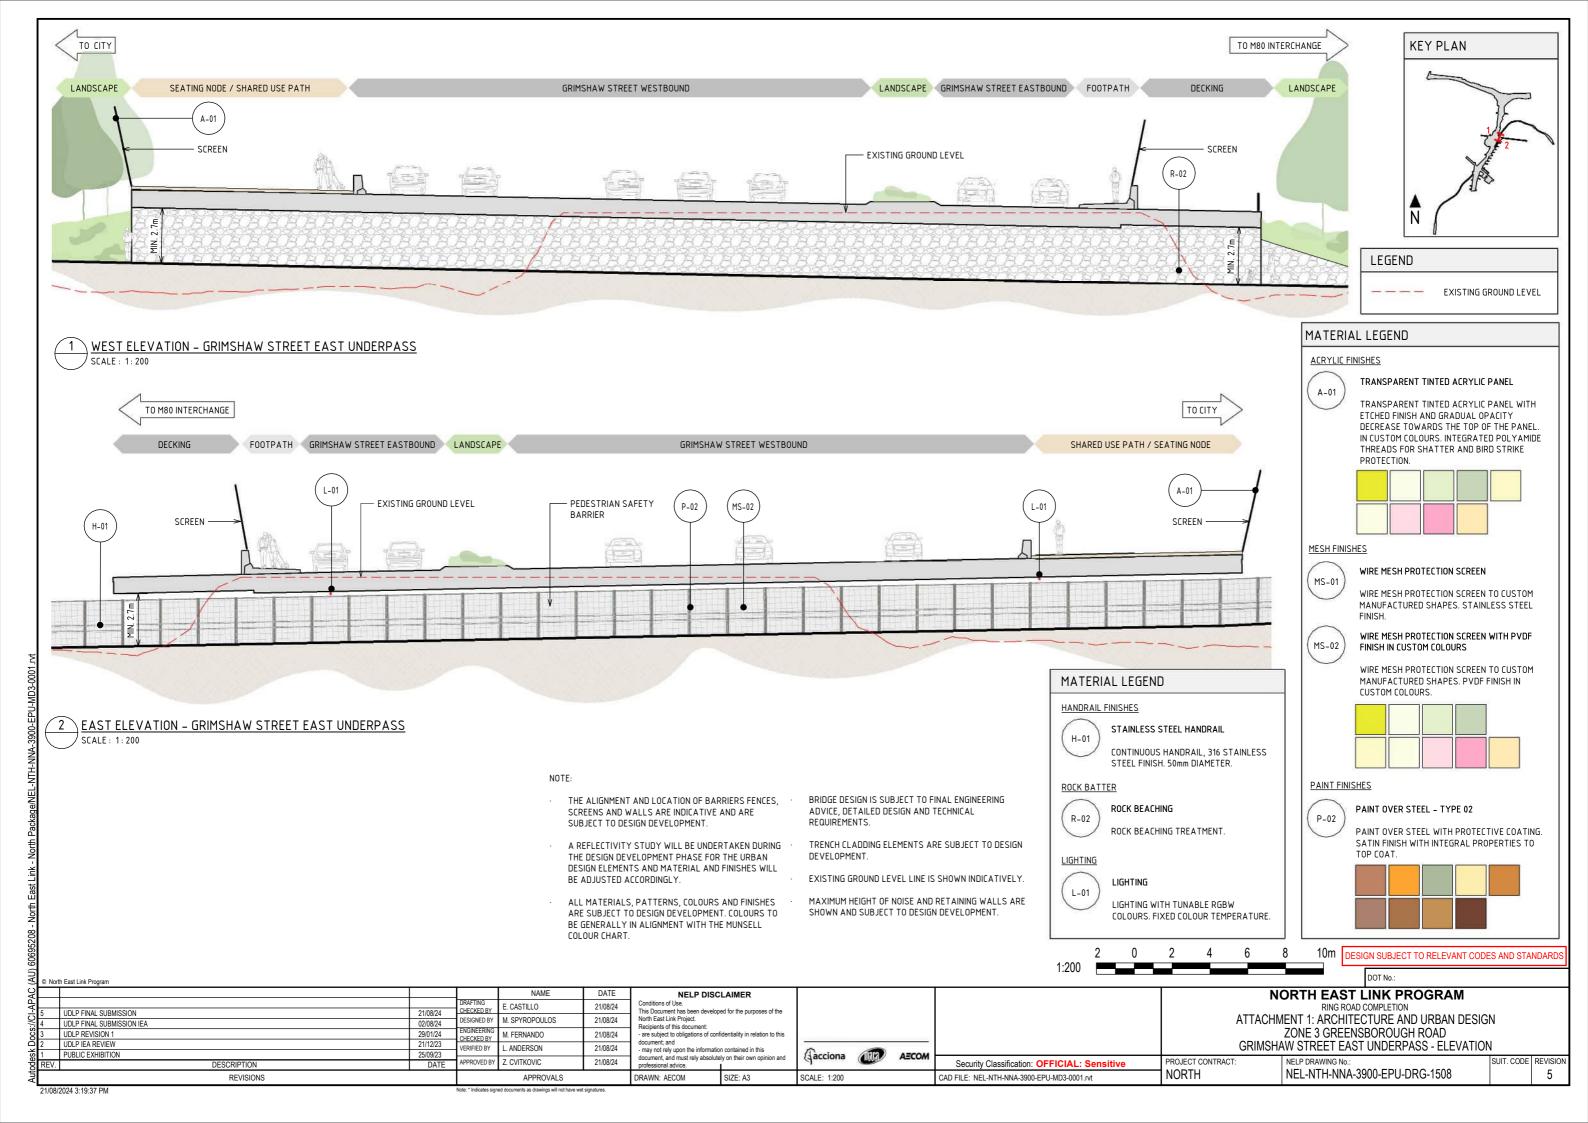
PROJECT CONTRACT

NELP DRAWING No. NEL-NTH-NNA-3900-EPU-DRG-1506 SUIT, CODE REVISION



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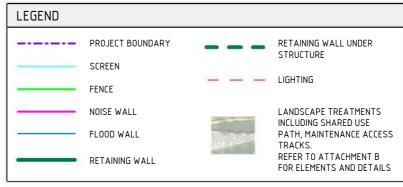
e: * Indicates signed documents as drawings will not have wet signatures.

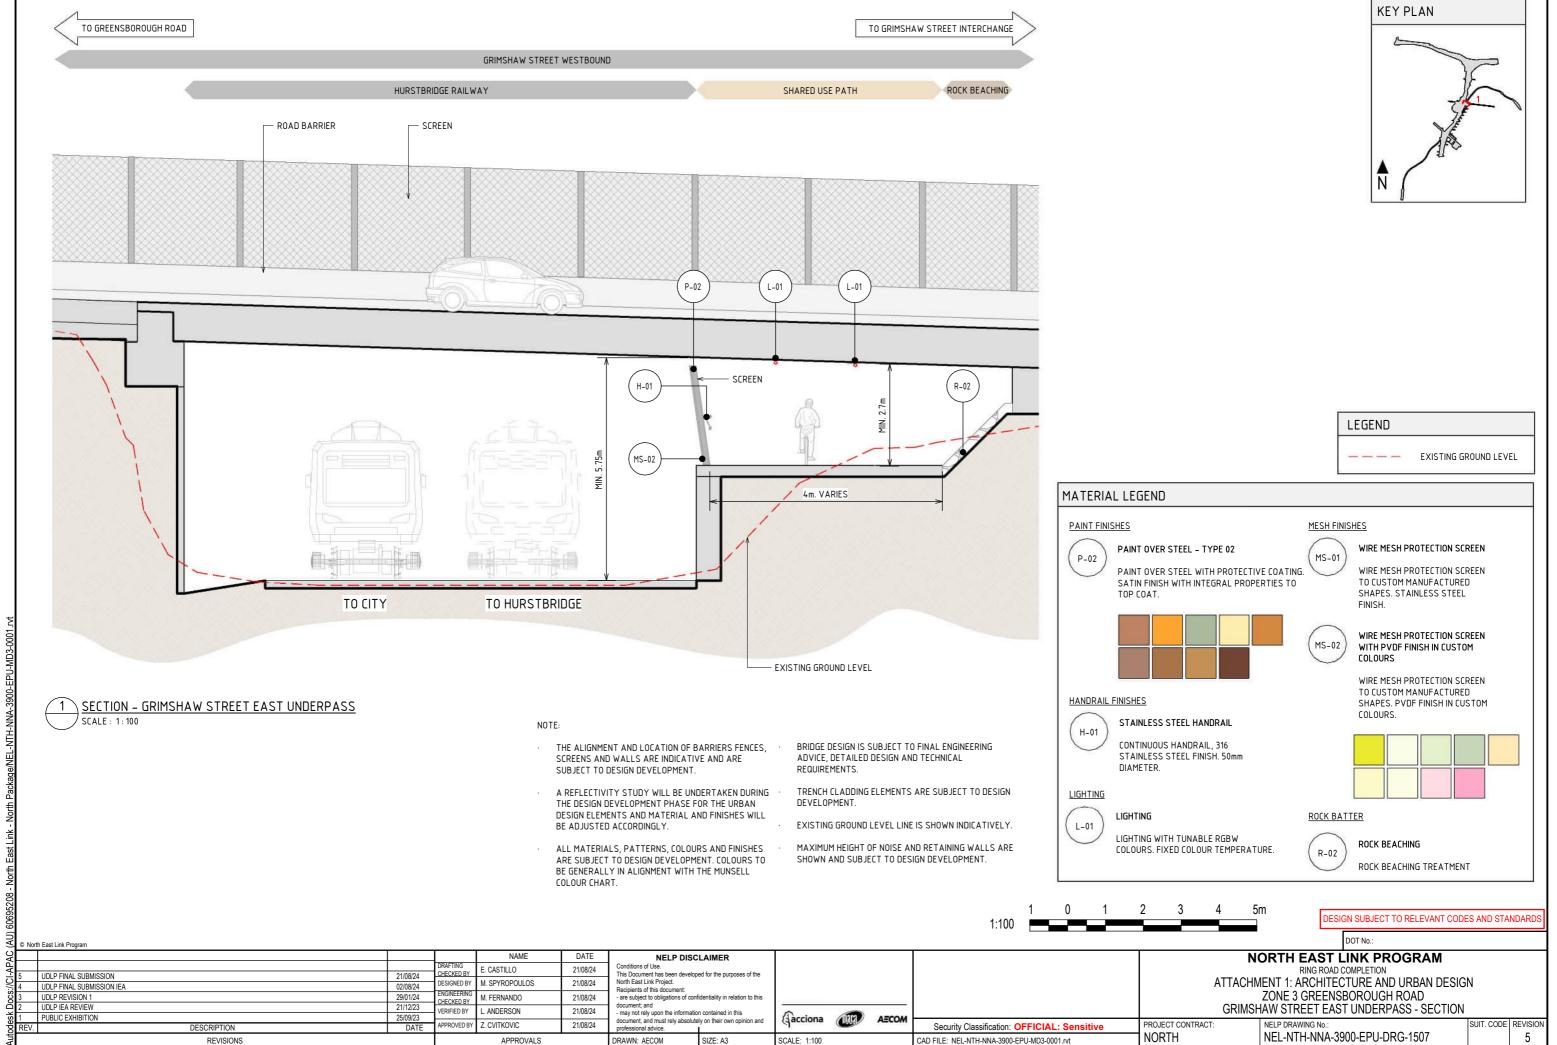

27



GENERAL ARRANGEMENT - GRIMSHAW STREET WEST UNDERPASS SCALE 1: 750



Security Classification: OFFICIAL: Sensitive

CAD FILE: NEL-NTH-NNA-3900-EPU-MD3-0001.rvt

THE ALIGNMENT AND LOCATION OF BARRIERS, FENCES, SCREENS AND WALLS ARE INDICATIVE AND ARE SUBJECT TO DESIGN DEVELOPMENT.

KEY PLAN

- A REFLECTIVITY STUDY WILL BE UNDERTAKEN DURING THE DESIGN DEVELOPMENT PHASE FOR THE URBAN DESIGN ELEMENTS AND MATERIAL AND FINISHES WILL BE ADJUSTED ACCORDINGLY.
- ROAD DESIGN. SHARED USE PATH AND MAINTENANCE ACCESS TRACKS ARE SUBJECT TO FINAL ENGINEERING ADVICE, DETAILED DESIGN AND TECHNICAL
- BRIDGE DESIGN IS SUBJECT TO FINAL ENGINEERING ADVICE, DETAILED DESIGN AND TECHNICAL REQUIREMENTS.
- ALL MATERIALS, PATTERNS, COLOURS, EXTENTS AND FINISHES ARE SUBJECT TO DESIGN DEVELOPMENT. COLOURS TO BE GENERALLY IN ALIGNMENT WITH THE MUNSELL COLOUR CHART.

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DESIGN SUBJECT TO RELEVANT CODES AND STANDARD

NORTH EAST L	INK PROGRAM
DING DOAD	COMPLETION

RING ROAD COMPLETION
ATTACHMENT 1: ARCHITECTURE AND URBAN DESIGN
ZONE 3 GREENSBOROUGH ROAD

GENERAL ARRANGEMENT PLAN - GRIMSHAW STREET WEST UNDERPASS

REVISIONS

NAME

E. CASTILLO

M. FERNANDO

. ANDERSON

7 CVITKOVIC

M SPYROPOULOS

CHECKED BY

CHECKED BY

ERIFIED BY

APPROVED BY

DESIGNED BY

21/08/24

02/08/24

29/01/24

DATE

DATE

21/08/24

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UDLP FINAL SUBMISSION IEA


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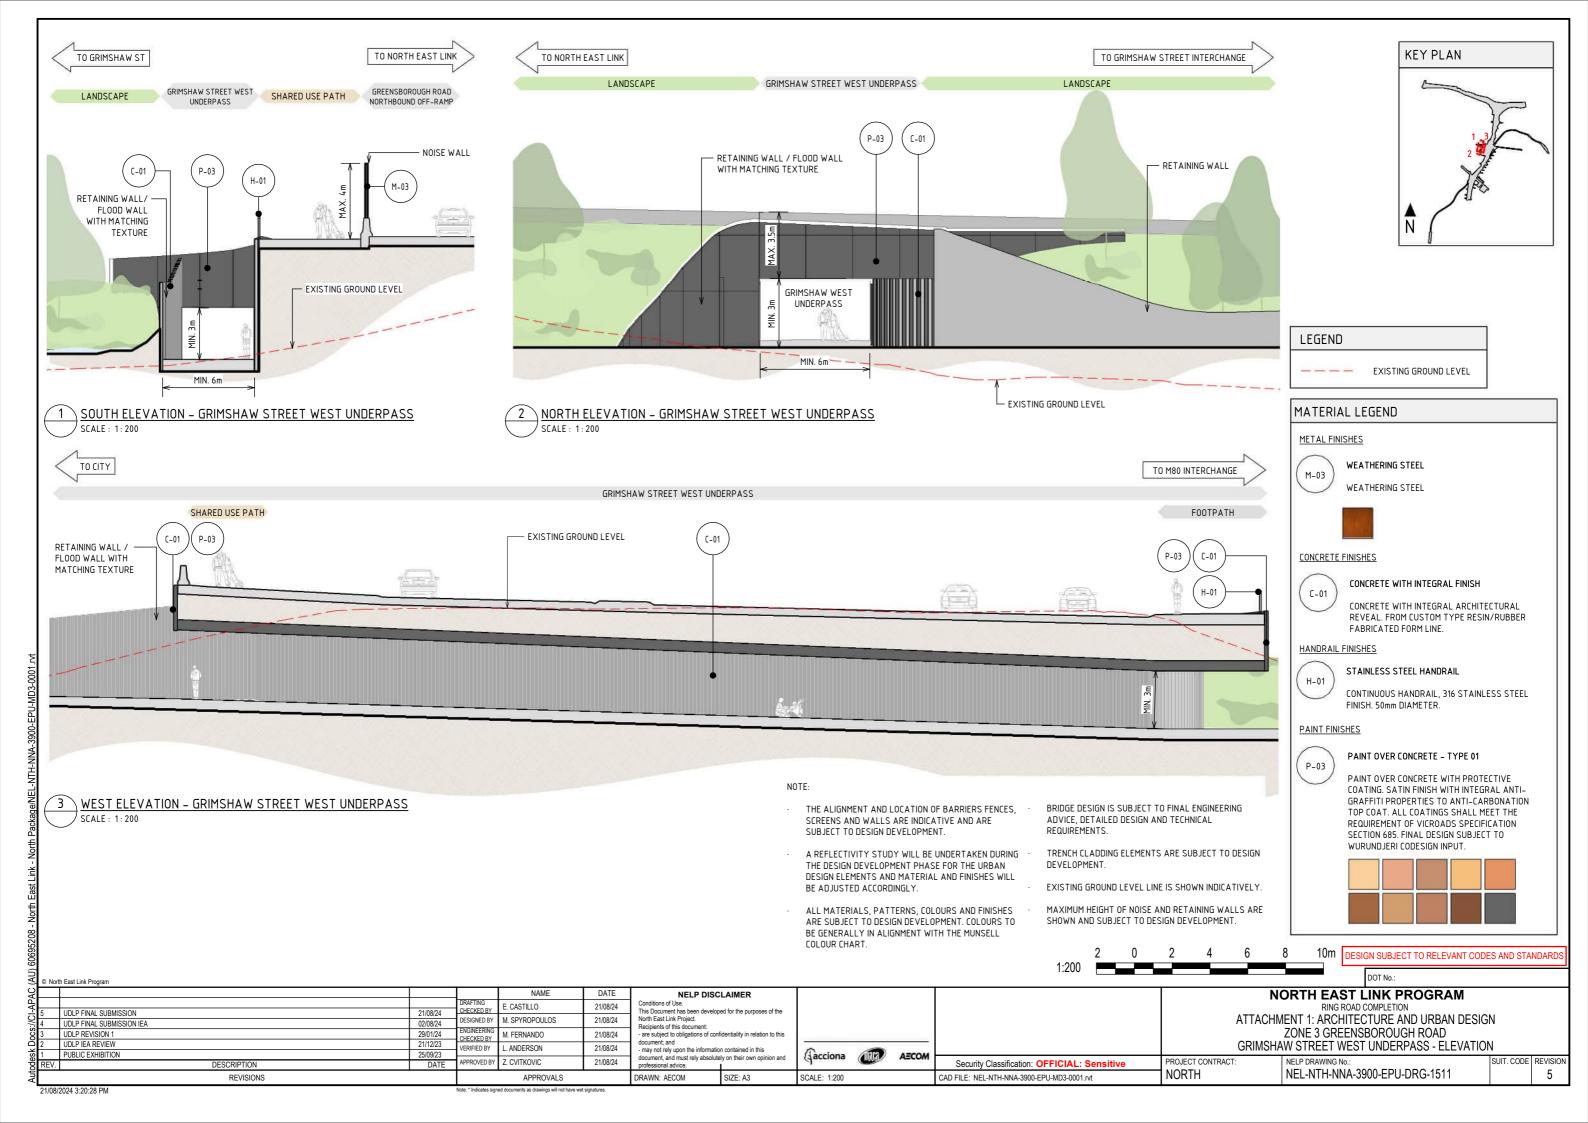
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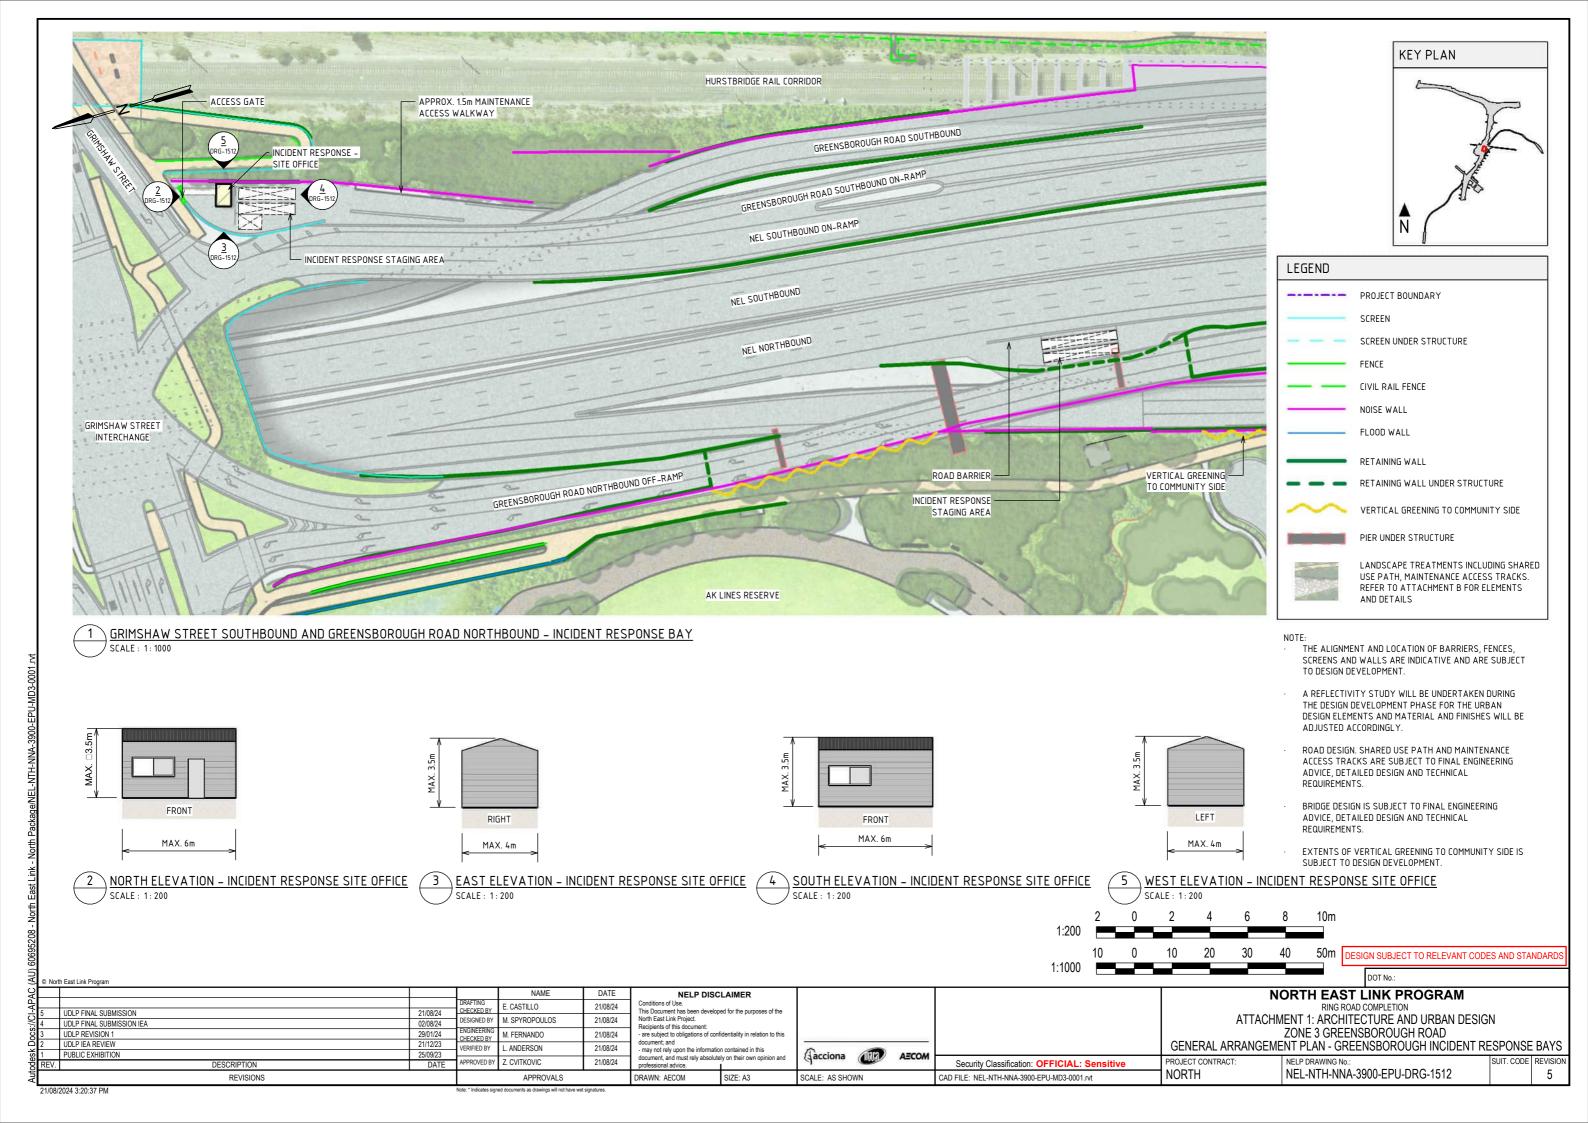
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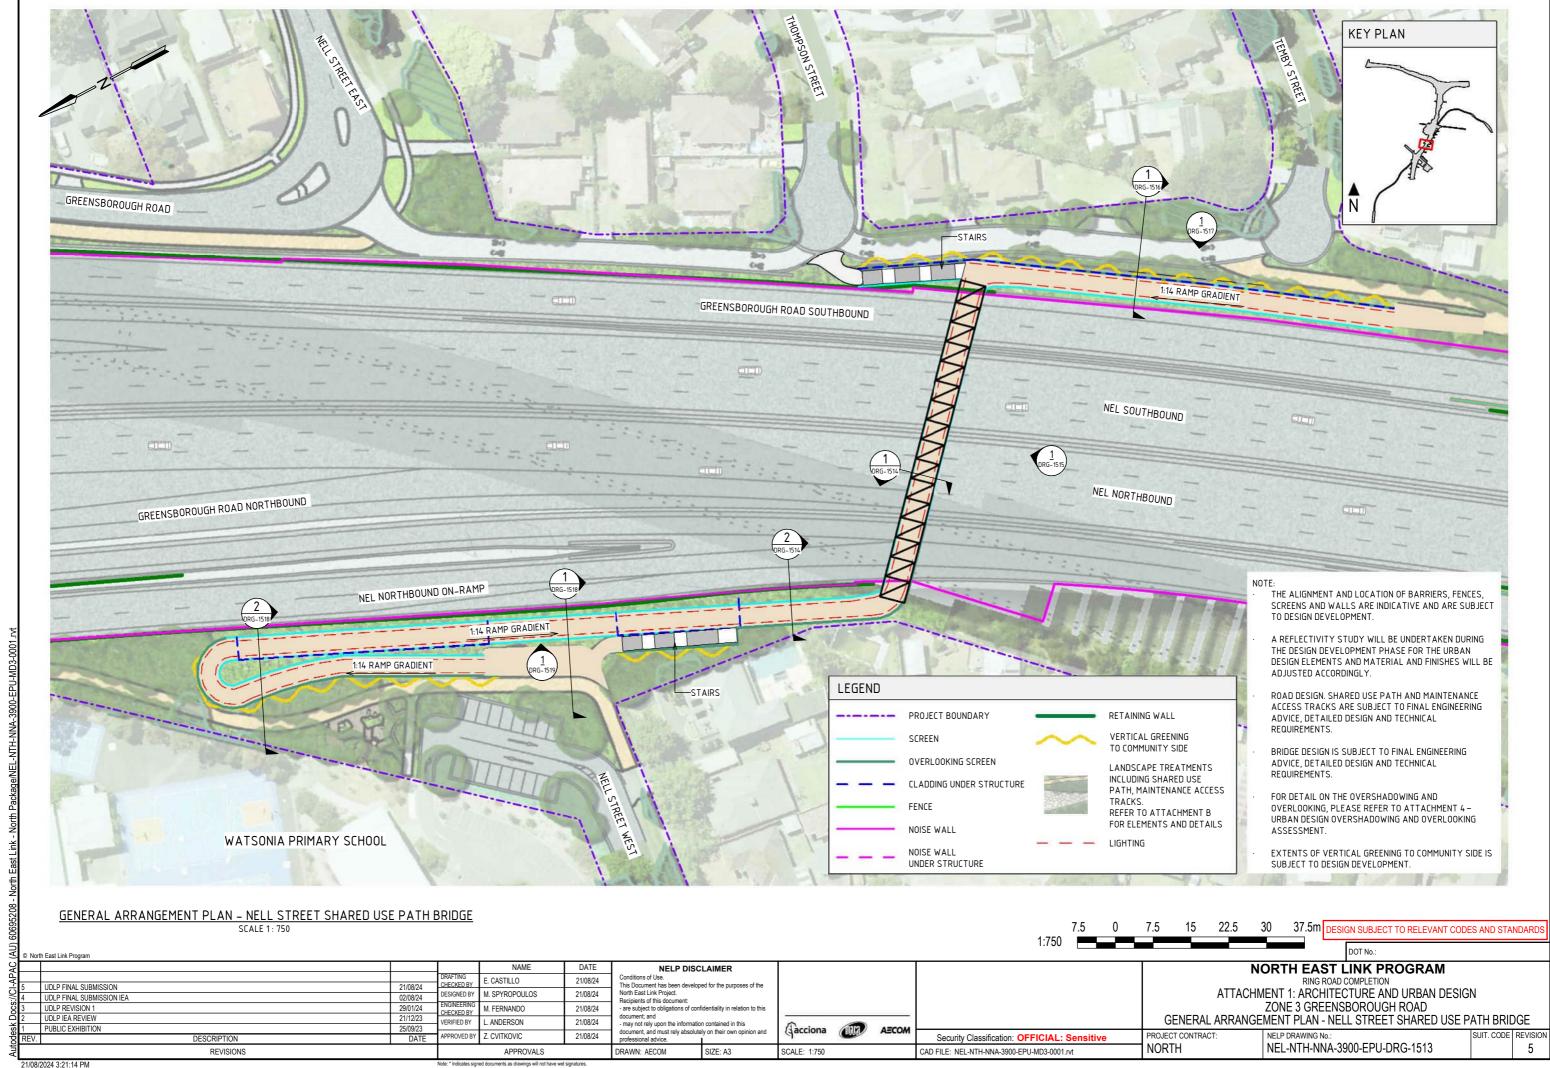
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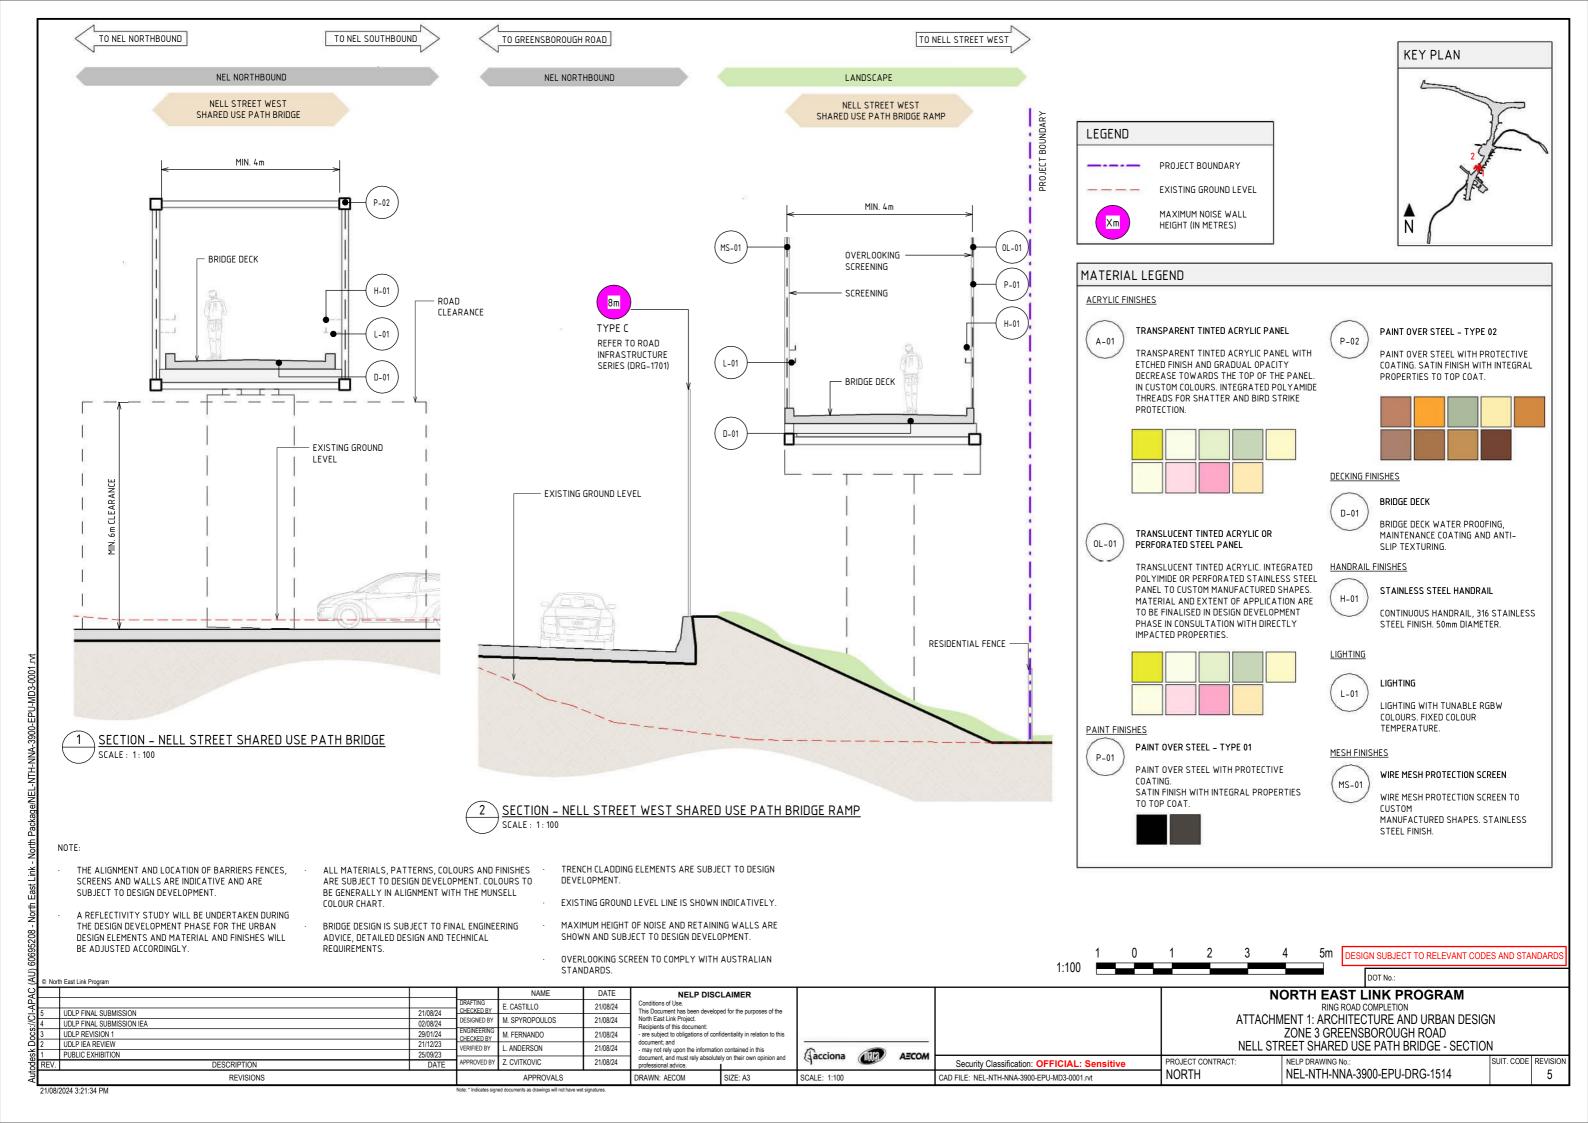
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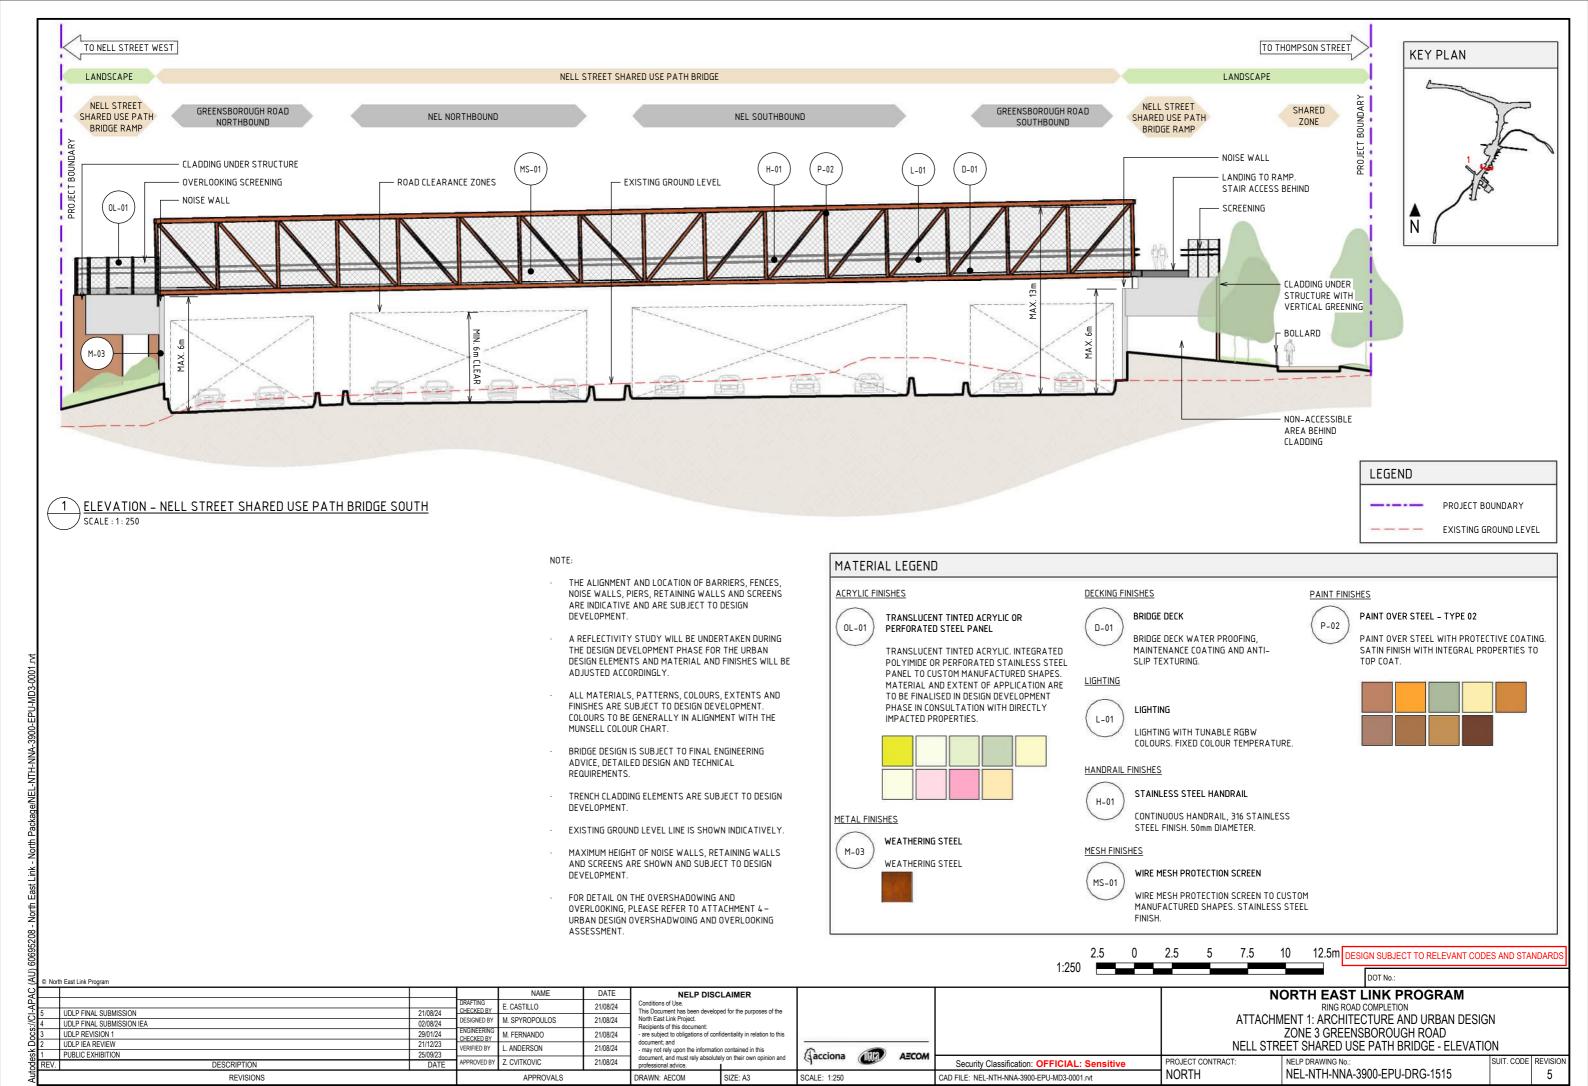











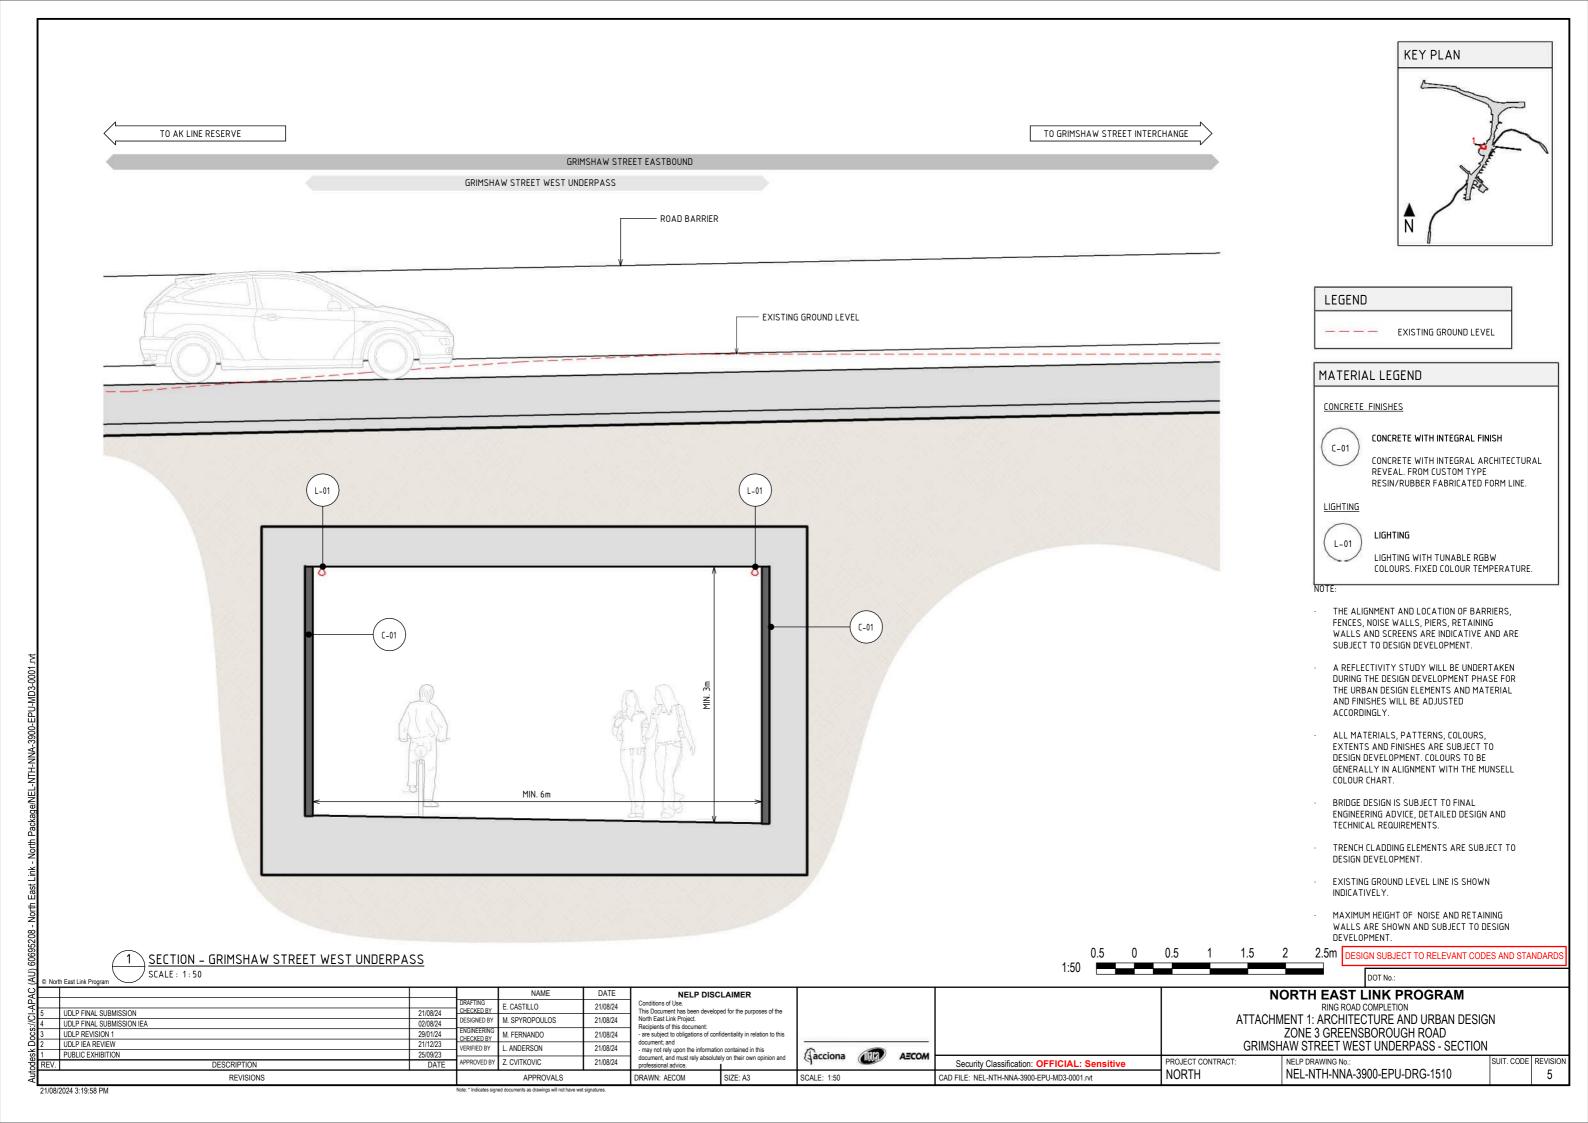

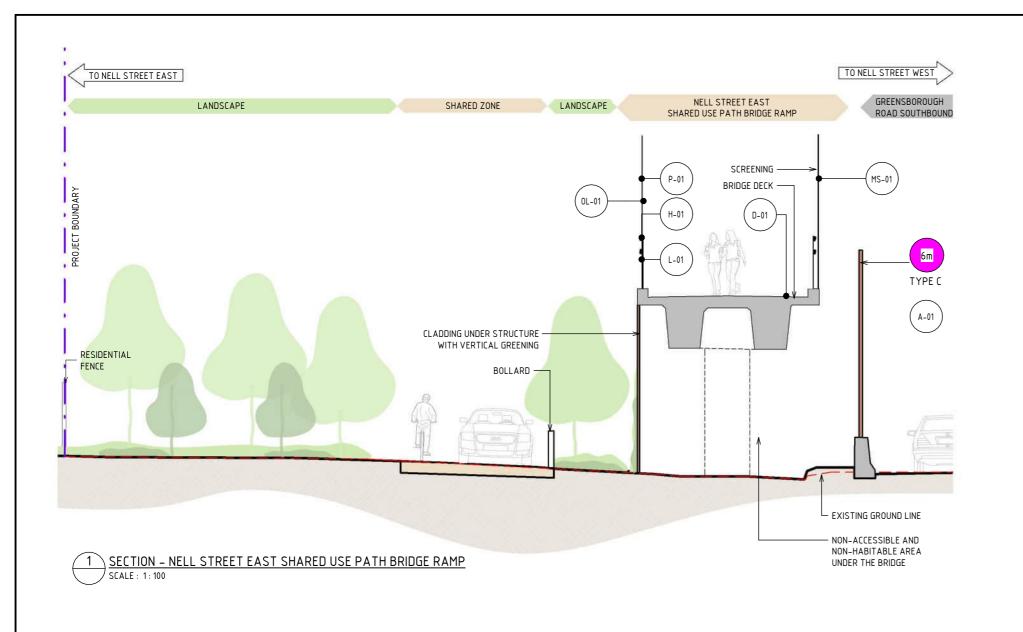

KEY PLAN



MAXIMUM NOISE WALL Χm HEIGHT (IN METRES) MATERIAL LEGEND

ACRYLIC FINISHES PAINT OVER STEEL - TYPE 02 P-02 TRANSPARENT TINTED ACRYLIC PANEL A-01 PAINT OVER STEEL WITH PROTECTIVE TRANSPARENT TINTED ACRYLIC PANEL WITH COATING. SATIN FINISH WITH FTCHED FINISH AND GRADUAL OPACITY INTEGRAL PROPERTIES TO TOP COAT. DECREASE TOWARDS THE TOP OF THE PANEL IN CUSTOM COLOURS, INTEGRATED POLYAMIDE THREADS FOR SHATTER AND BIRD STRIKE PROTECTION **DECKING FINISHES BRIDGE DECK** TRANSLUCENT TINTED ACRYLIC OR D-01 OL-01 PERFORATED STEEL PANEL BRIDGE DECK WATER PROOFING, MAINTENANCE COATING AND ANTI-TRANSLUCENT TINTED ACRYLIC, INTEGRATED SLIP TEXTURING. POLYIMIDE OR PERFORATED STAINLESS STEEL HANDRAIL FINISHES PANEL TO CUSTOM MANUFACTURED SHAPES. MATERIAL AND EXTENT OF APPLICATION ARE STAINLESS STEEL HANDRAIL TO BE FINALISED IN DESIGN DEVELOPMENT H-01 PHASE IN CONSULTATION WITH DIRECTLY CONTINUOUS HANDRAIL, 316 STAINLESS IMPACTED PROPERTIES. STEEL FINISH. 50mm DIAMETER. **LIGHTING** LIGHTING L-01 LIGHTING WITH TUNABLE RGBW COLOURS. FIXED COLOUR PAINT FINISHES TEMPERATURE. PAINT OVER STEEL - TYPE 01 P-01 MESH FINISHES PAINT OVER STEEL WITH PROTECTIVE WIRE MESH PROTECTION SCREEN COATING. MS-01 SATIN FINISH WITH INTEGRAL PROPERTIES WIRE MESH PROTECTION SCREEN TO TO TOP COAT. CUSTOM MANUFACTURED SHAPES. STAINLESS STEEL FINISH.

NOTF:

- THE ALIGNMENT AND LOCATION OF BARRIERS FENCES, SCREENS AND WALLS ARE INDICATIVE AND ARE SUBJECT TO DESIGN DEVELOPMENT
- A REFLECTIVITY STUDY WILL BE UNDERTAKEN DURING THE DESIGN DEVELOPMENT PHASE FOR THE URBAN DESIGN ELEMENTS AND MATERIAL AND FINISHES WILL BE ADJUSTED ACCORDINGLY.
- ALL MATERIALS, PATTERNS, COLOURS AND FINISHES ARE SUBJECT TO DESIGN DEVELOPMENT, COLOURS TO BE GENERALLY IN ALIGNMENT WITH THE MUNSELL COLOUR CHART.
- A SHARED ZONE WILL BE PROVIDED PER THE AUSTROADS GUIDE TO TRAFFIC MANAGEMENT AND INCLUDE A REDUCED SPEED LIMIT TO PRIORITISE PEDESTRIAN AND CYCLING MOVEMENT IN SPATIALLY CONSTRAINED, LOW-TRAFFIC AREAS.

- BRIDGE DESIGN IS SUBJECT TO FINAL ENGINEERING ADVICE, DETAILED DESIGN AND TECHNICAL REQUIREMENTS.
- TRENCH CLADDING ELEMENTS ARE SUBJECT TO DESIGN DEVELOPMENT.
- EXISTING GROUND LEVEL LINE IS SHOWN INDICATIVELY.

MAXIMUM HEIGHT OF NOISE AND RETAINING WALLS ARE SHOWN AND SUBJECT TO DESIGN DEVELOPMENT.

EXTENTS OF VERTICAL GREENING TO COMMUNITY SIDE IS SUBJECT TO DESIGN DEVELOPMENT.

PROJECT CONTRACT

NORTH

DESIGN SUBJECT TO RELEVANT CODES AND STANDAR

SUIT, CODE REVISION

5

North East Link Program NAME DATE NELP DISCLAIMER Conditions of Use.
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acciona AECON SCALE: 1:100

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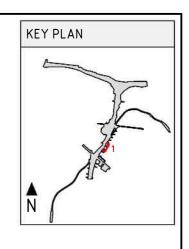
NORTH EAST LINK PROGRAM RING ROAD COMPLETION

ATTACHMENT 1: ARCHITECTURE AND URBAN DESIGN ZONE 3 GREENSBOROUGH ROAD NELL STREET EAST SHARED USE PATH UNDERCROFT - SECTION


NELP DRAWING No.

NEL-NTH-NNA-3900-EPU-DRG-1516

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NAME

APPROVALS

E. CASTILLO

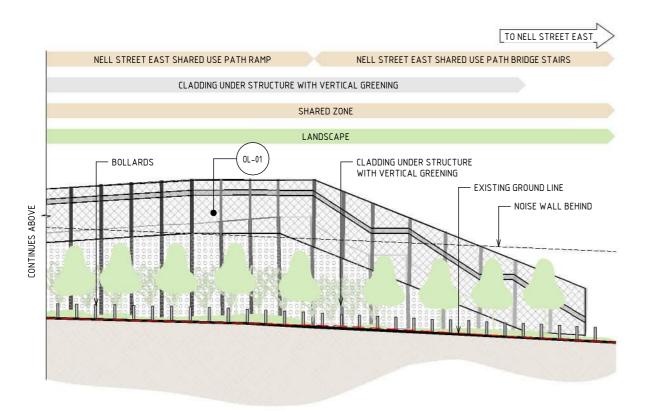M SPYROPOULOS

M. FERNANDO

. ANDERSON

7 CVITKOVIC

CHECKED BY

DESIGNED BY

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ERIFIED BY

APPROVED BY

21/08/24

02/08/24

29/01/24

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ELEVATION - NELL STREET EAST SHARED PATH BRIDGE SCALE: 1: 250

DESCRIPTION

REVISIONS

North East Link Program

UDLP FINAL SUBMISSION

UDLP REVISION 1

UDLP IEA REVIEW

PUBLIC EXHIBITION

UDLP FINAL SUBMISSION IEA

NOTE:

- THE ALIGNMENT AND LOCATION OF BARRIERS, FENCES, NOISE WALLS, PIERS, RETAINING WALLS AND SCREENS ARE INDICATIVE AND ARE SUBJECT TO DESIGN DEVELOPMENT.
- A REFLECTIVITY STUDY WILL BE UNDERTAKEN DURING THE DESIGN DEVELOPMENT PHASE FOR THE URBAN DESIGN ELEMENTS AND MATERIAL AND FINISHES WILL BE ADJUSTED ACCORDINGLY.
- ALL MATERIALS, PATTERNS, COLOURS, EXTENTS AND FINISHES ARE SUBJECT TO DESIGN DEVELOPMENT. COLOURS TO BE GENERALLY IN ALIGNMENT WITH THE MUNSELL COLOUR CHART.
- BRIDGE DESIGN IS SUBJECT TO FINAL ENGINEERING ADVICE, DETAILED DESIGN AND TECHNICAL REQUIREMENTS.
- TRENCH CLADDING ELEMENTS ARE SUBJECT TO DESIGN DEVELOPMENT.
- EXISTING GROUND LEVEL LINE IS SHOWN INDICATIVELY.
- MAXIMUM HEIGHT OF NOISE WALLS, RETAINING WALLS AND SCREENS ARE SHOWN AND SUBJECT TO DESIGN DEVELOPMENT.
- FOR DETAIL ON THE OVERSHADOWING AND OVERLOOKING, PLEASE REFER TO ATTACHMENT 4-URBAN DESIGN OVERSHADWOING AND OVERLOOKING ASSESSMENT.

acciona

SCALE: 1:250

EXTENTS OF VERTICAL GREENING TO COMMUNITY SIDE IS SUBJECT TO DESIGN DEVELOPMENT.

AECON

MATERIAL LEGEND

ACRYLIC FINISHES

0L-01

TRANSLUCENT TINTED ACRYLIC OR PERFORATED STEEL PANEL

TRANSLUCENT TINTED ACRYLIC. INTEGRATED POLYIMIDE OR PERFORATED STAINLESS STEEL PANEL TO CUSTOM MANUFACTURED SHAPES. MATERIAL AND EXTENT OF APPLICATION ARE TO BE FINALISED IN DESIGN DEVELOPMENT PHASE IN CONSULTATION WITH DIRECTLY IMPACTED PROPERTIES.



DECKING FINISHES

D-01

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CAD FILE: NEL-NTH-NNA-3900-EPU-MD3-0001.rvt

BRIDGE DECK WATER PROOFING, MAINTENANCE COATING AND ANTI-SLIP TEXTURING.

NORTH

PAINT FINISHES



PAINT OVER STEEL - TYPE 01

PAINT OVER STEEL WITH PROTECTIVE COATING. SATIN FINISH WITH INTEGRAL PROPERTIES TO TOP COAT.



LIGHTING



LIGHTING

LIGHTING WITH TUNABLE RGBW COLOURS. FIXED COLOUR TEMPERATURE.

HANDRAIL FINISHES



STAINLESS STEEL HANDRAIL

CONTINUOUS HANDRAIL, 316 STAINLESS STEEL FINISH. 50mm DIAMETER.

MESH FINISHES



WIRE MESH PROTECTION SCREEN

WIRE MESH PROTECTION SCREEN TO CUSTOM MANUFACTURED SHAPES. STAINLESS STEEL FINISH

DESIGN SUBJECT TO RELEVANT CODES AND STANDAR

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BRIDGE DECK

NORTH EAST LINK PROGRAM RING ROAD COMPLETION

ATTACHMENT 1: ARCHITECTURE AND URBAN DESIGN ZONE 3 GREENSBOROUGH ROAD


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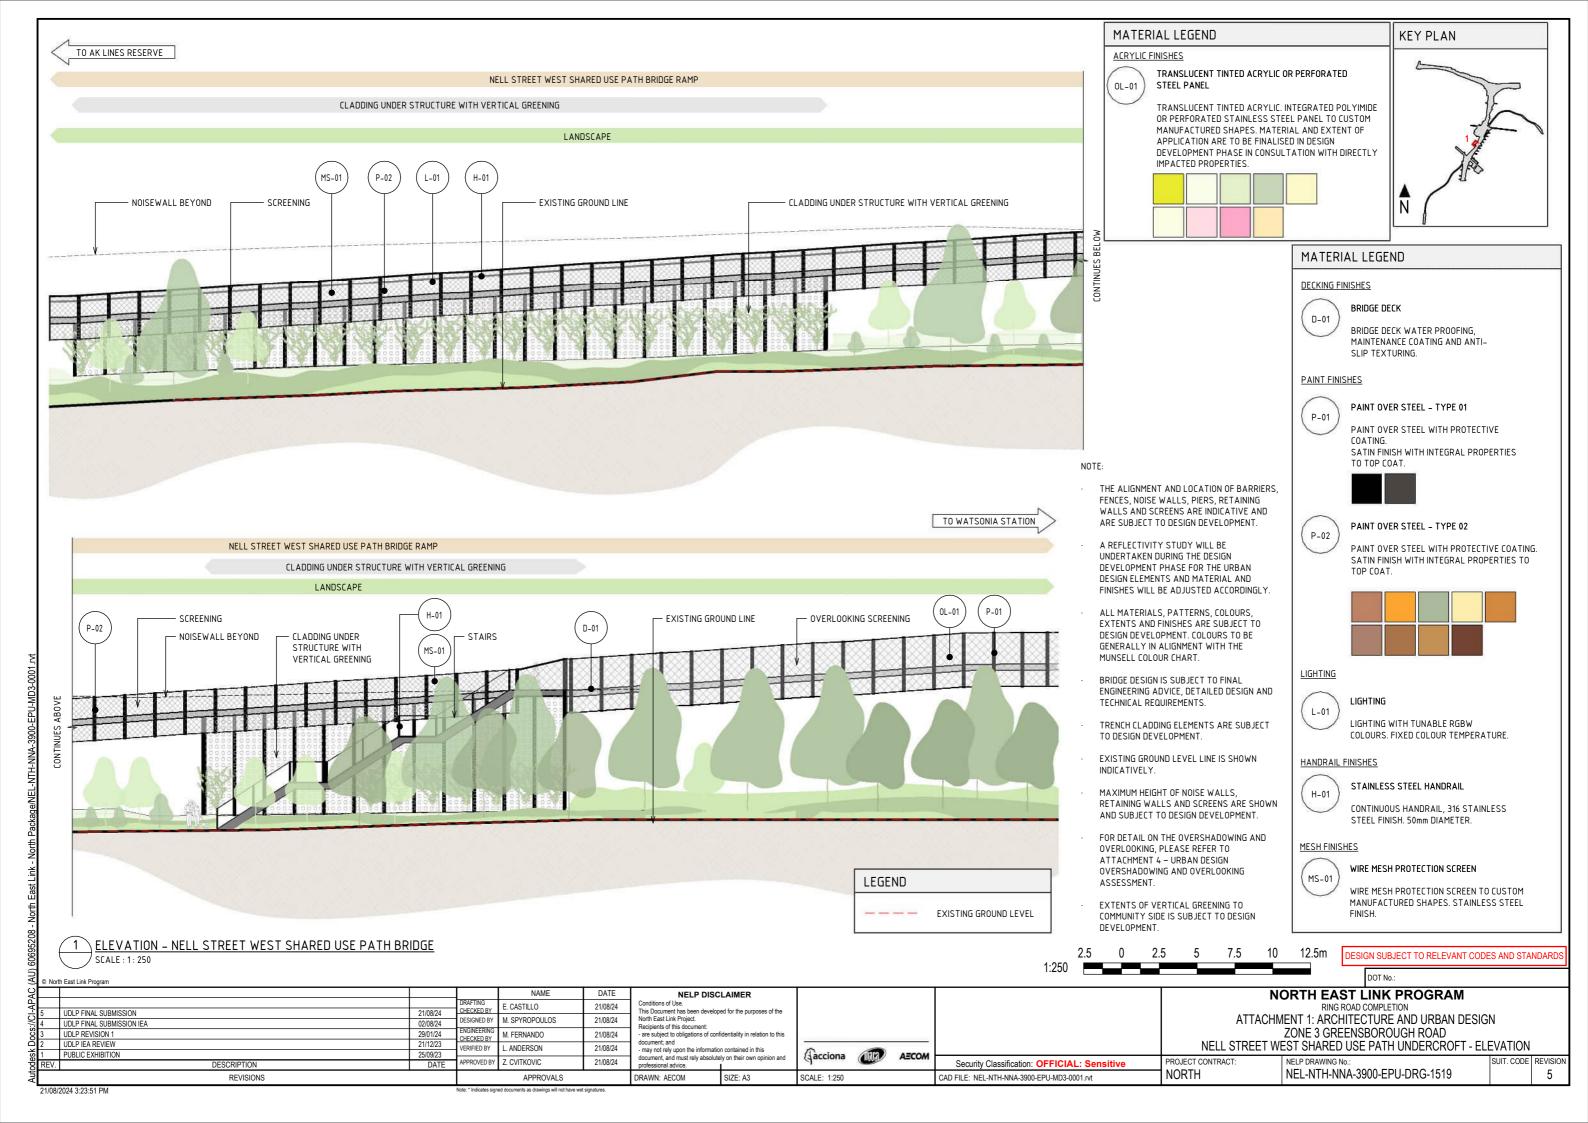
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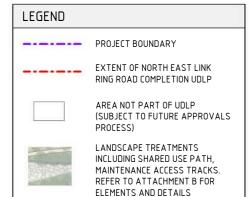




ZONE 4 WATSONIA PRECINCT


DRAWING INDEX

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LOCALITY PLAN	NEL-NTH-NNA-3900-EPU-DRG-1601
GENERAL ARRANGEMENT PLANS - HURSTBRIDGE RAIL TUNNEL AND SECTION	NEL-NTH-NNA-3900-EPU-DRG-1602
GENERAL ARRANGEMENT PLANS - HURSTBRIDGE RAIL TUNNEL SERVICES	NEL-NTH-NNA-3900-EPU-DRG-1603
GENERAL ARRANGEMENT PLANS - ELDER STREET LAND BRIDGE PLAN	NEL-NTH-NNA-3900-EPU-DRG-1604
SECTIONS AND ELEVATIONS - ELDER STREET LAND BRIDGE	NEL-NTH-NNA-3900-EPU-DRG-1605
GENERAL ARRANGEMENT PLANS - RASHEDA STREET PLAN	NEL-NTH-NNA-3900-EPU-DRG-1606
ELEVATIONS - RASHEDA STREET	NEL-NTH-NNA-3900-EPU-DRG-1607
GENERAL ARRANGEMENT PLANS - WATSONIA ROAD LAND BRIDGE PLAN	NEL-NTH-NNA-3900-EPU-DRG-1608
ELEVATIONS - WATSONIA ROAD LAND BRIDGE	NEL-NTH-NNA-3900-EPU-DRG-1609
ELEVATIONS - WATSONIA ROAD LAND BRIDGE	NEL-NTH-NNA-3900-EPU-DRG-1610
GENERAL ARRANGEMENT PLANS - RAIL LUBRICATOR	NEL-NTH-NNA-3900-EPU-DRG-1611

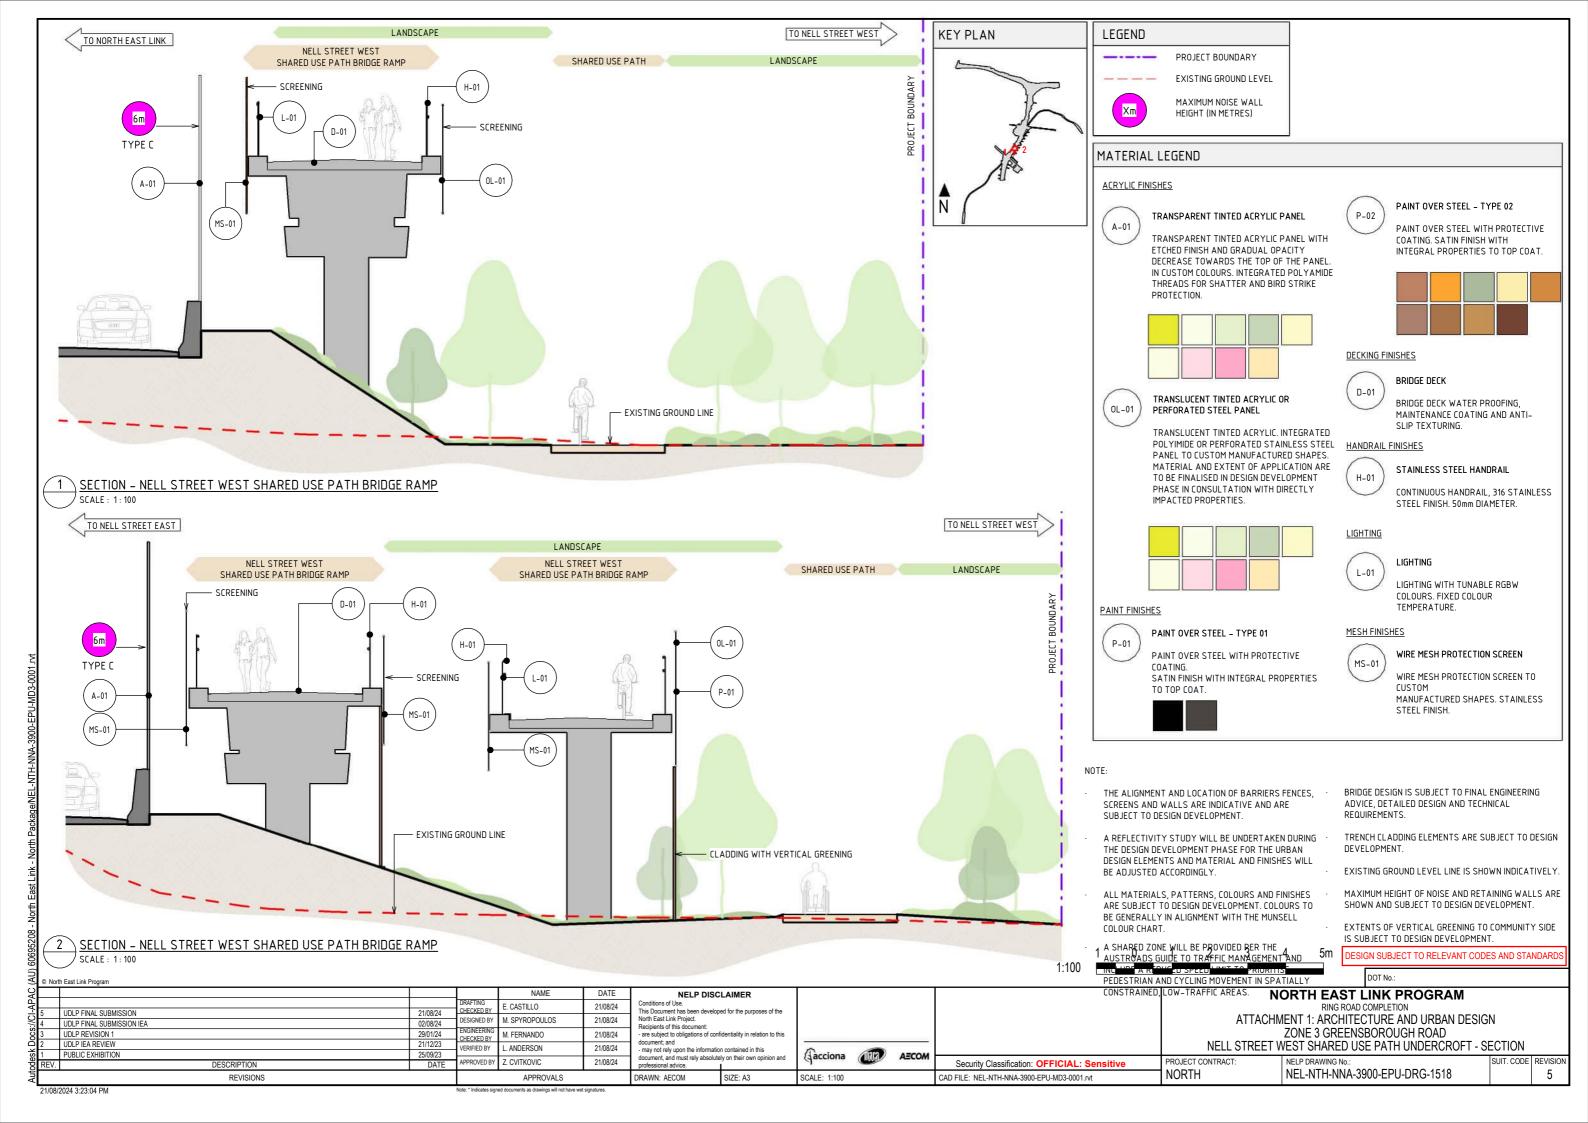

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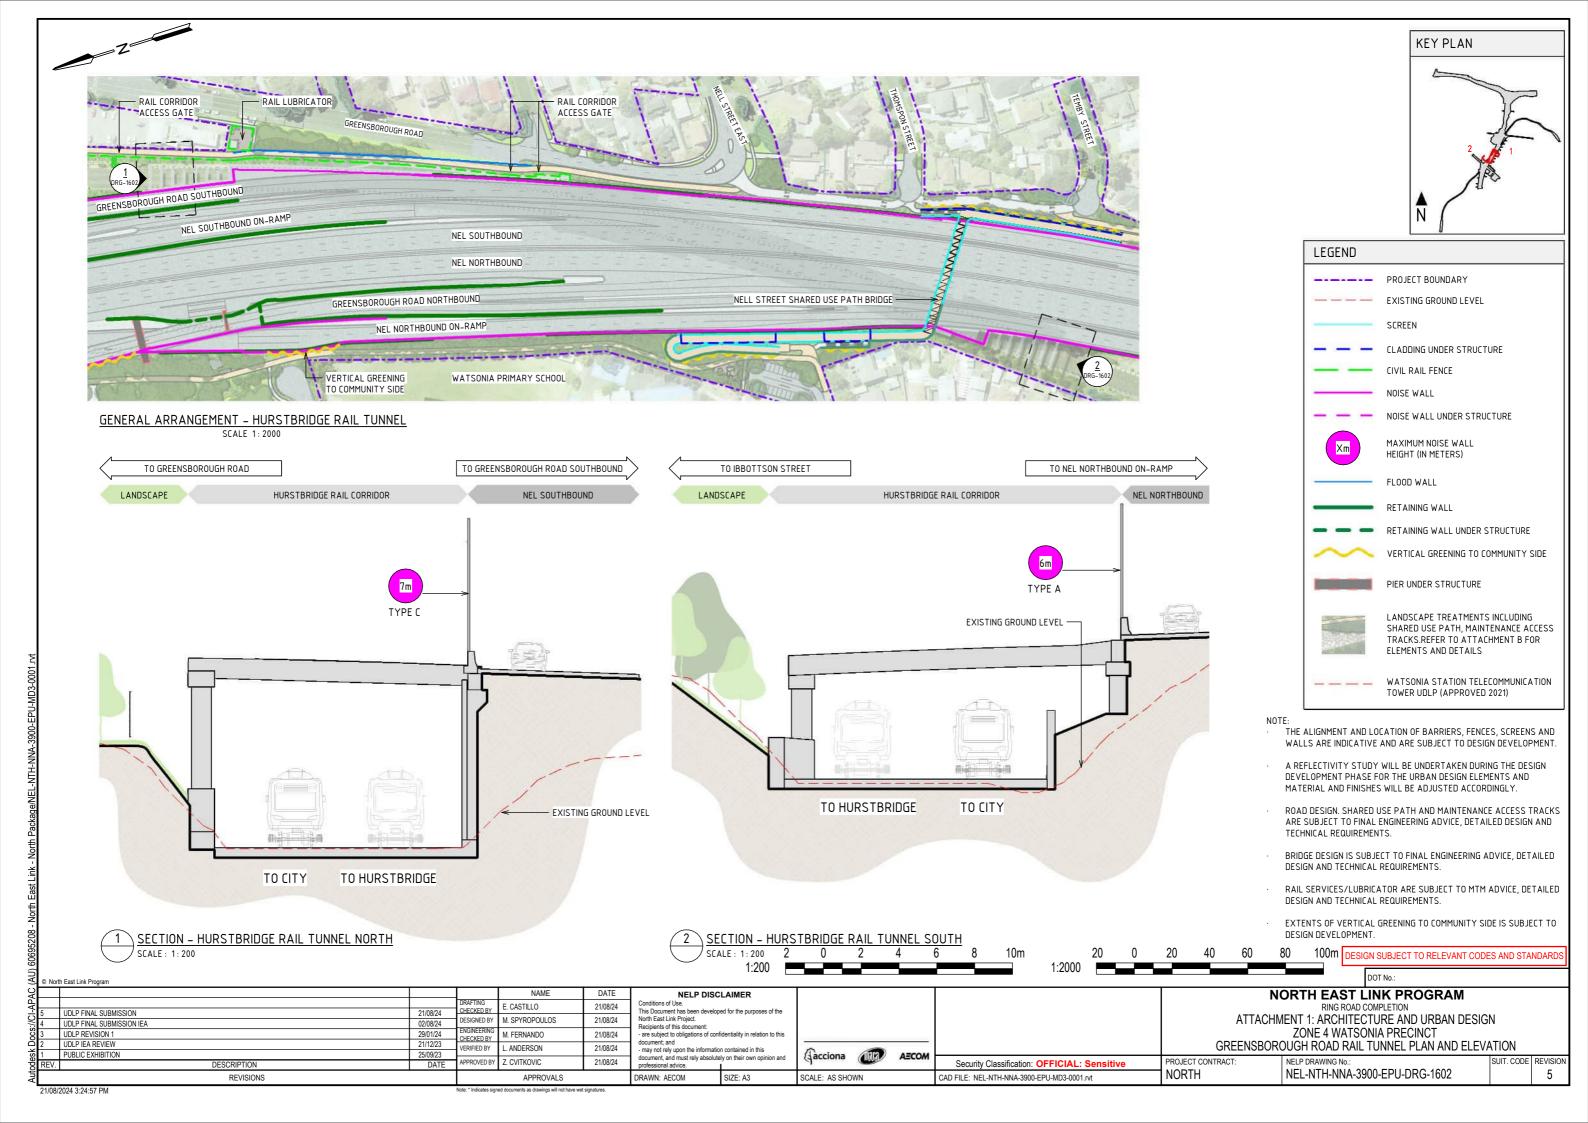
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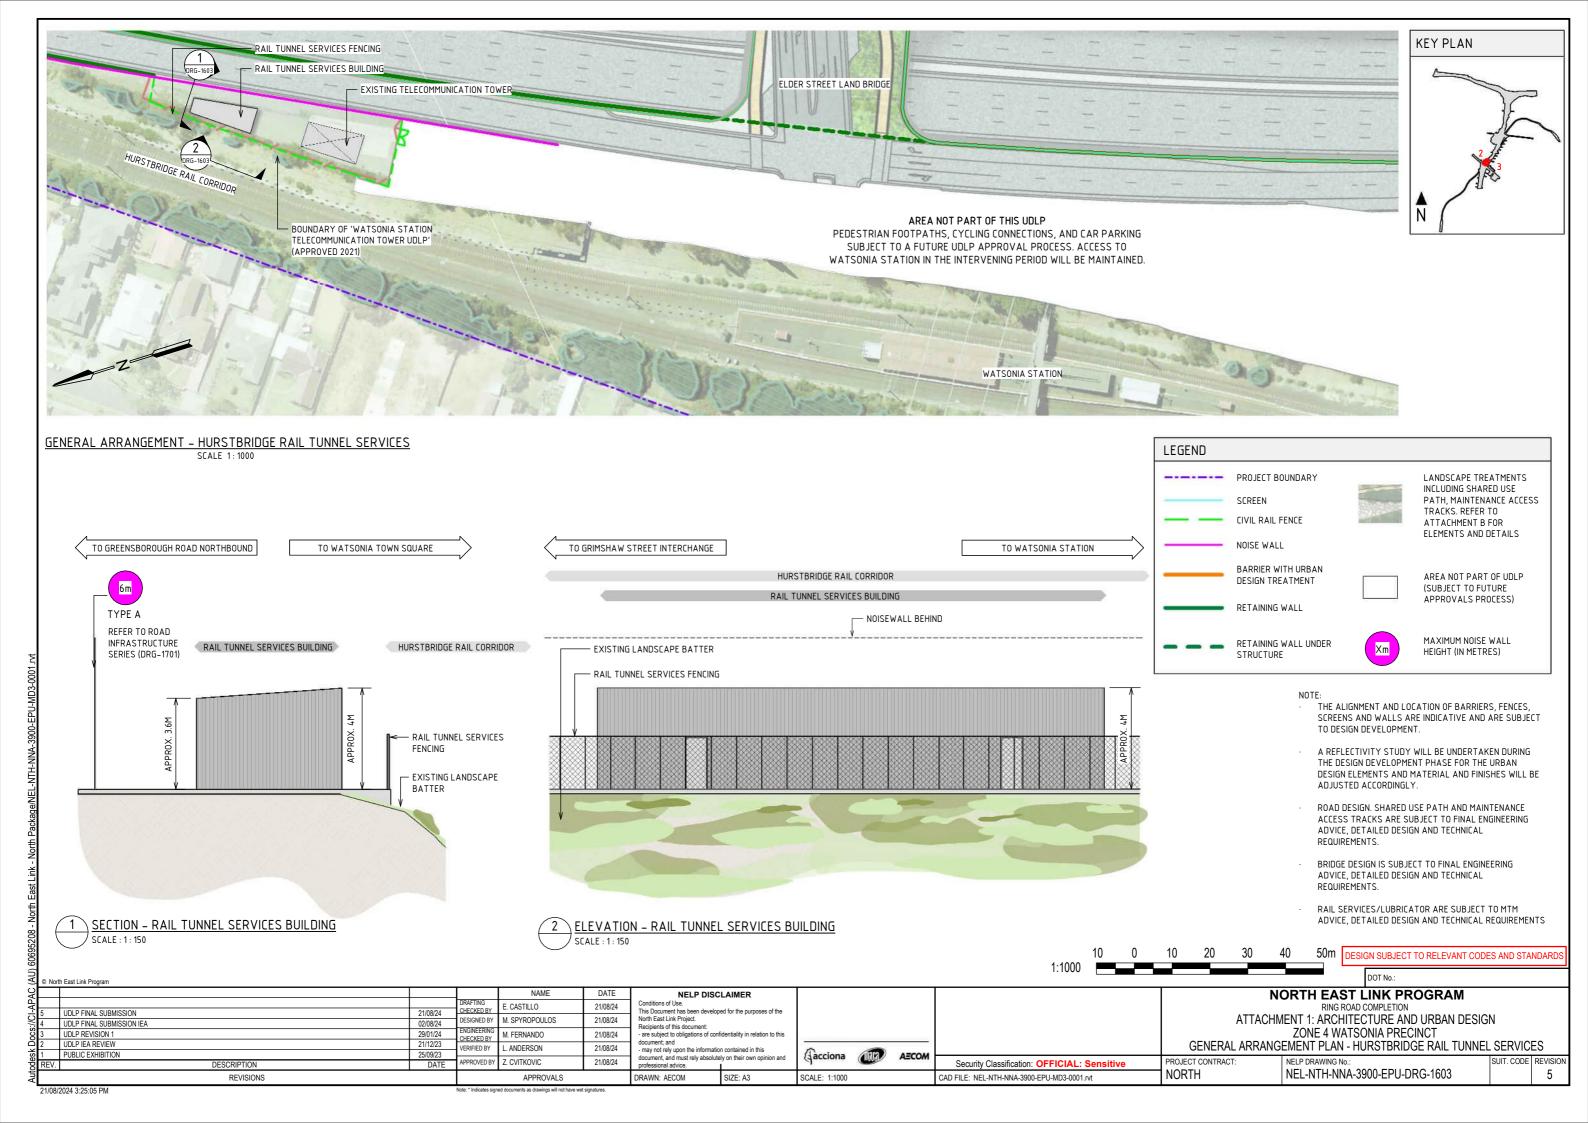
. CASTILLO 21/08/24 UDLP FINAL SUBMISSION M SPYROPOULOS 21/08/24 DESIGNED BY UDLP FINAL SUBMISSION IEA 02/08/24 M. FERNANDO 21/08/24 UDLP REVISION 1 CHECKED BY UDLP IEA REVIEW . ANDERSON 21/08/24 ERIFIED BY PUBLIC EXHIBITION APPROVED BY 7 CVITKOVIC 21/08/24 DESCRIPTION


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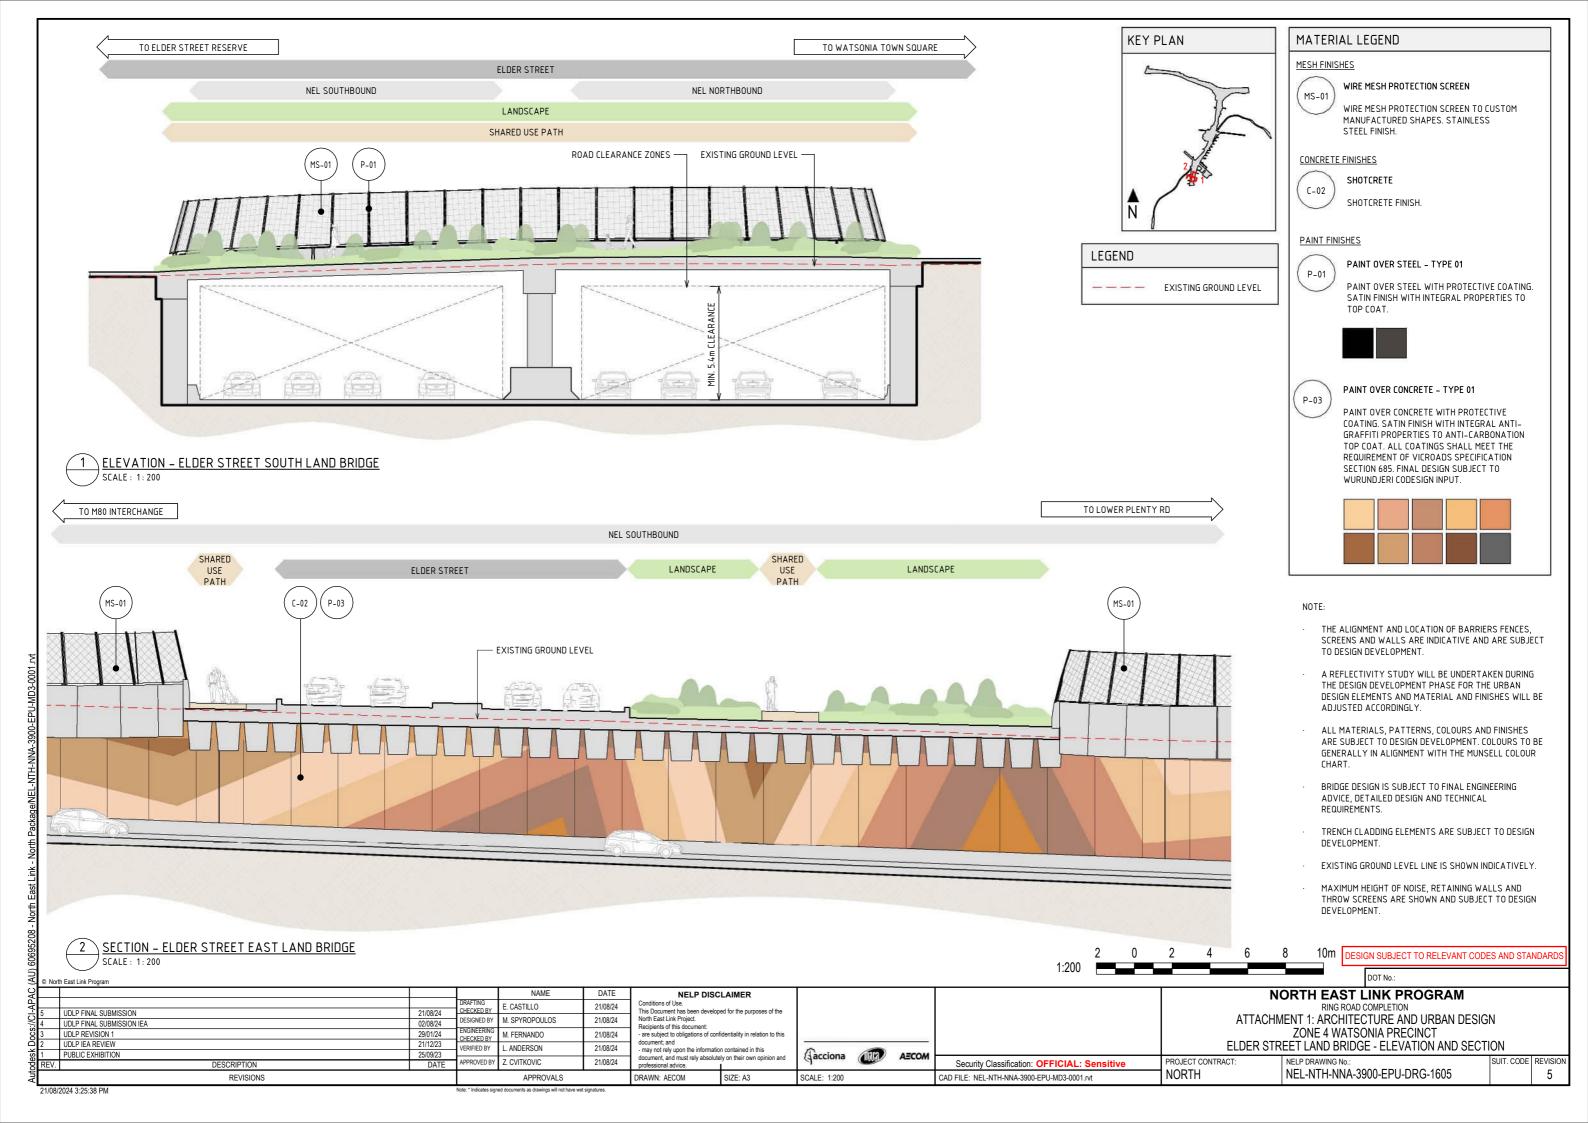
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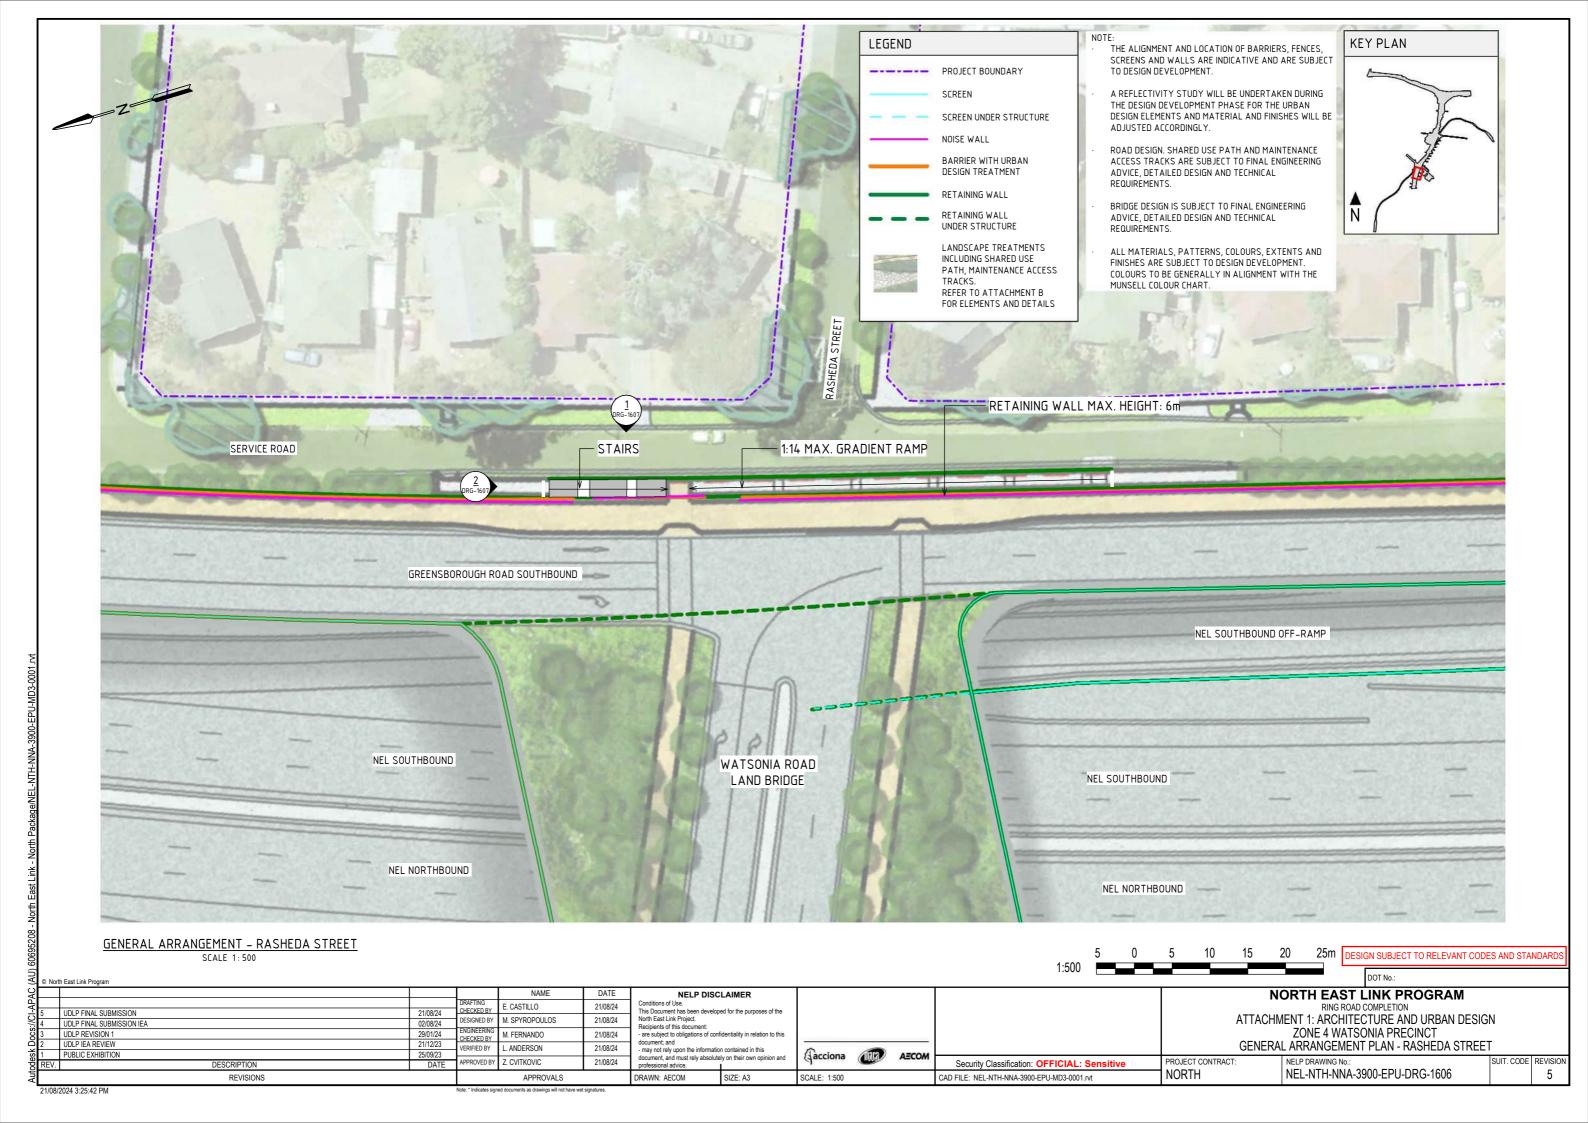
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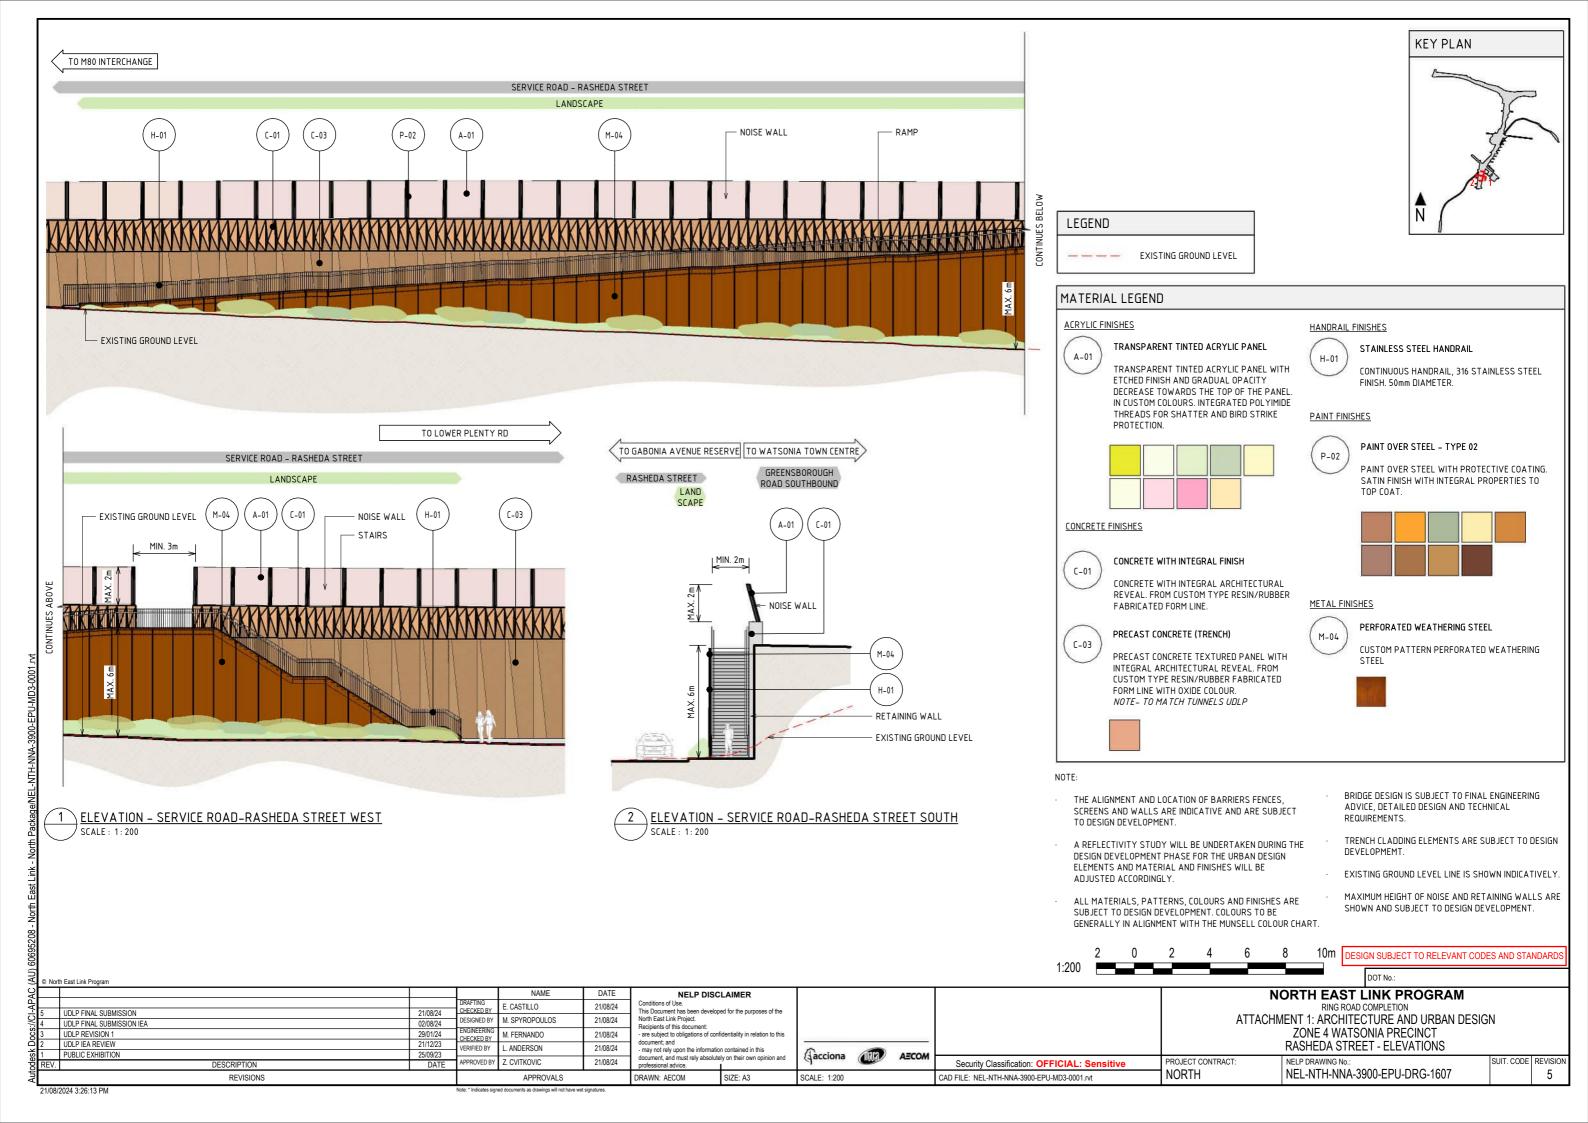


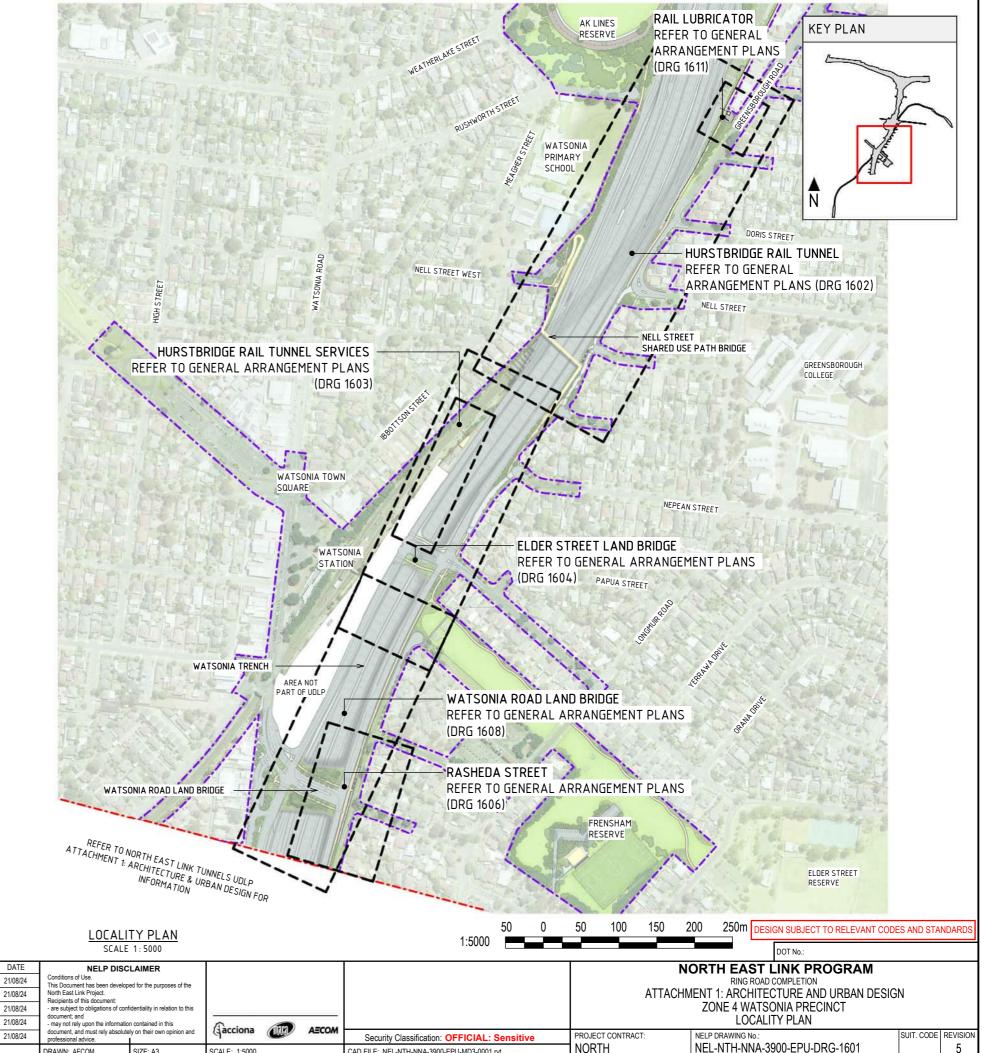









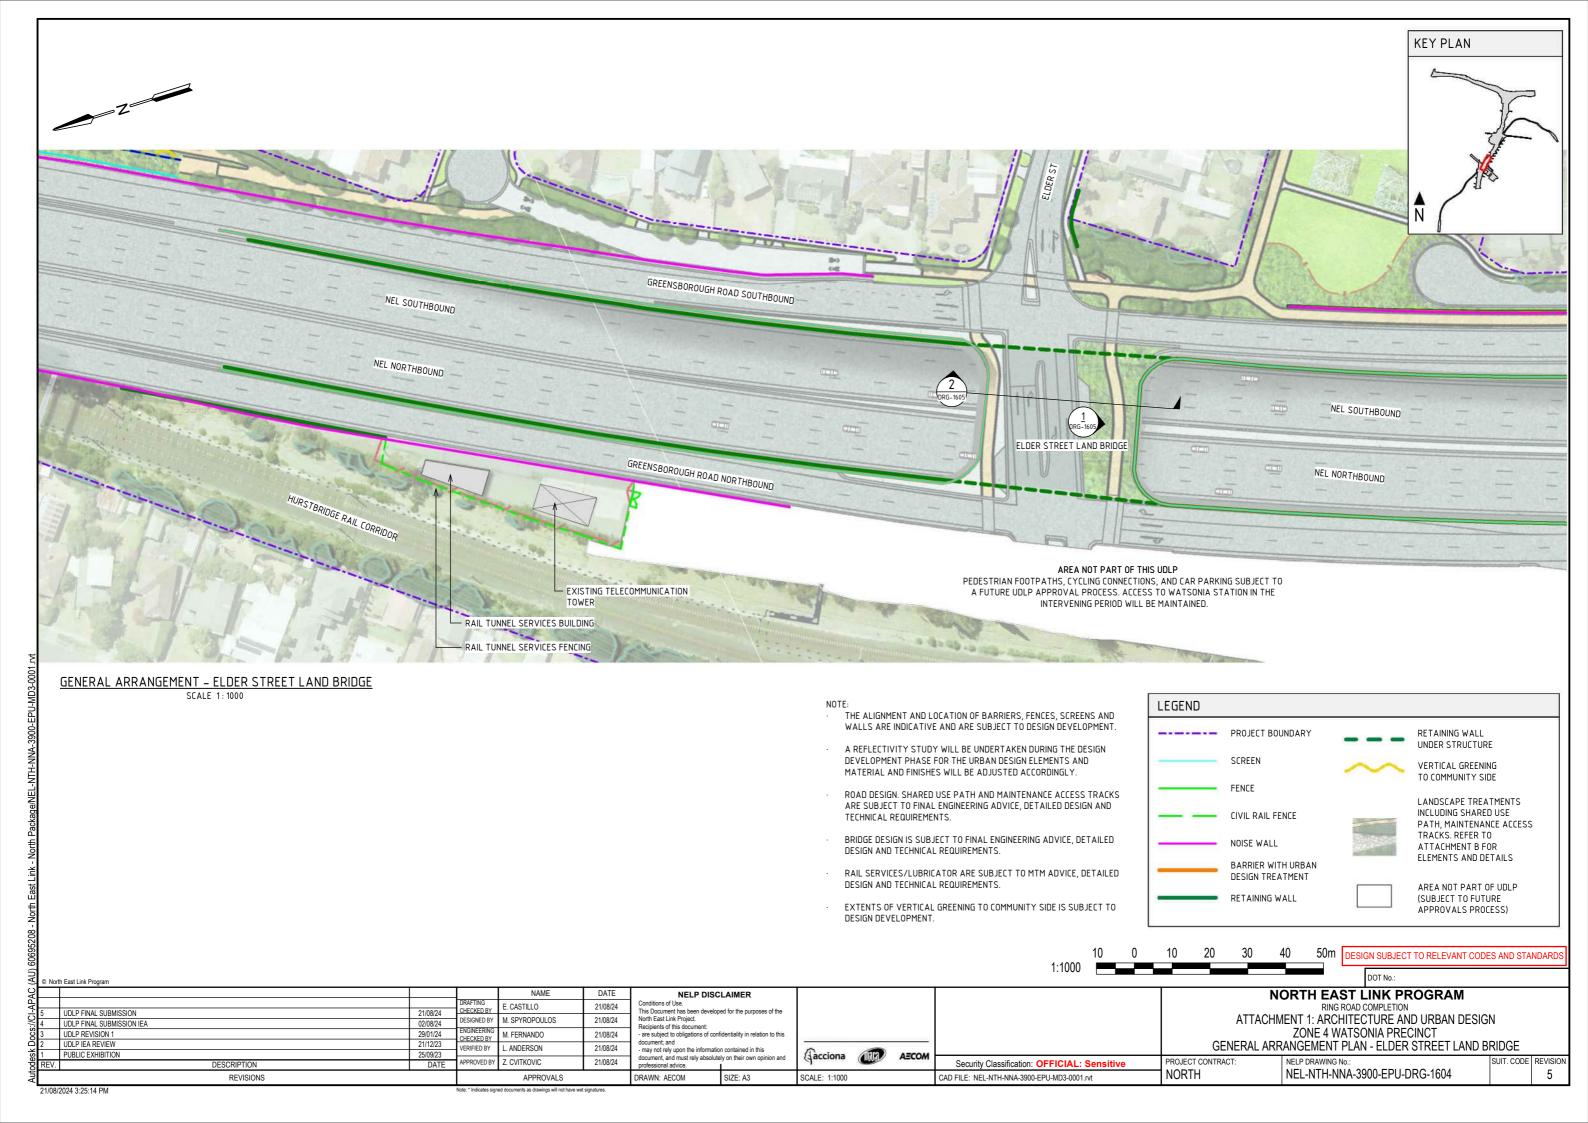

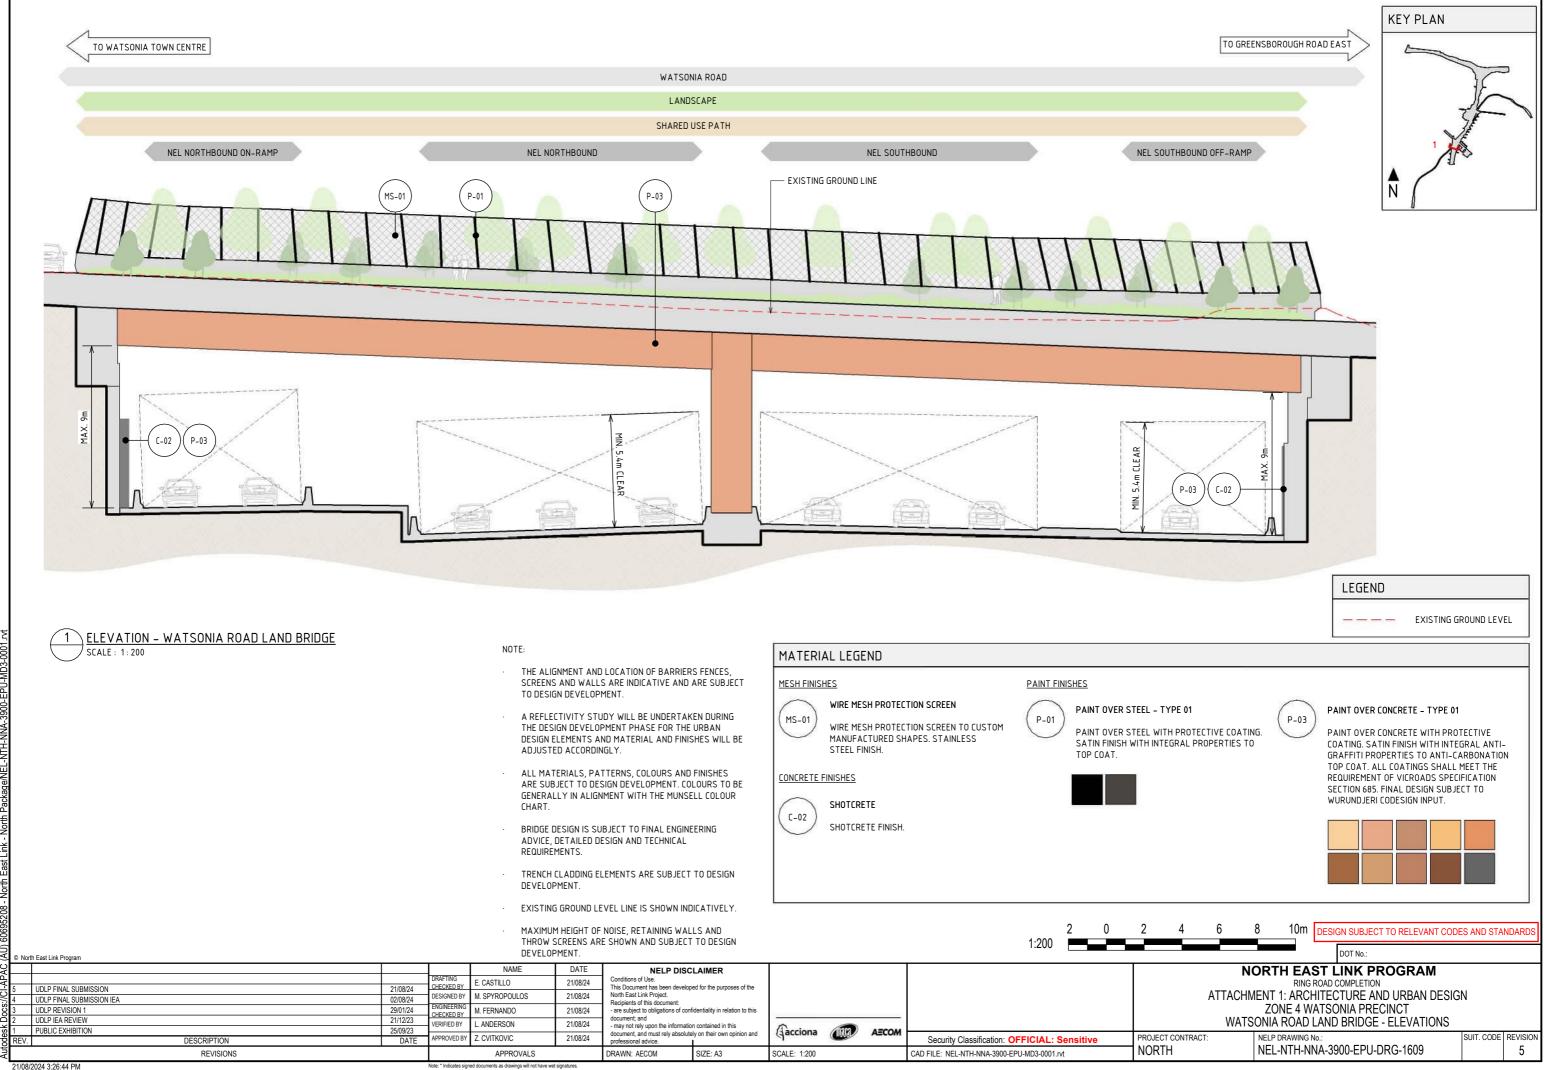

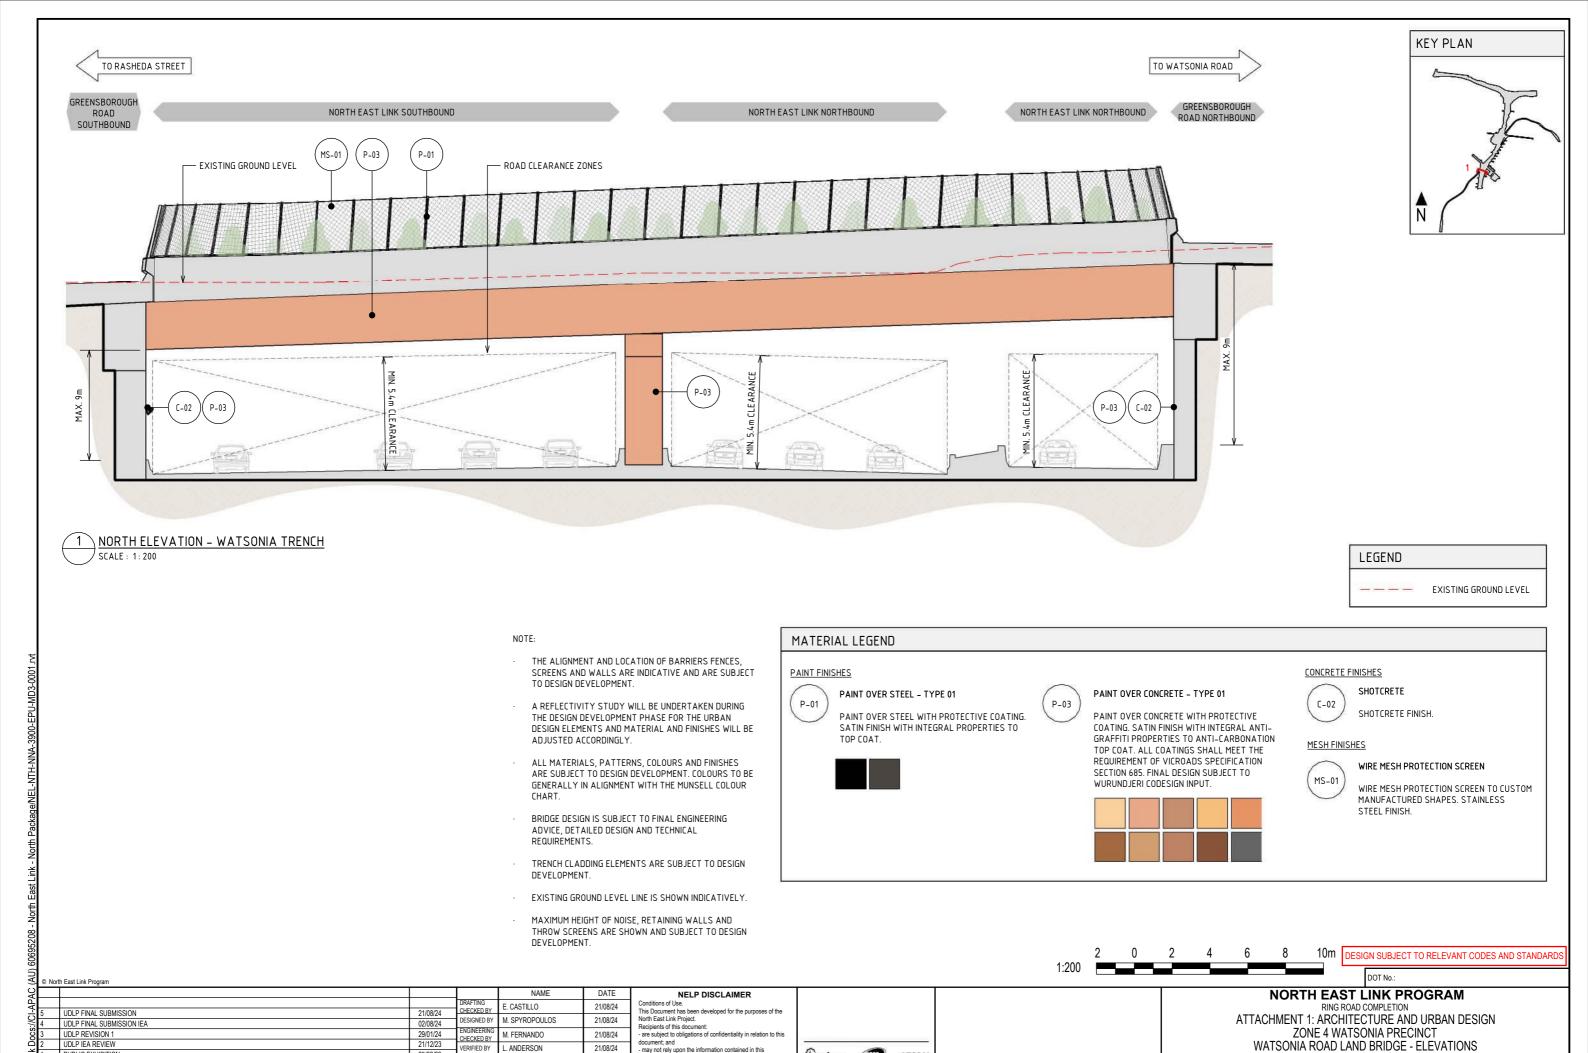

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SCALE: 1:200

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CAD FILE: NEL-NTH-NNA-3900-EPU-MD3-0001.rvt

PROJECT CONTRACT

NORTH

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NEL-NTH-NNA-3900-EPU-DRG-1610

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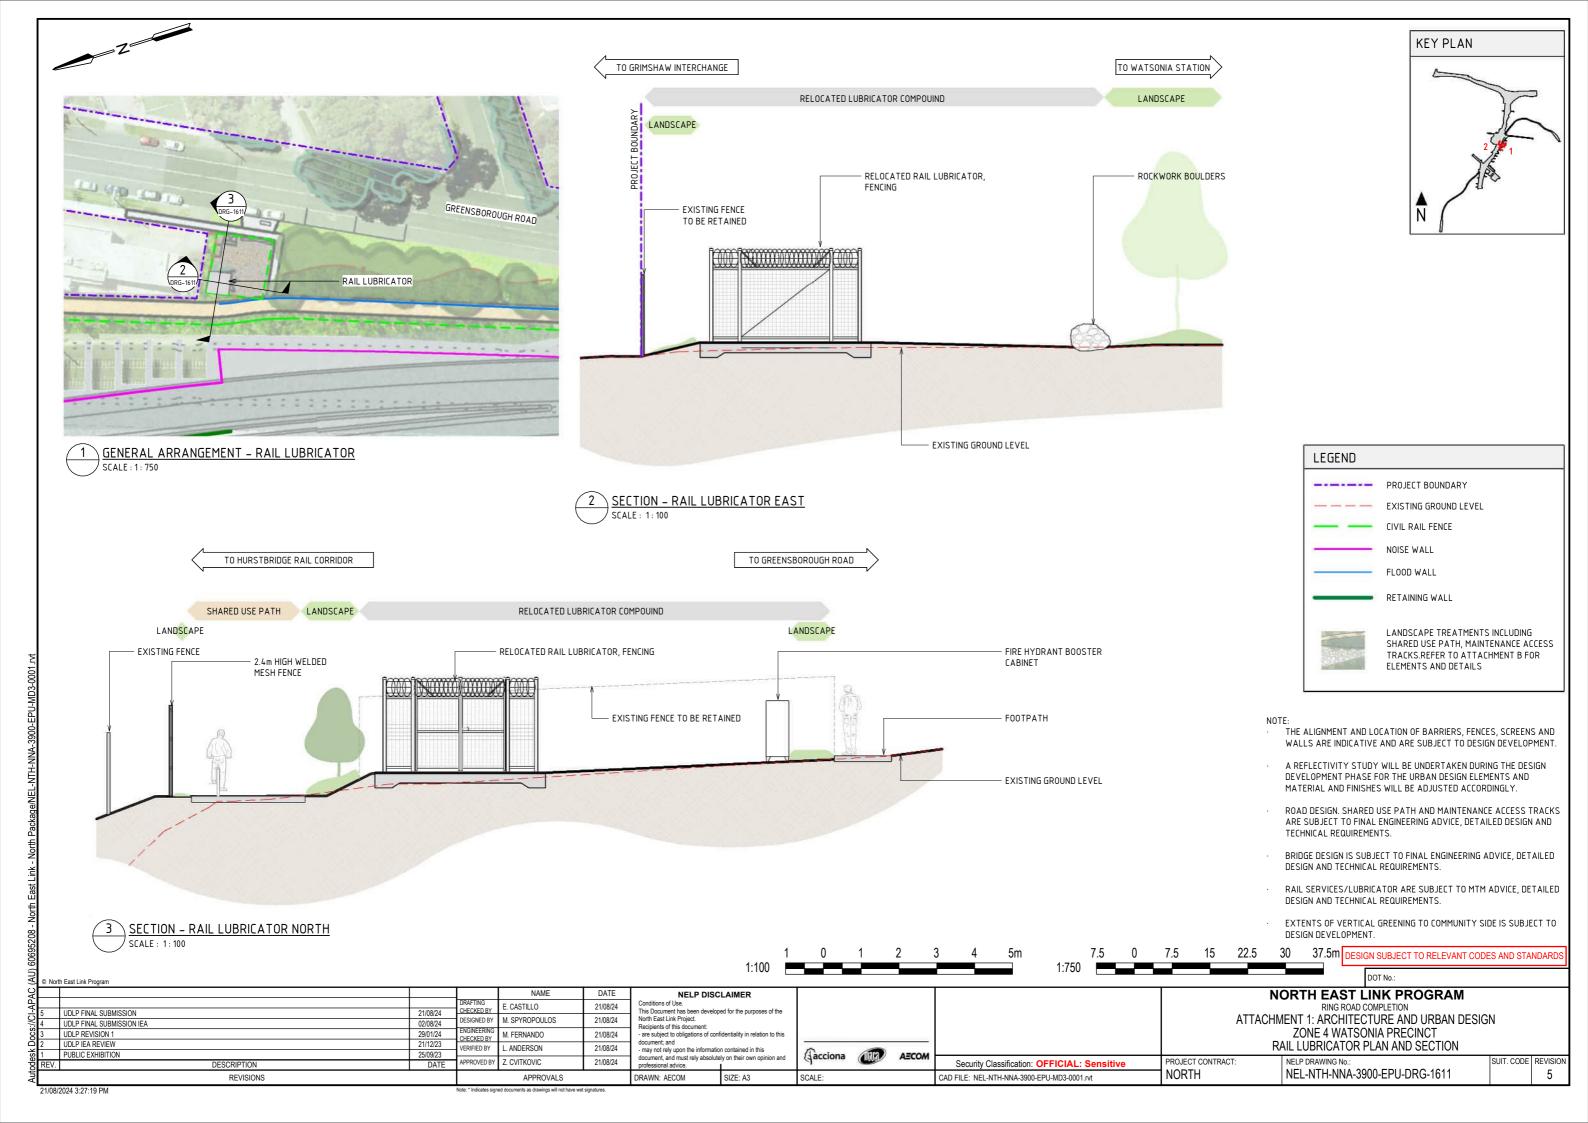
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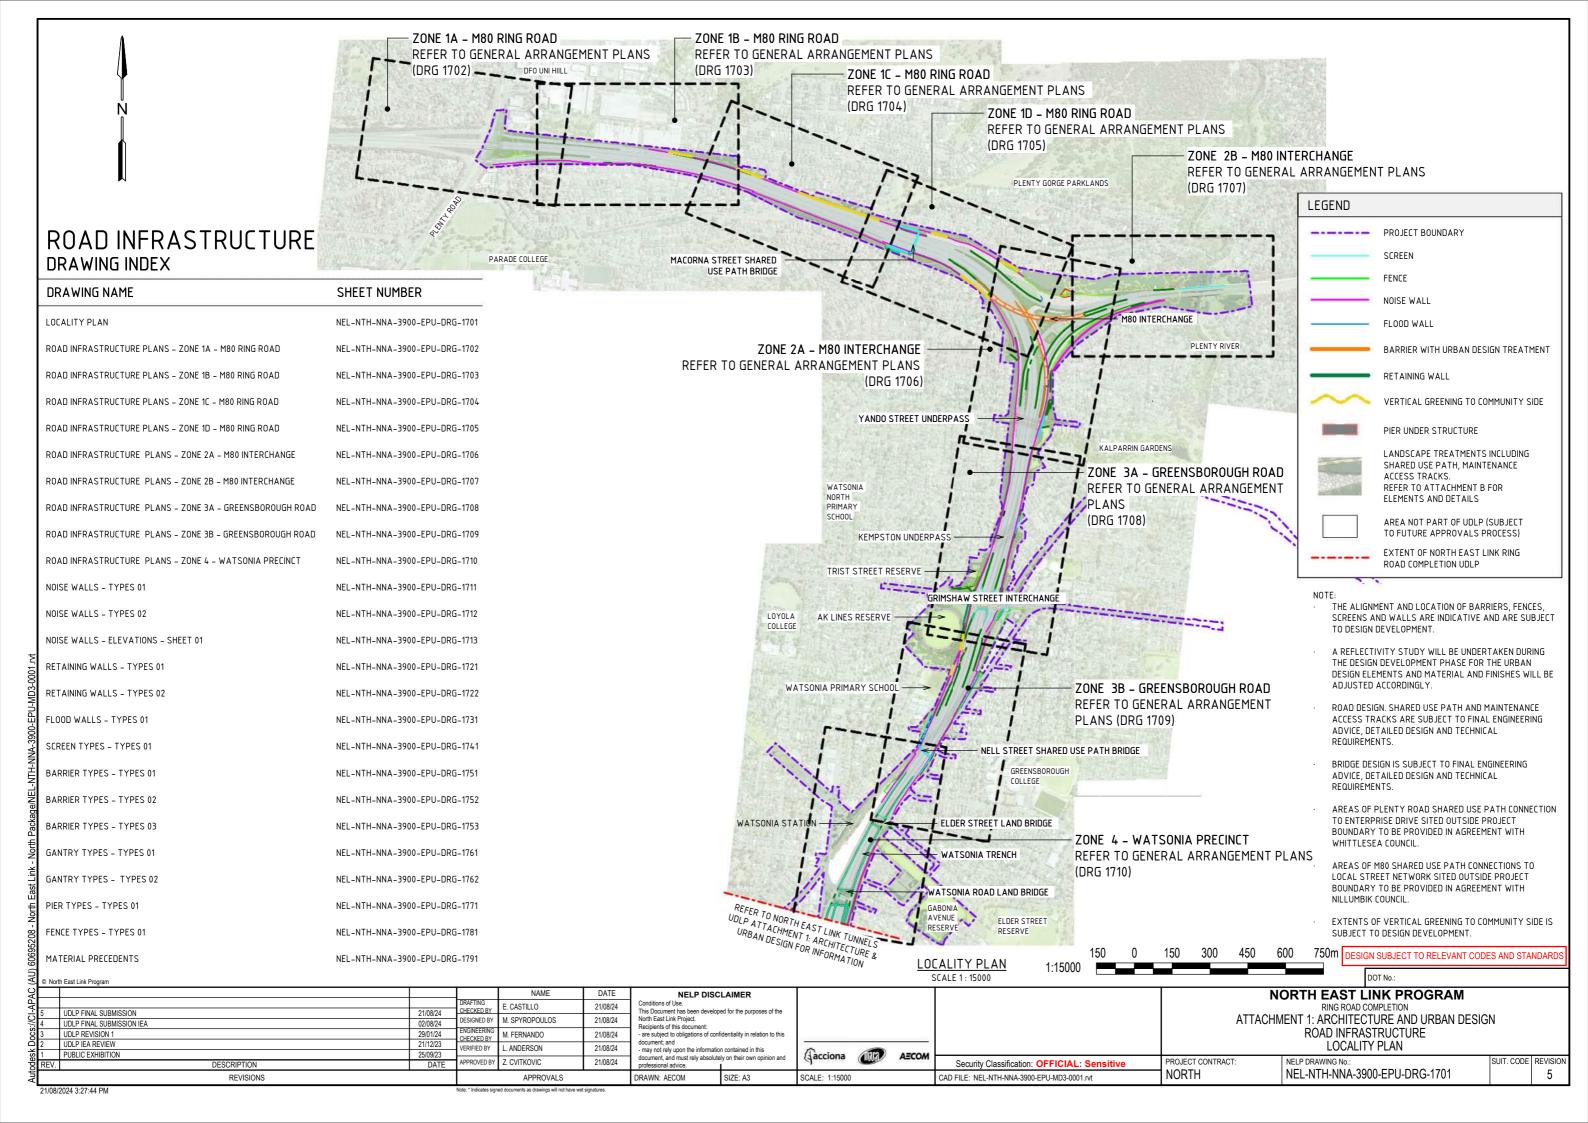
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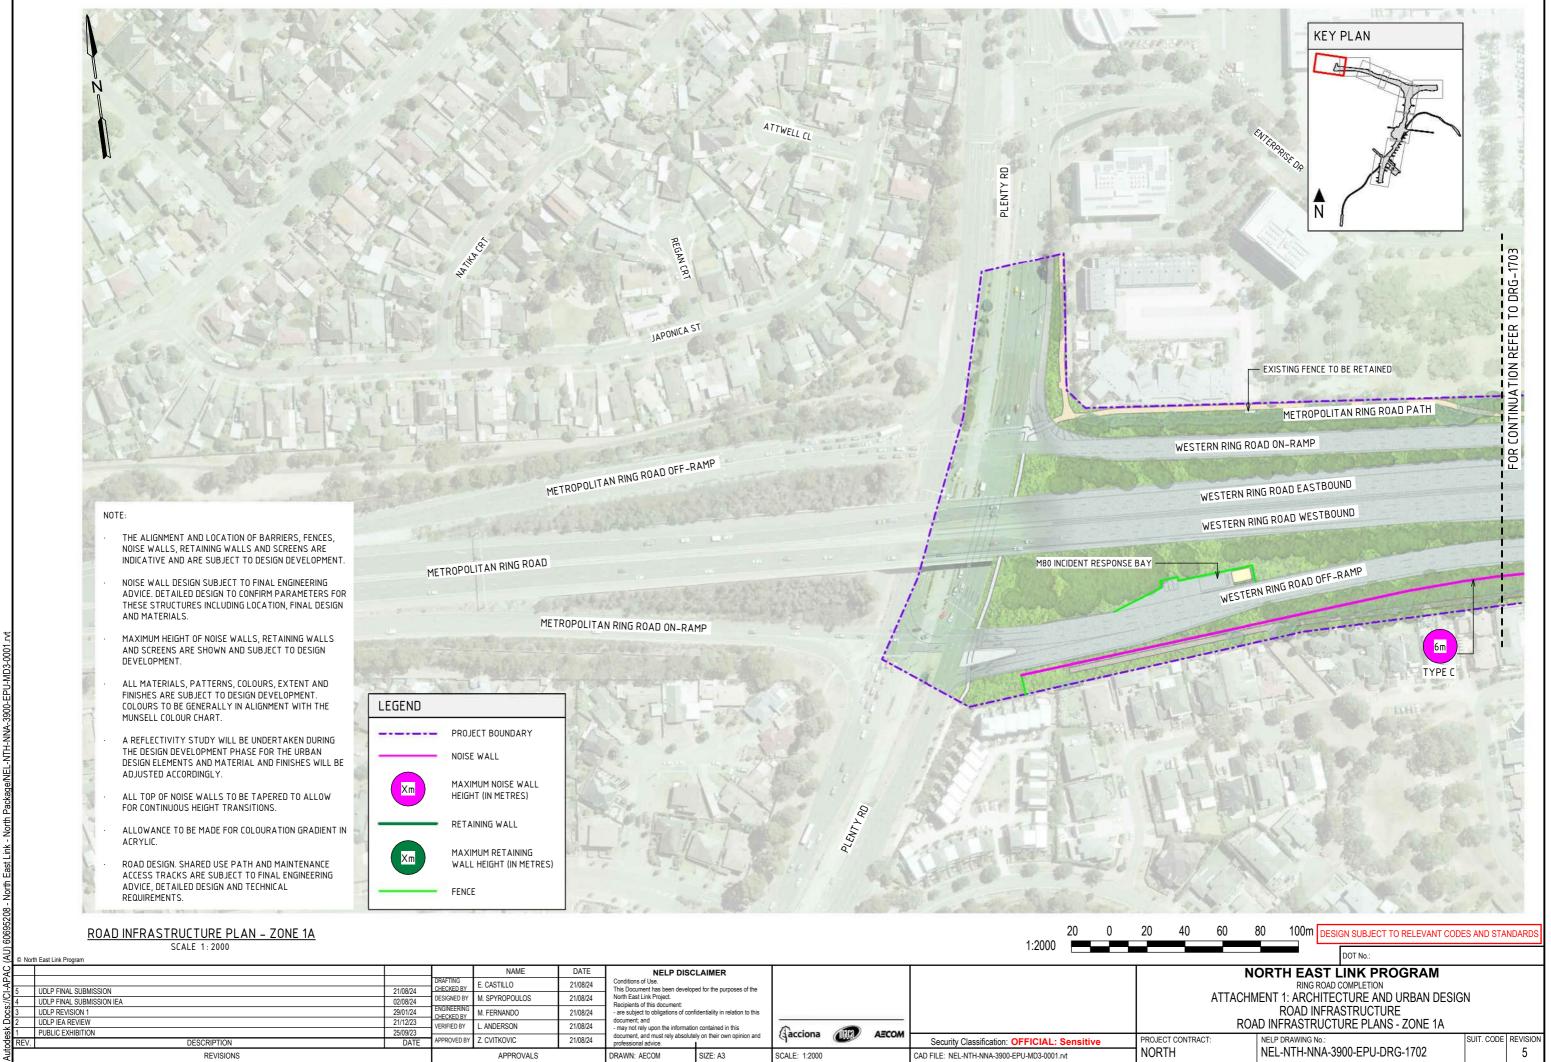
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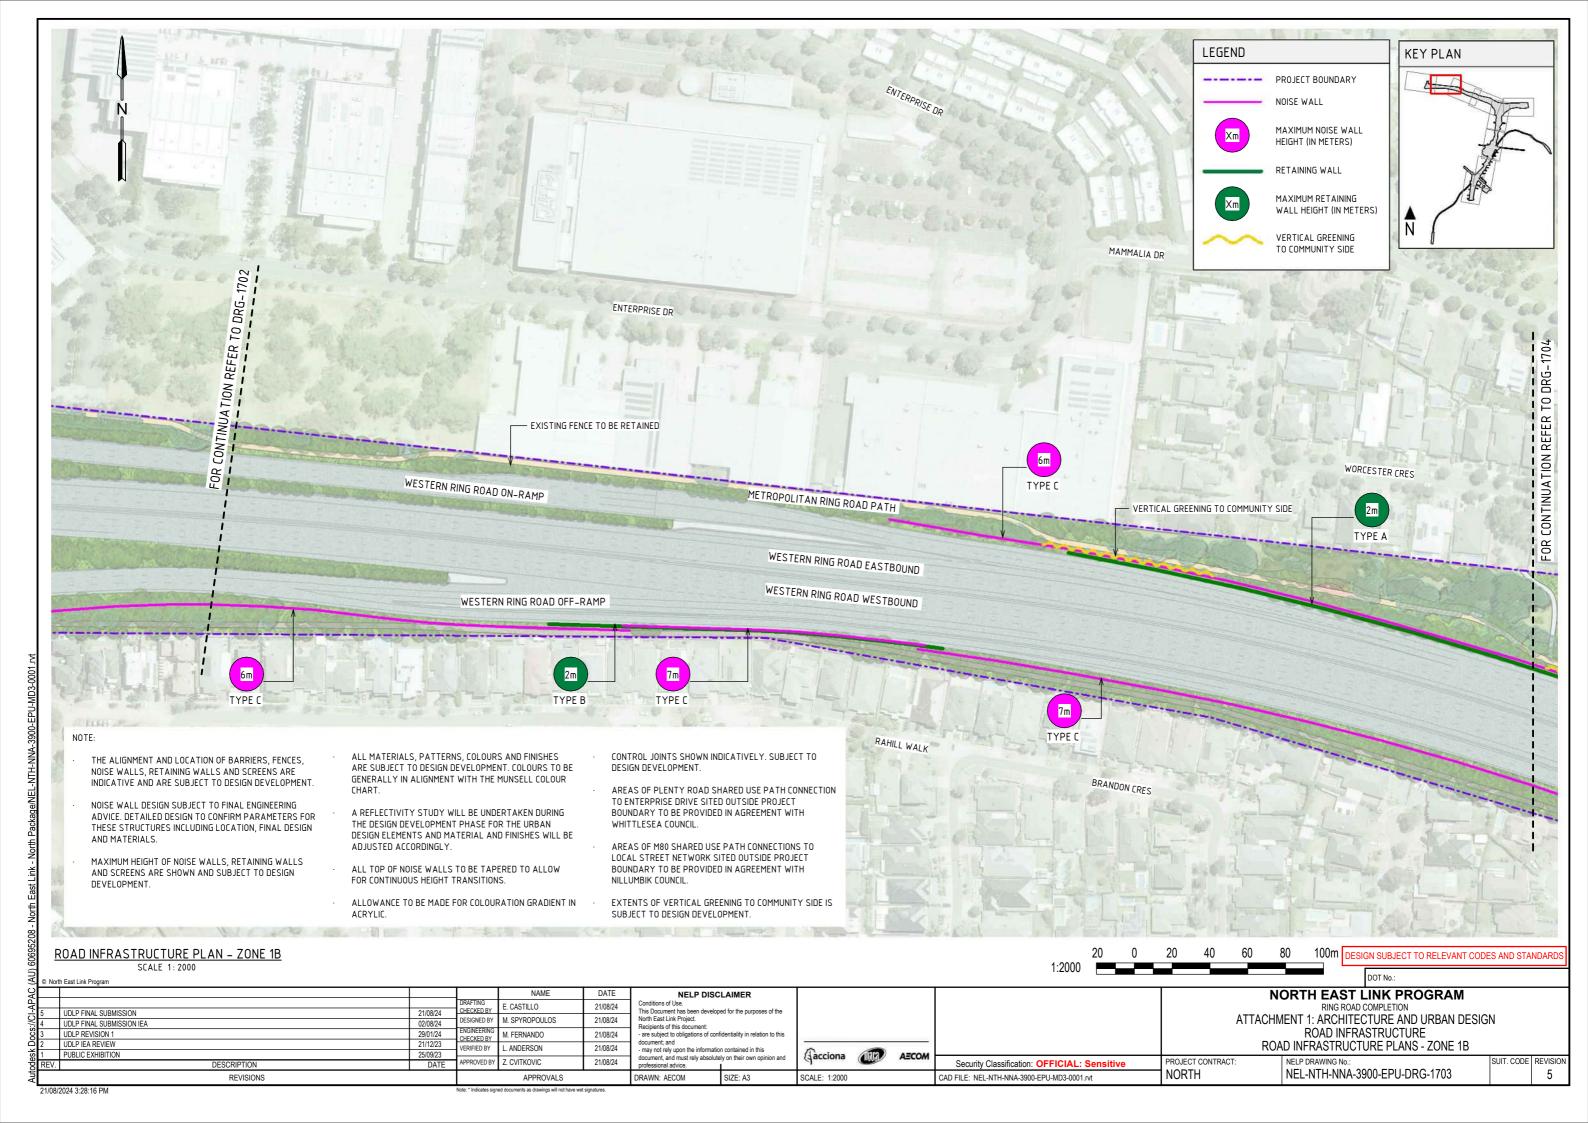









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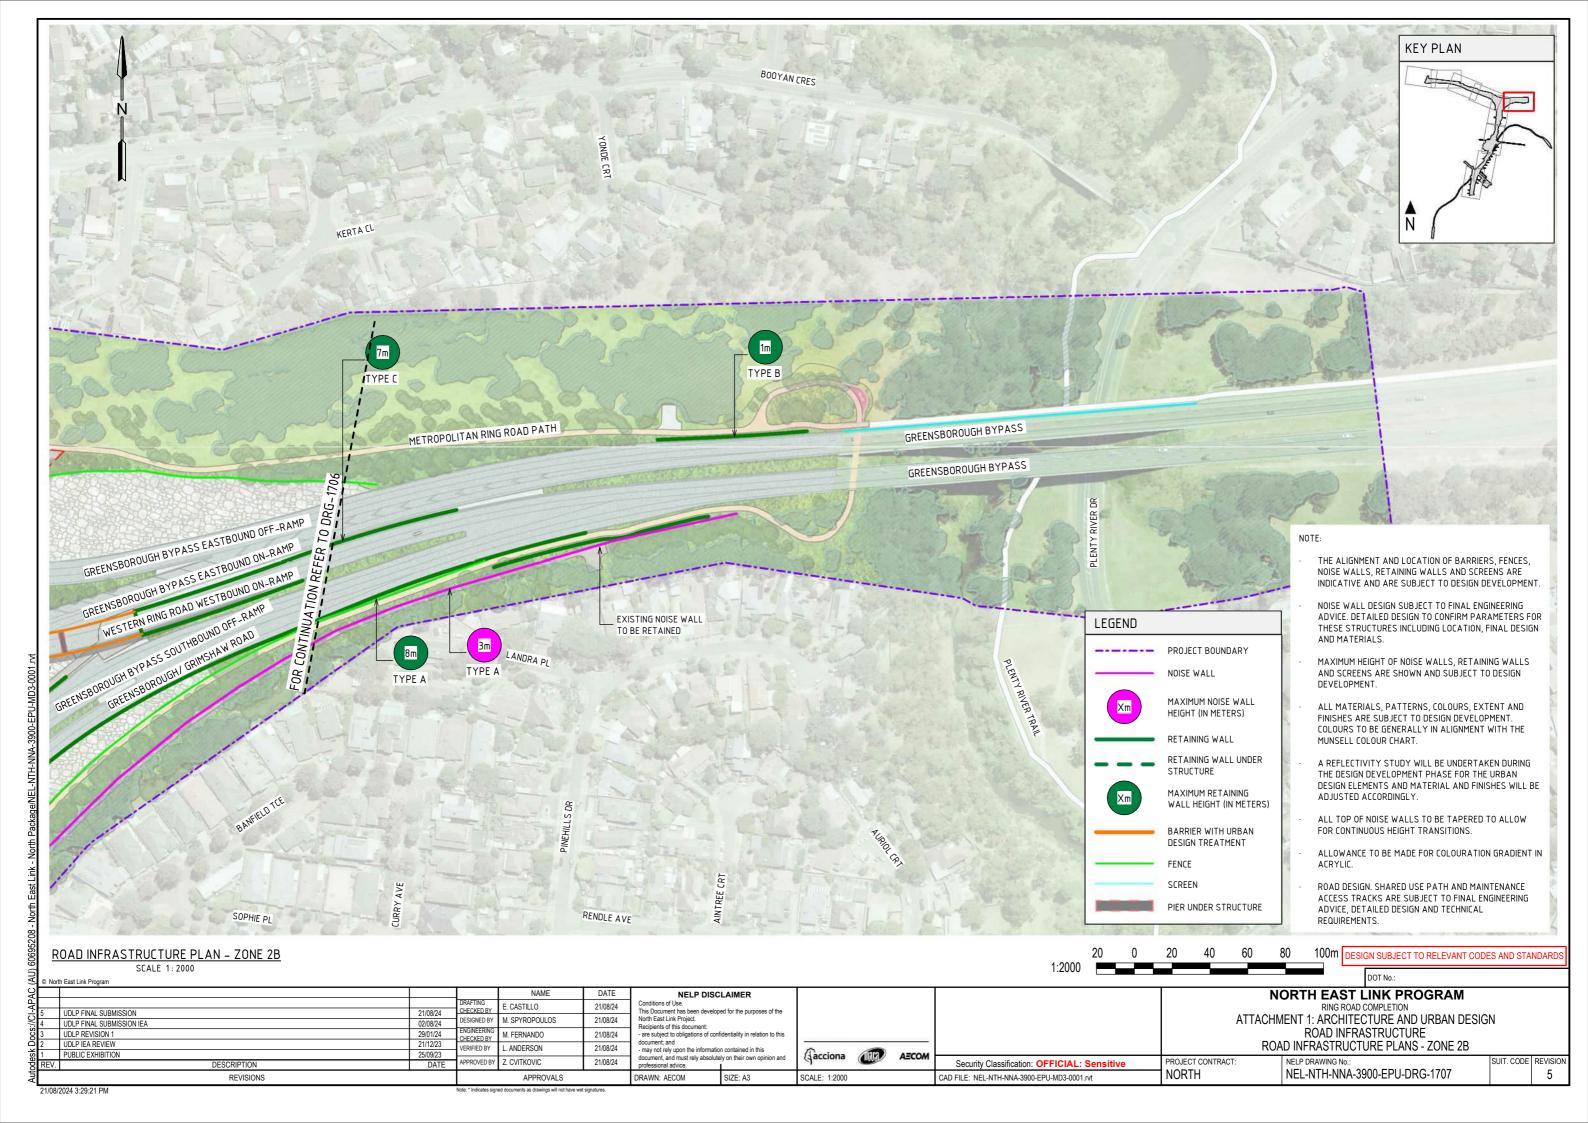
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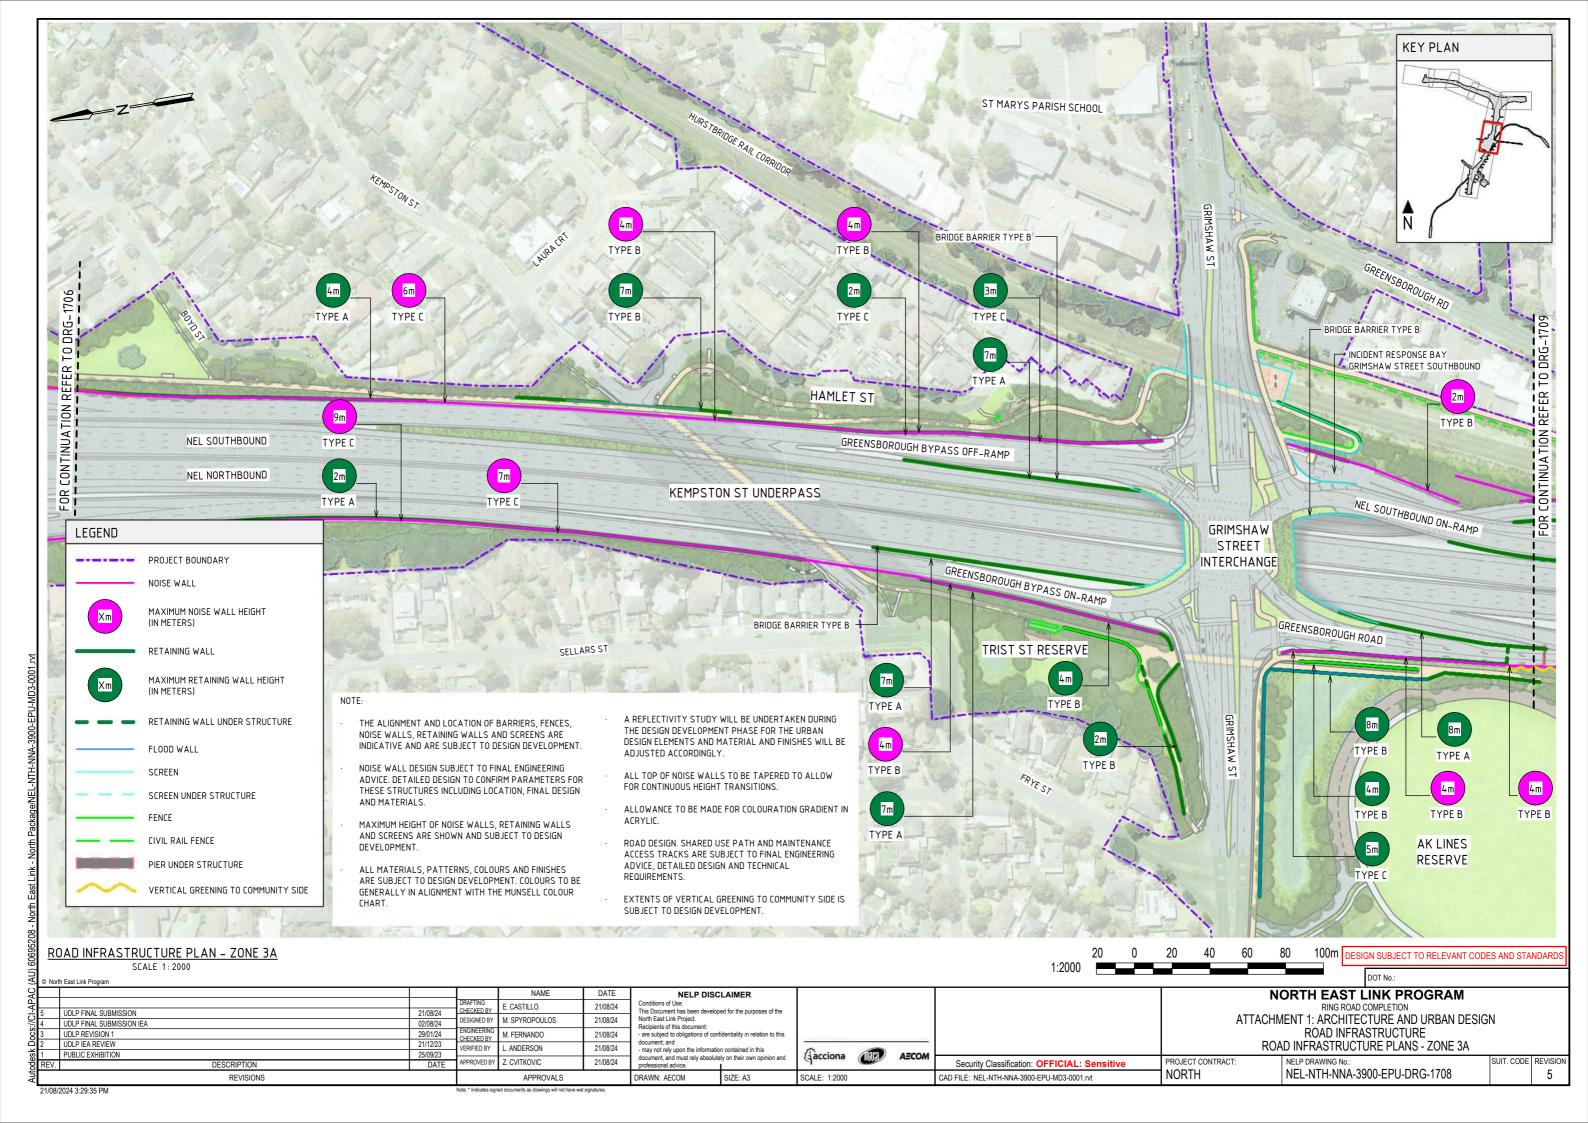








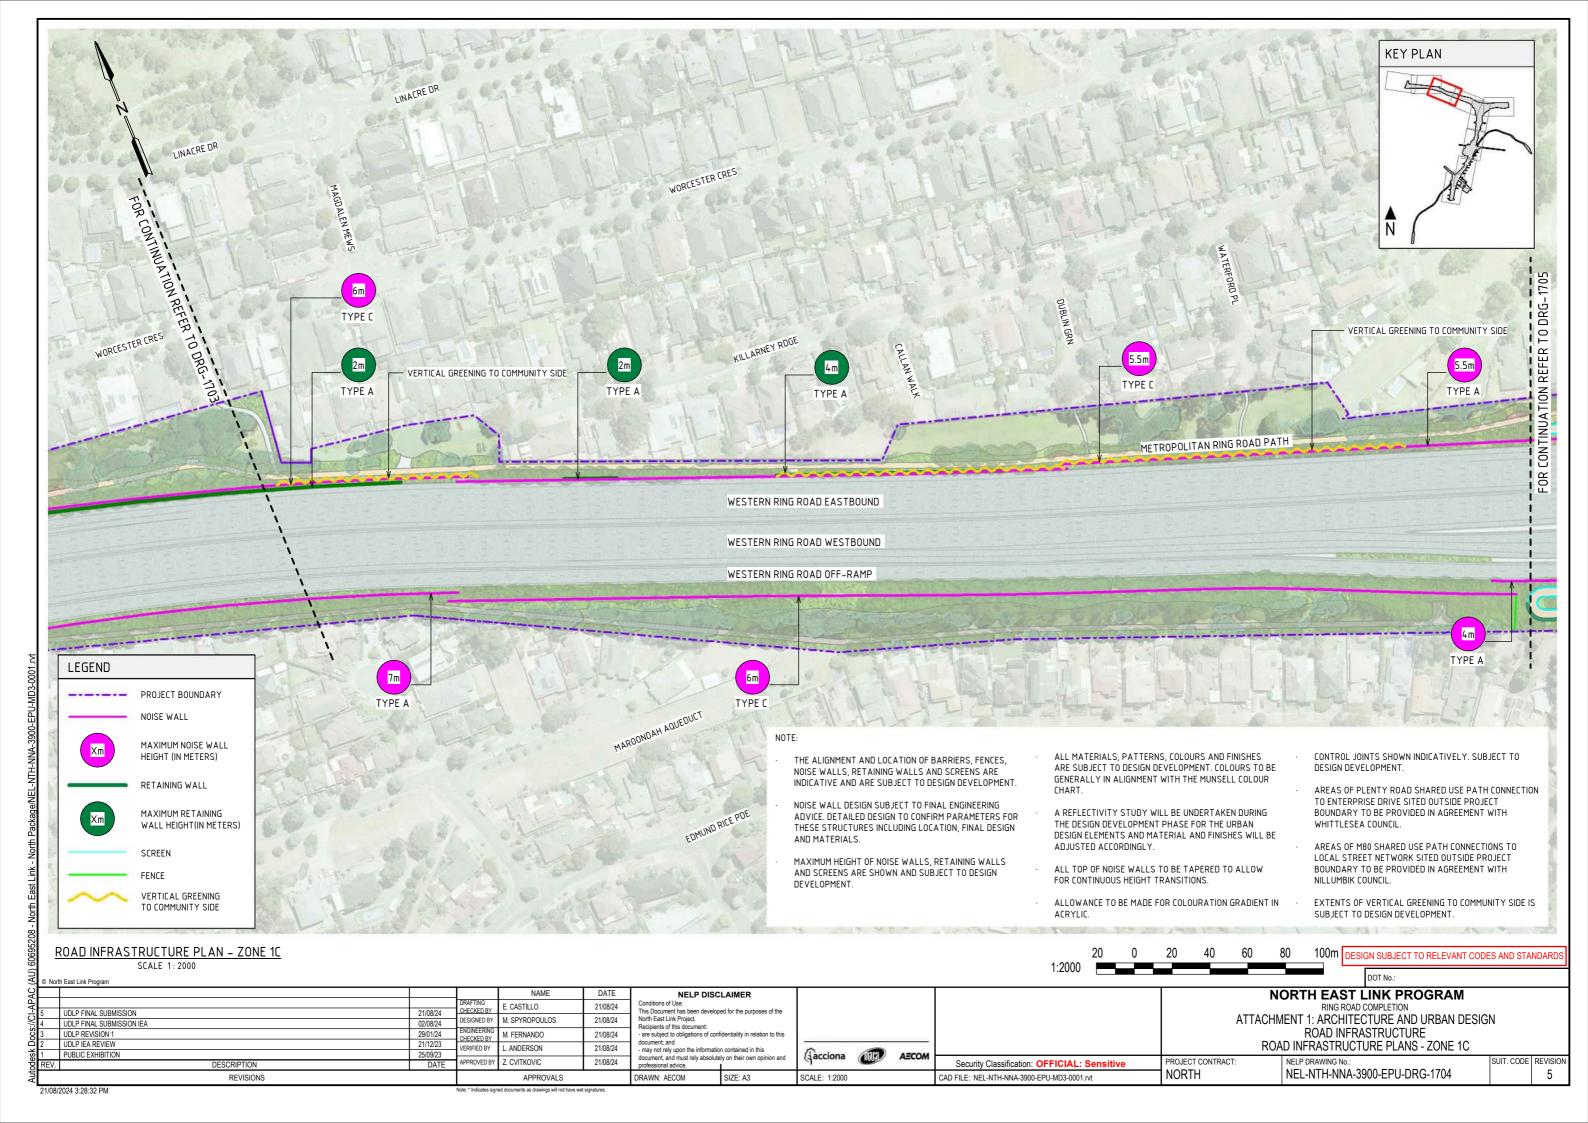


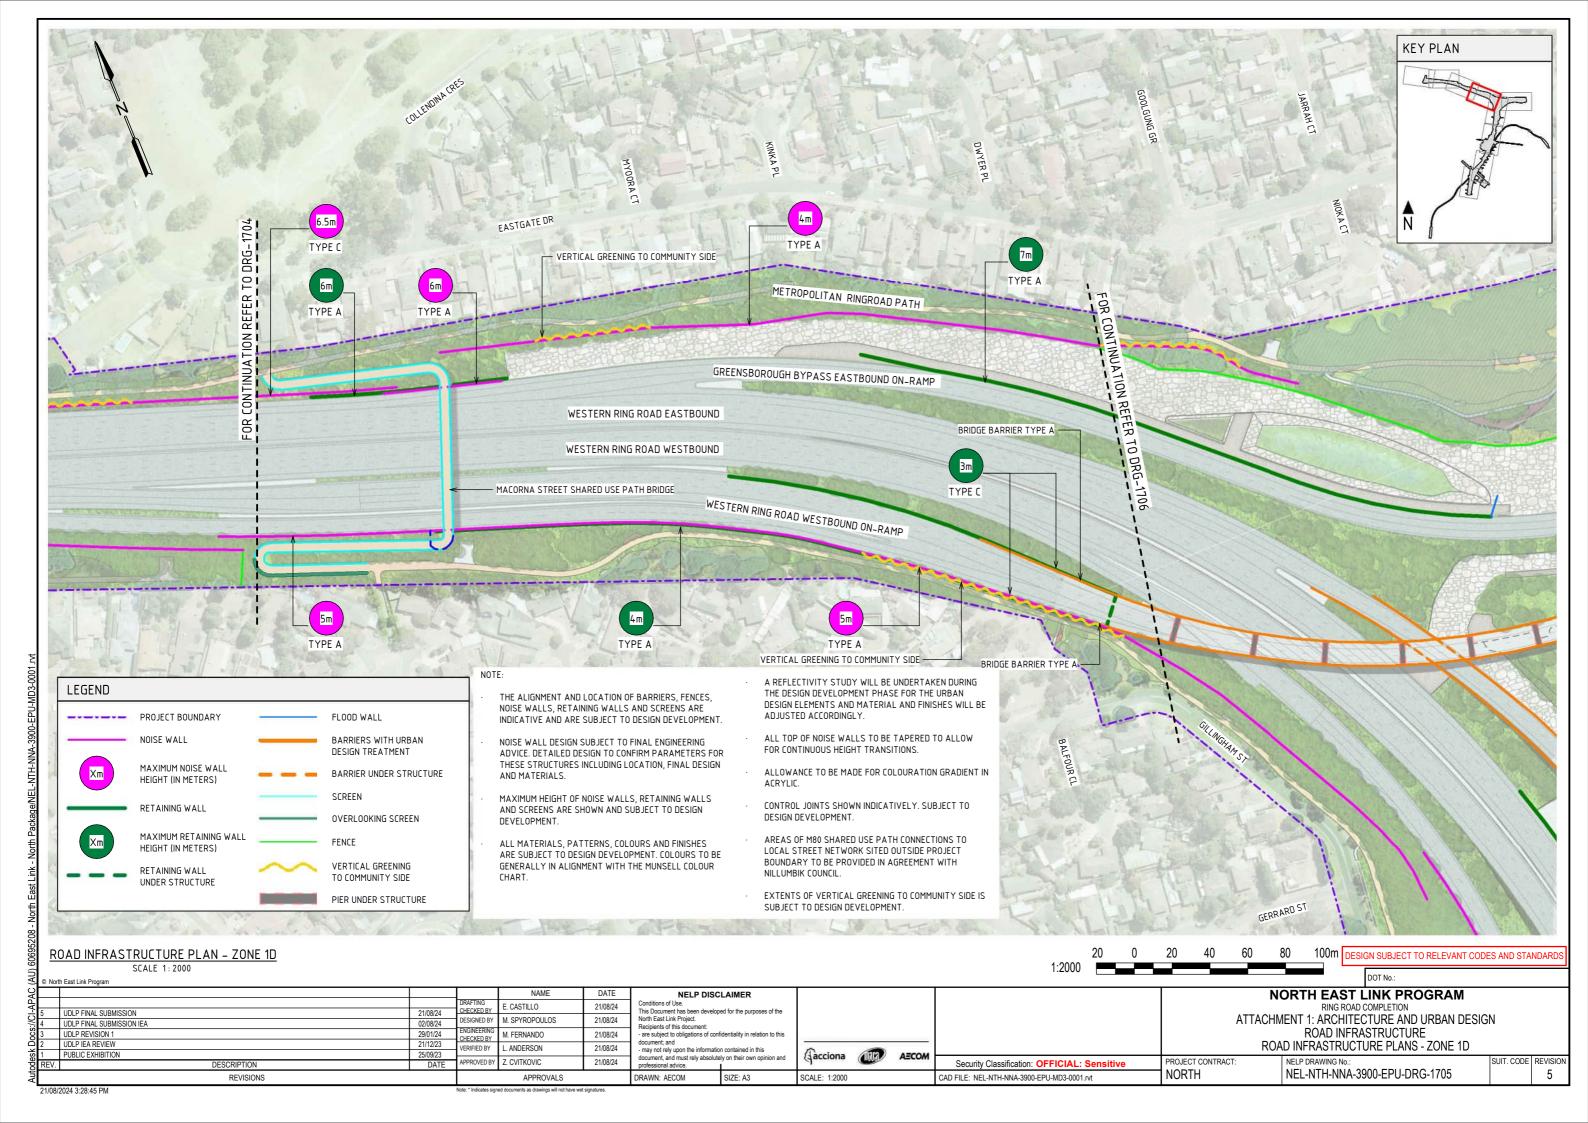

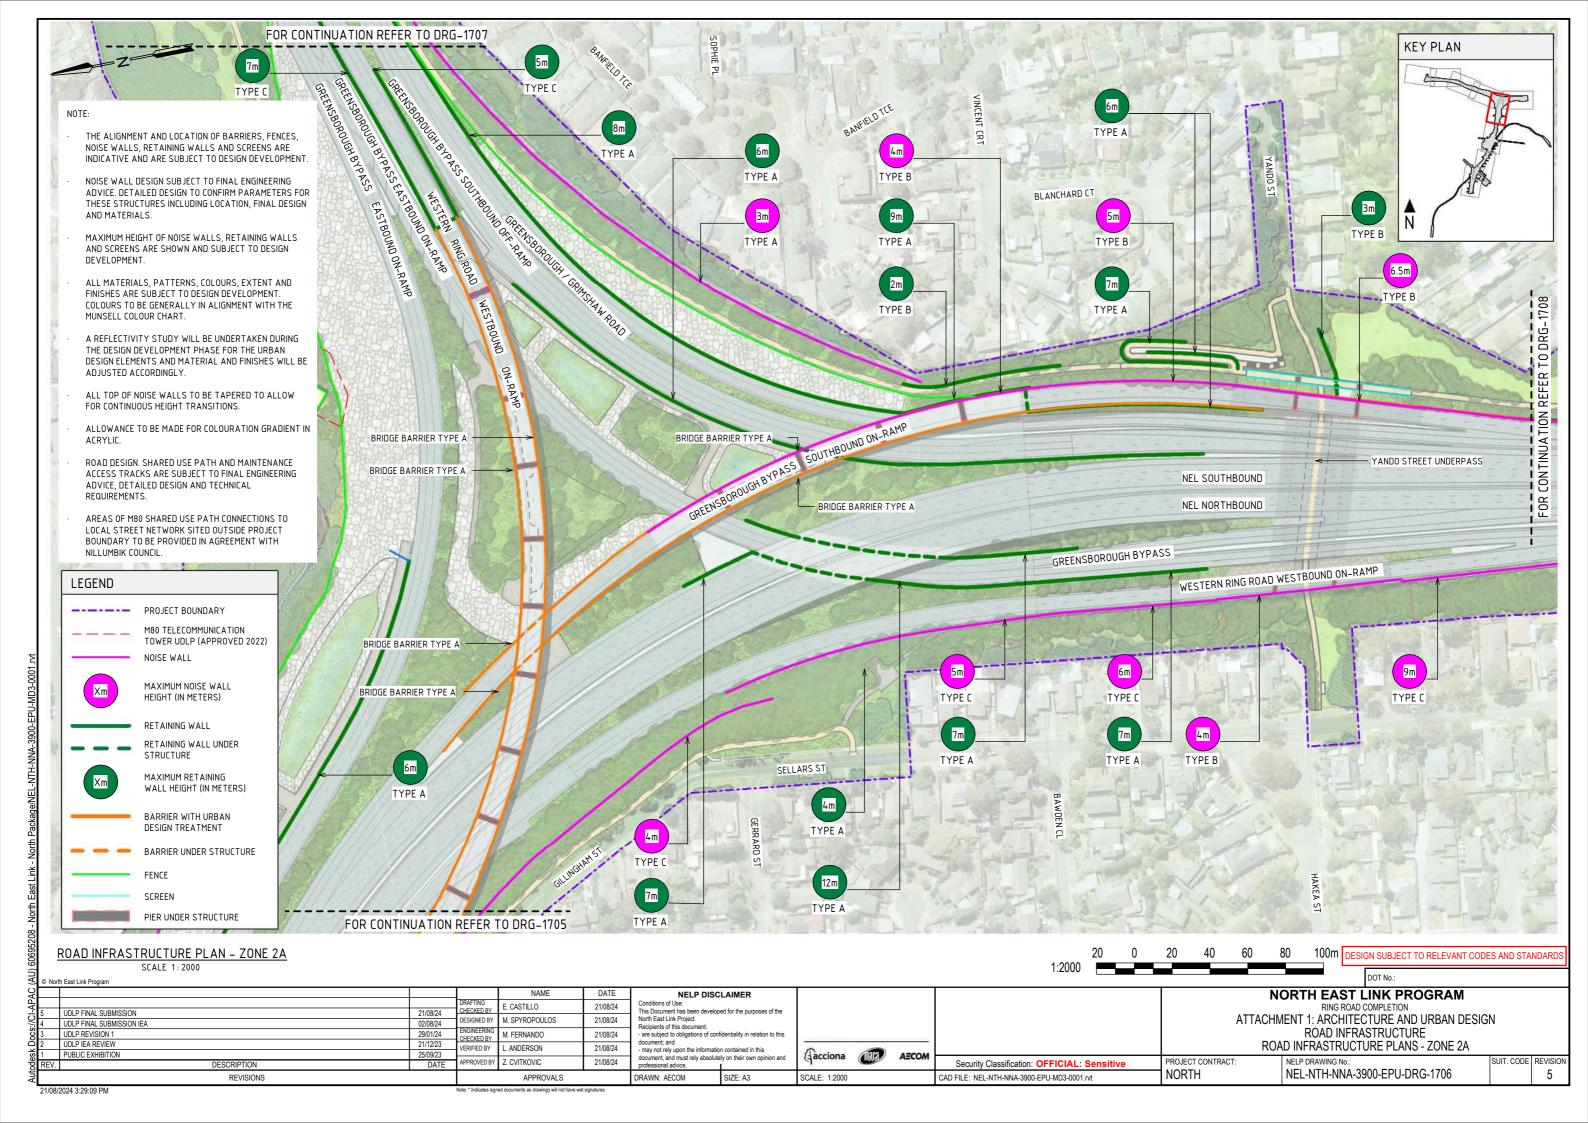


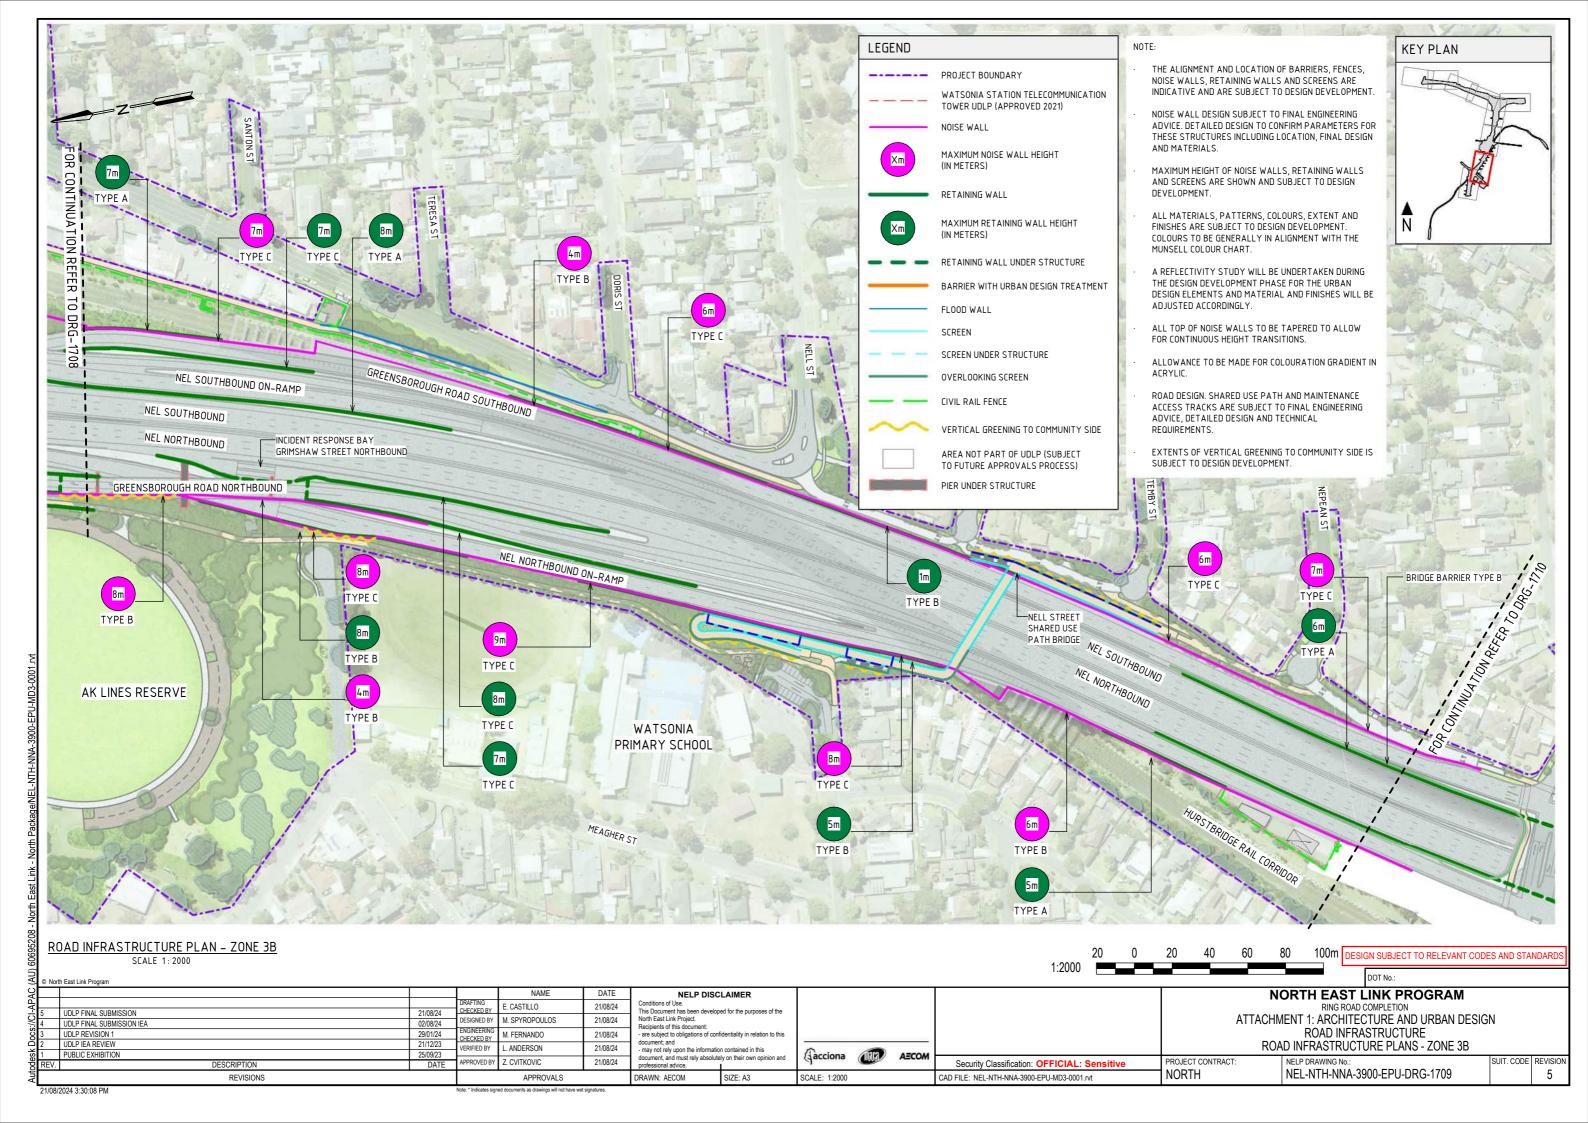

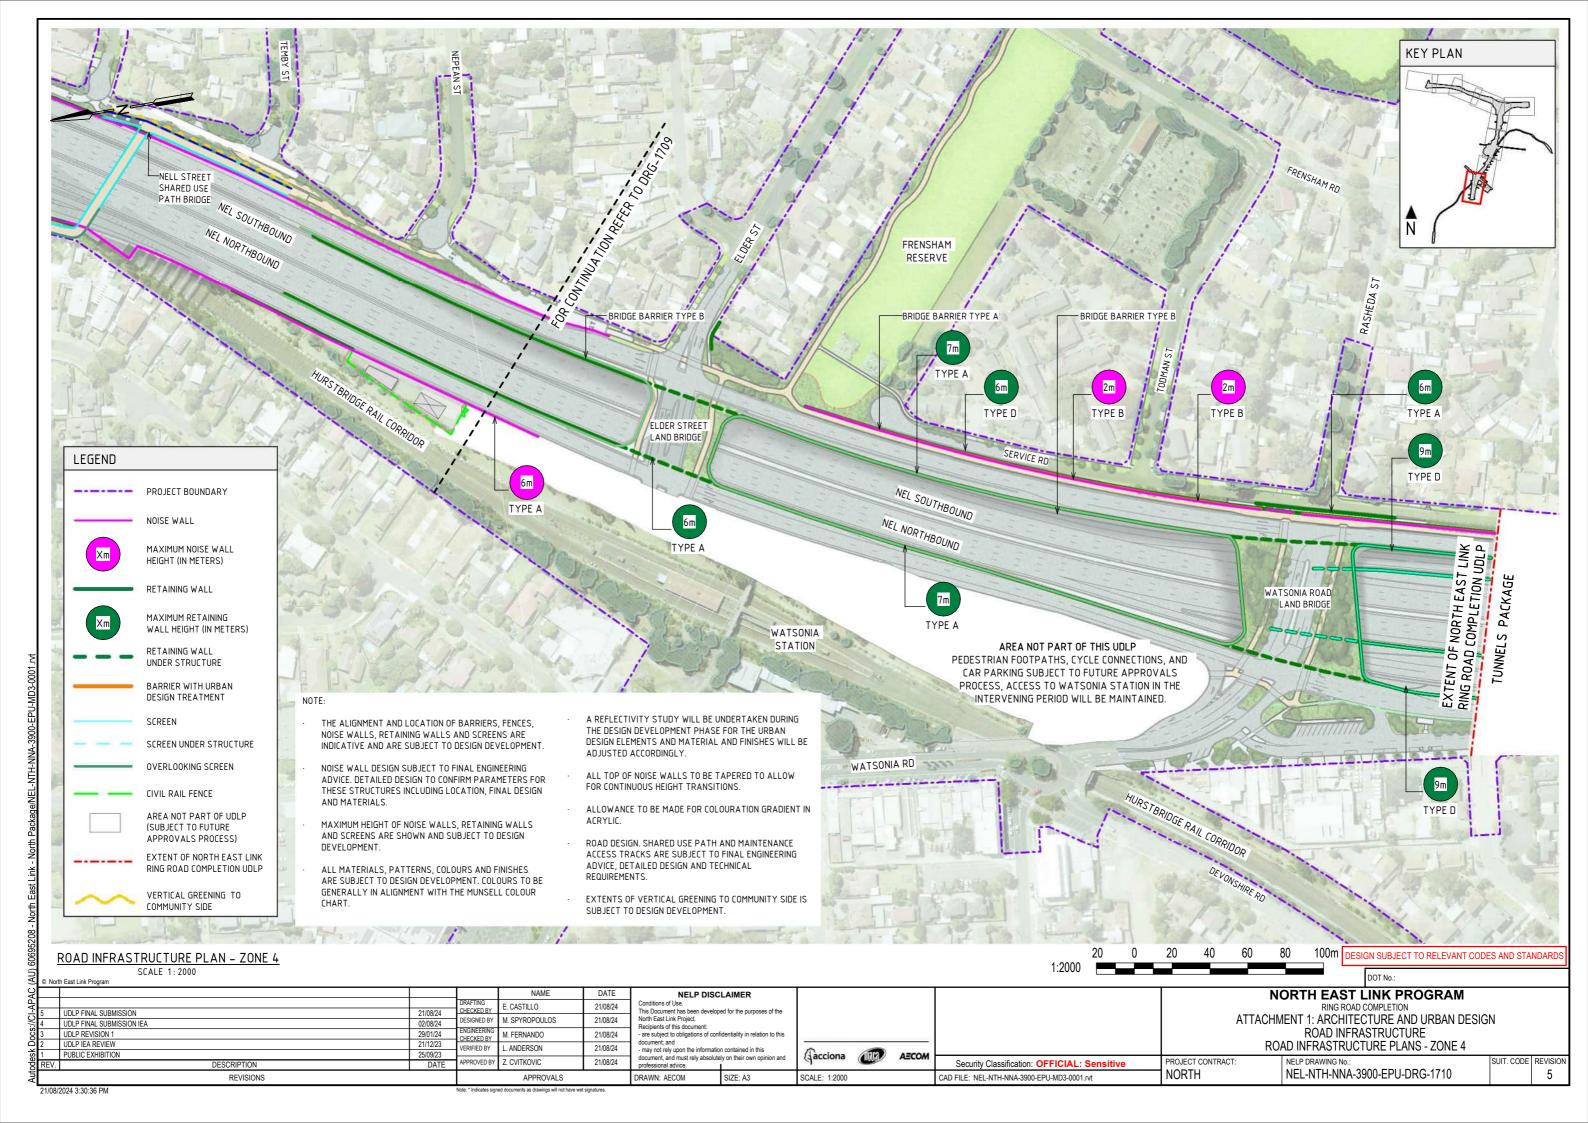


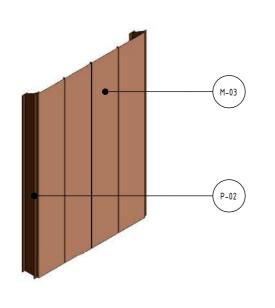


ISOMETRIC - NOISE WALL TYPE A N.T.S

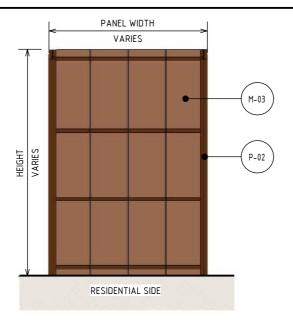


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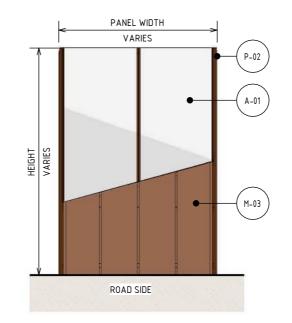
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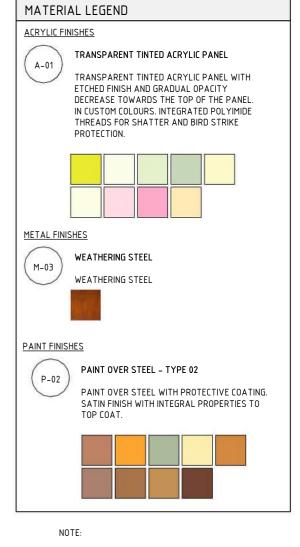
4 ISOMETRIC - NOISE WALL TYPE C N.T.S

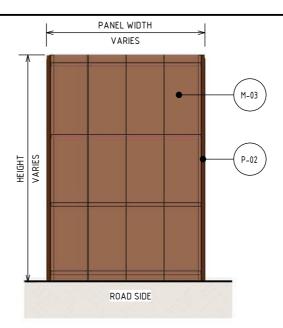

ELEVATION 2 - NOISE WALLS TYPE C SCALE: 1:100

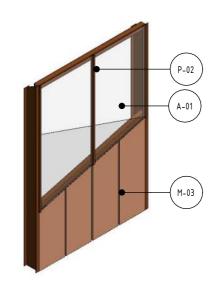

ELEVATION 1 - NOISE WALLS TYPE C SCALE: 1:100

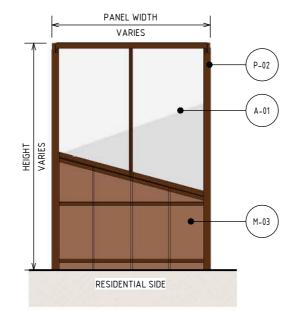

- THE ALIGNMENT AND LOCATION OF BARRIERS, FENCES, NOISE WALLS, RETAINING WALLS AND SCREENS ARE INDICATIVE AND ARE SUBJECT TO DESIGN DEVELOPMENT
- NOISE WALL DESIGN SUBJECT TO FINAL ENGINEERING ADVICE. DETAILED DESIGN TO CONFIRM PARAMETERS FOR THESE STRUCTURES INCLUDING LOCATION, FINAL DESIGN AND MATERIALS.
- MAXIMUM HEIGHT OF NOISE WALLS, RETAINING WALLS AND SCREENS ARE SHOWN AND SUBJECT TO DESIGN DEVELOPMENT.
- ALL MATERIALS, PATTERNS, COLOURS AND FINISHES ARE SUBJECT TO DESIGN DEVELOPMENT. COLOURS TO BE GENERALLY IN ALIGNMENT WITH THE MUNSELL COLOUR CHART.
- A REFLECTIVITY STUDY WILL BE UNDERTAKEN DURING THE DESIGN DEVELOPMENT PHASE FOR THE URBAN DESIGN ELEMENTS AND MATERIAL AND FINISHES WILL BE ADJUSTED ACCORDINGLY.
- ALL TOP OF NOISE WALLS TO BE TAPERED TO ALLOW FOR CONTINUOUS HEIGHT TRANSITIONS.
- ALLOWANCE TO BE MADE FOR COLOURATION GRADIENT IN ACRYLIC.
- CONTROL JOINTS SHOWN INDICATIVELY. SUBJECT TO

DESIGN DEVELOPMENT.

	1	0	1	2	3	4	5m	DESIGN SUBJECT TO RELEVANT CODES AND STANDARDS
1:100								DOT No.:

North East Link Program **NORTH EAST LINK PROGRAM** NAME DATE **NELP DISCLAIMER**


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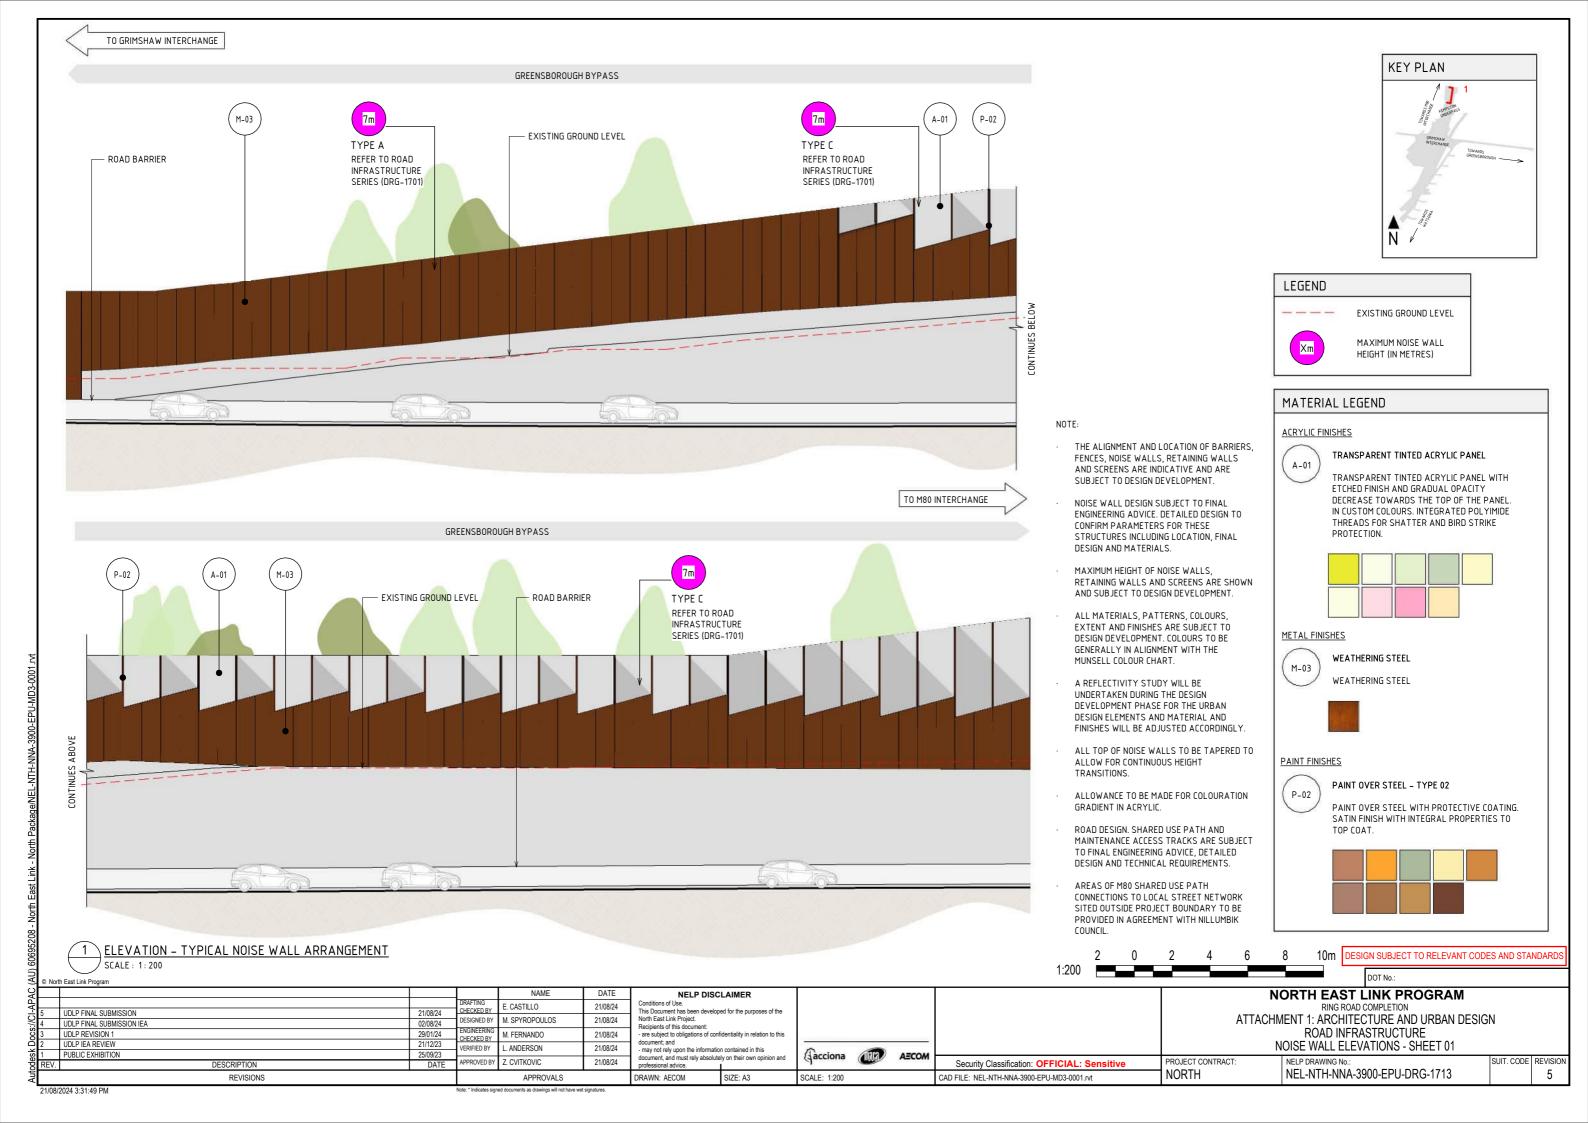
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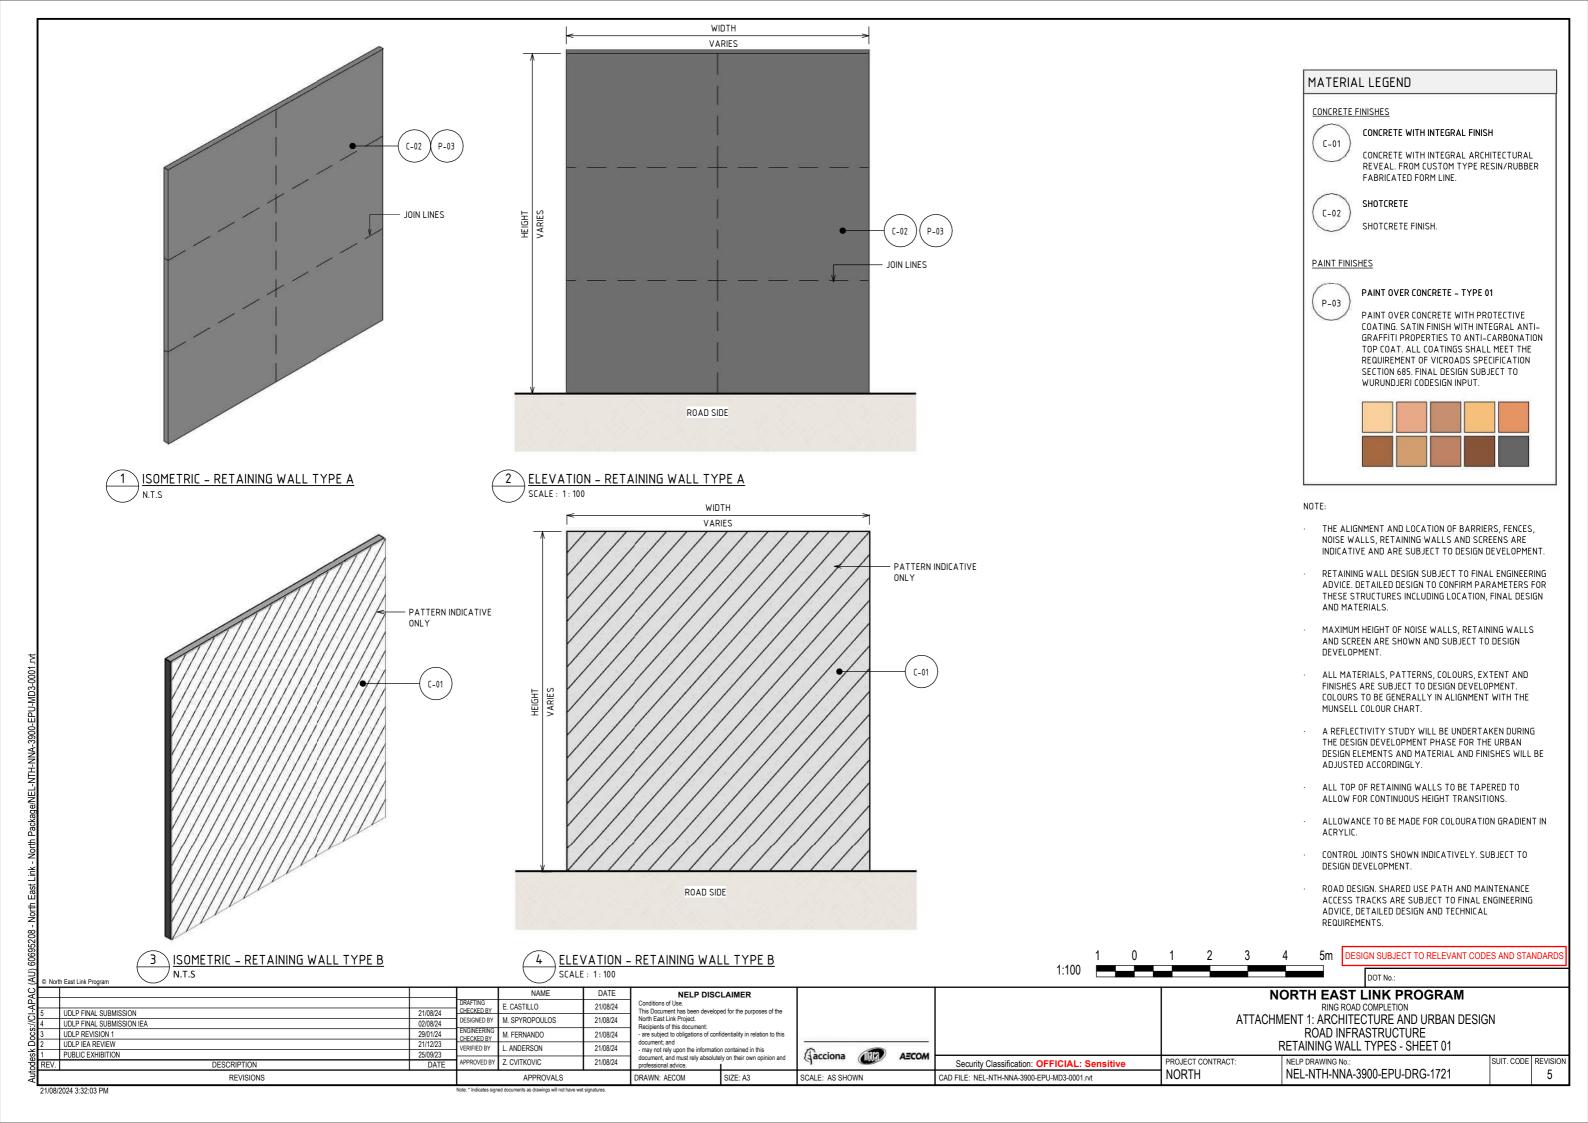
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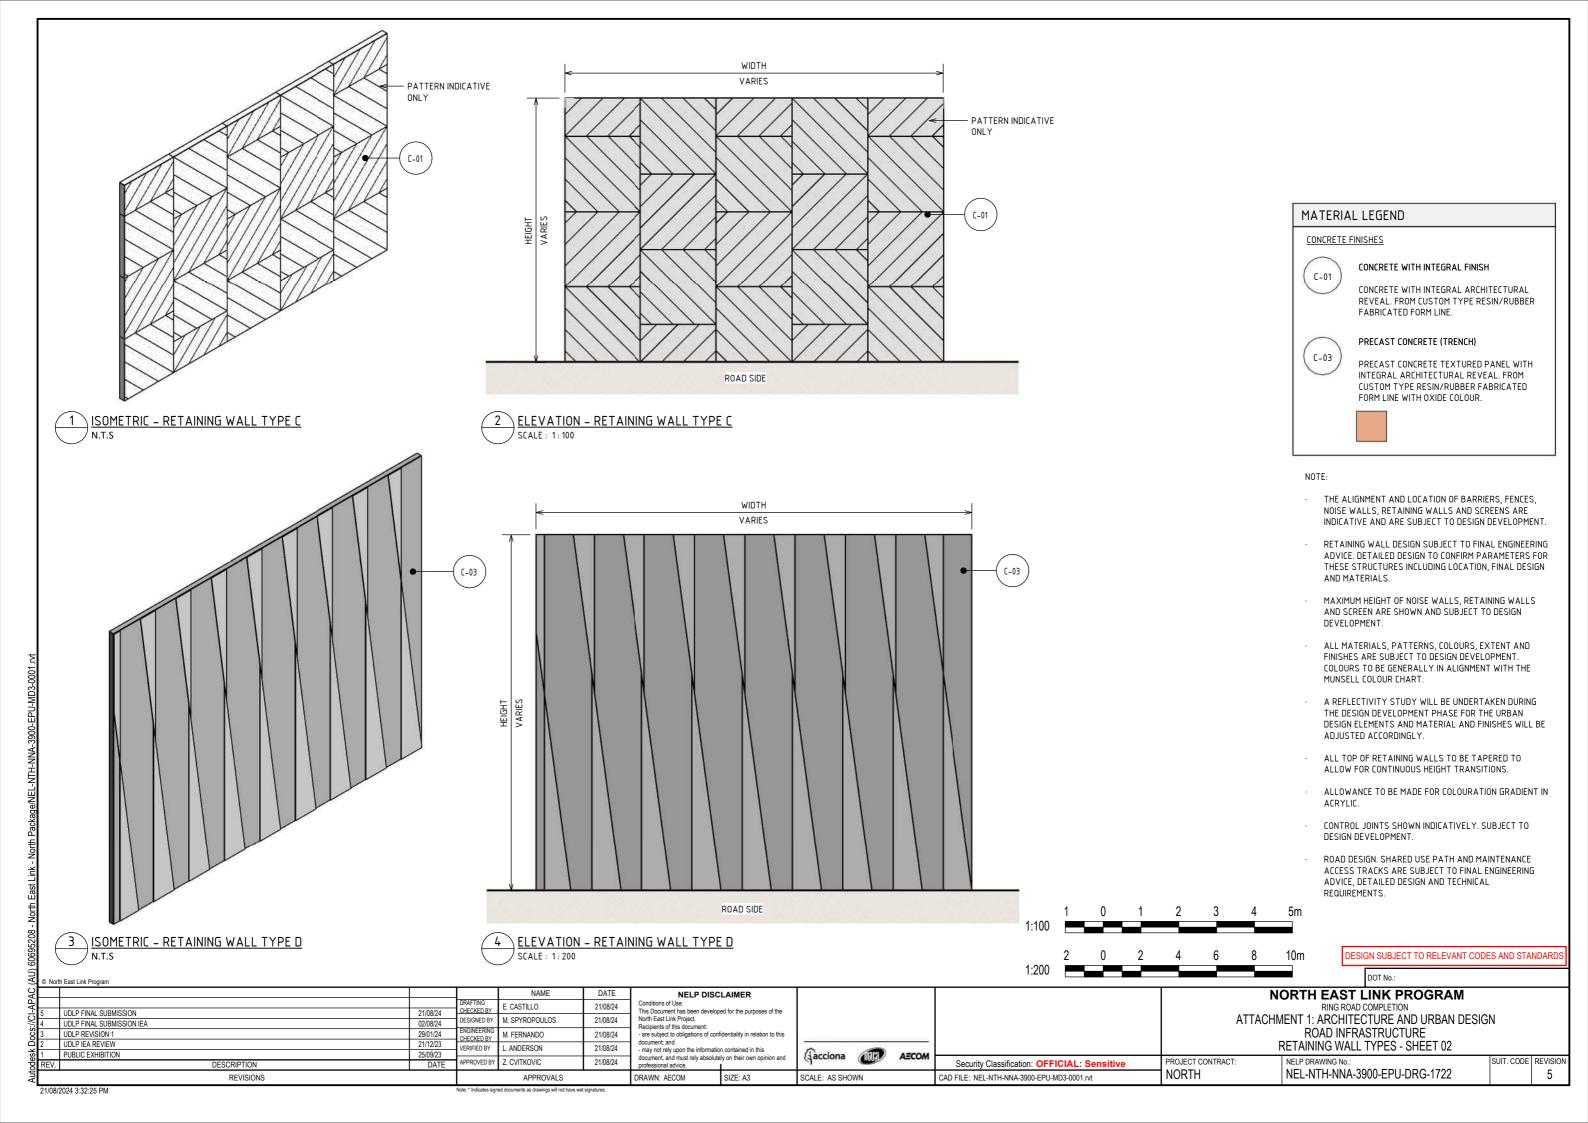
SUIT. CODE REVISION 5


APPROVALS







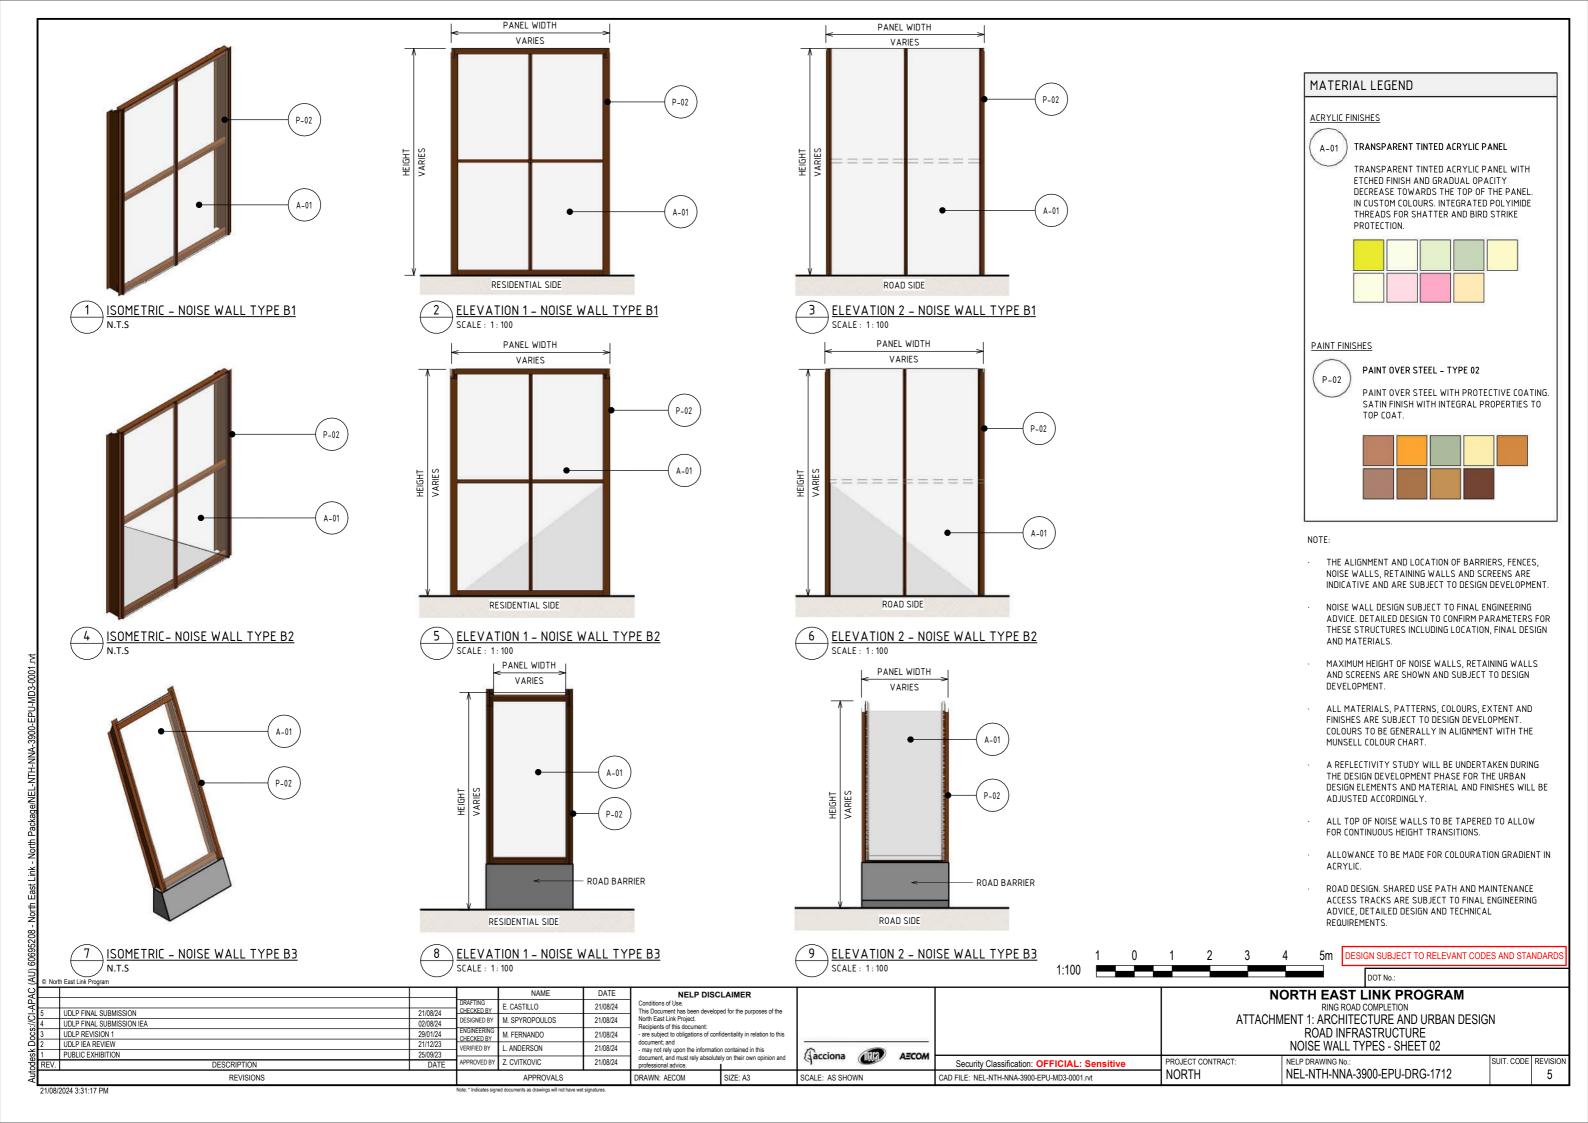

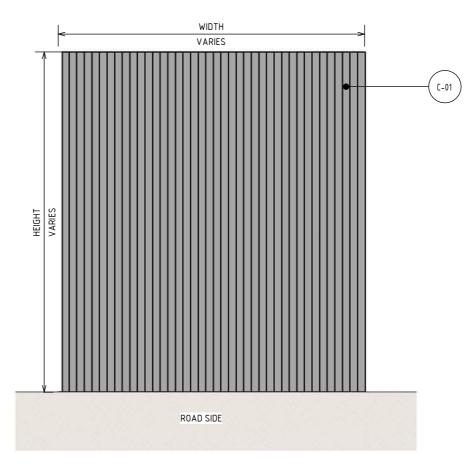

2 ELEVATION - FLOOD WALL TYPE A SCALE: 1:100

MATERIAL LEGEND

CONCRETE FINISHES



CONCRETE WITH INTEGRAL FINISH

CONCRETE WITH INTEGRAL ARCHITECTURAL REVEAL. FROM CUSTOM TYPE RESIN/RUBBER FABRICATED FORM LINE.

NOTE:

- THE ALIGNMENT AND LOCATION OF BARRIERS, FENCES, NOISE WALLS, RETAINING WALLS AND SCREENS ARE INDICATIVE AND ARE SUBJECT TO DESIGN DEVELOPMENT.
- FLOOD WALL DESIGN SUBJECT TO FINAL ENGINEERING ADVICE. DETAILED DESIGN TO CONFIRM PARAMETERS FOR THESE STRUCTURES INCLUDING LOCATION, FINAL DESIGN AND MATERIALS.
- MAXIMUM HEIGHT OF NOISE WALLS, RETAINING WALLS AND SCREENS ARE SHOWN AND SUBJECT TO DESIGN DEVELOPMENT.
- ALL MATERIALS, PATTERNS, COLOURS, EXTENT AND FINISHES ARE SUBJECT TO DESIGN DEVELOPMENT.
 COLOURS TO BE GENERALLY IN ALIGNMENT WITH THE ${\tt MUNSELL\ COLOUR\ CHART}.$
- A REFLECTIVITY STUDY WILL BE UNDERTAKEN DURING THE DESIGN DEVELOPMENT PHASE FOR THE URBAN DESIGN ELEMENTS AND MATERIAL AND FINISHES WILL BE ADJUSTED ACCORDINGLY.
- ALL TOP OF FLOOD WALLS TO BE TAPERED TO ALLOW FOR CONTINUOUS HEIGHT TRANSITIONS.
- ALLOWANCE TO BE MADE FOR COLOURATION GRADIENT IN ACRYLIC.
- ROAD DESIGN. SHARED USE PATH AND MAINTENANCE ACCESS TRACKS ARE SUBJECT TO FINAL ENGINEERING ADVICE, DETAILED DESIGN AND TECHNICAL REQUIREMENTS.

5m

DESIGN SUBJECT TO RELEVANT CODES AND STANDAR

NORTH EAST LINK PROGRAM

RING ROAD COMPLETION

ATTACHMENT 1: ARCHITECTURE AND URBAN DESIGN ROAD INFRASTRUCTURE

FLOOD WALL TYPES - SHEET 01

NELP DRAWING No.

UDLP FINAL SUBMISSION UDLP FINAL SUBMISSION IEA

UDLP REVISION 1 UDLP IEA REVIEW PUBLIC EXHIBITION

DESCRIPTION

REVISIONS

N.T.S

DATE NAME E. CASTILLO 21/08/24 CHECKED BY M SPYROPOULOS 21/08/24 DESIGNED BY M. FERNANDO 21/08/24 CHECKED BY ERIFIED BY . ANDERSON 21/08/24 APPROVED BY 7 CVITKOVIC 21/08/24

21/08/24

02/08/24

29/01/24

DATE

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NELP DISCLAIMER

SIZE: A3

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Security Classification: OFFICIAL: Sensitive CAD FILE: NEL-NTH-NNA-3900-EPU-MD3-0001.rvt

PROJECT CONTRACT NORTH


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SUIT. CODE REVISION 5


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APPROVALS

ISOMETRIC - 'ANTI'-THROW SCREEN TYPE A N.T.S




ISOMETRIC - 'ANTI'-THROW SCREEN TYPE B

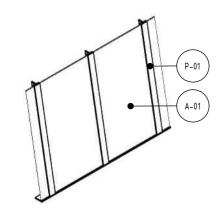

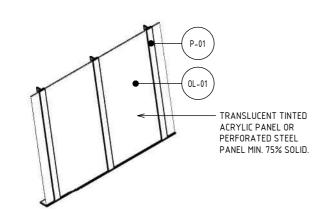
ISOMETRIC - OVERLOOKING SCREEN TYPE C

DESCRIPTION


REVISIONS

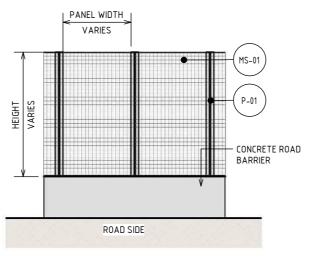

ELEVATION - THROW SCREEN TYPE A SCALE: 1:100

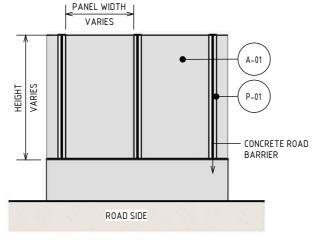

ELEVATION - 'ANTI'-THROW SCREEN TYPE B SCALE: 1:100

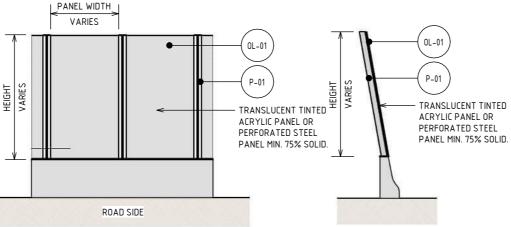

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\ ELEVATION - OVERLOOKING SCREEN TYPE C SCALE: 1:100

DATE

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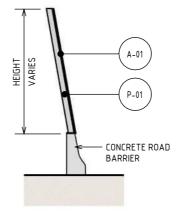
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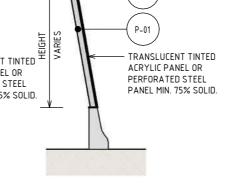
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CONCRETE ROAD BARRIER

SECTION - 'ANTI'-THROW SCREEN TYPE A SCALE: 1:100



SECTION - 'ANTI'-THROW SCREEN TYPE B SCALE: 1:100



SECTION - OVERLOOKING SCREEN TYPE C SCALE: 1:100

NOTE:

- OVERLOOKING SCREEN TYPE MATERIALS AND EXTENT OF APPLICATION ARE TO BE FINALISED IN DETAILED DESIGN IN CONSULTATION WITH DIRECTLY IMPACTED PROPERTIES TO ACHIEVE COMPLIANCE WITH THE REQUIREMENTS OF EPR
- THE ALIGNMENT AND LOCATION OF BARRIERS, FENCES, NOISE WALLS, RETAINING WALLS AND SCREENS ARE INDICATIVE AND ARE SUBJECT TO DESIGN DEVELOPMENT.
- SCREEN DESIGN SUBJECT TO FINAL ENGINEERING ADVICE. DETAILED DESIGN TO CONFIRM PARAMETERS FOR THESE STRUCTURES INCLUDING LOCATION, FINAL DESIGN AND MATERIALS.
- MAXIMUM HEIGHT OF NOISE WALLS, RETAINING WALLS AND SCREENS ARE SHOWN AND SUBJECT TO DESIGN DEVELOPMENT.
- ALL MATERIALS, PATTERNS, COLOURS, EXTENT AND FINISHES ARE SUBJECT TO DESIGN DEVELOPMENT. COLOURS TO BE GENERALLY IN ALIGNMENT WITH THE MUNSELL COLOUR CHART.
- A REFLECTIVITY STUDY WILL BE UNDERTAKEN DURING THE DESIGN DEVELOPMENT PHASE FOR THE URBAN DESIGN ELEMENTS AND MATERIAL AND FINISHES WILL BE ADJUSTED ACCORDINGLY.
- ALL TOP OF SCREENS TO BE TAPERED TO ALLOW FOR CONTINUOUS HEIGHT TRANSITIONS.
- ALLOWANCE TO BE MADE FOR COLOURATION GRADIENT IN ACRYLIC.
 - ROAD DESIGN. SHARED USE PATH AND MAINTENANCE ACCESS TRACKS ARE SUBJECT TO FINAL ENGINEERING ADVICE, DETAILED DESIGN AND TECHNICAL REQUIREMENTS.


MATERIAL LEGEND

ACRYLIC FINISHES



TRANSPARENT TINTED ACRYLIC PANEL


TRANSPARENT TINTED ACRYLIC PANEL WITH ETCHED FINISH AND GRADUAL OPACITY DECREASE TOWARDS THE TOP OF THE PANEL. IN CUSTOM COLOURS. INTEGRATED POLYIMIDE THREADS FOR SHATTER AND BIRD STRIKE PROTECTION.

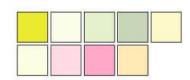



TRANSLUCENT TINTED ACRYLIC OR PERFORATED STEEL PANEL

> TRANSLUCENT TINTED ACRYLIC PANEL, INTEGRATED POLYIMIDE OR PERFORATED STAINLESS STEEL PANEL TO CUSTOM MANUFACTURED SHAPES.

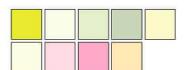

PAINT FINISHES



PAINT OVER STEEL - TYPE 01

PAINT OVER STEEL WITH PROTECTIVE COATING. SATIN FINISH WITH INTEGRAL PROPERTIES TO TOP COAT.



MESH FINISHES



WIRE MESH PROTECTION SCREEN

WIRE MESH PROTECTION SCREEN TO CUSTOM MANUFACTURED SHAPES. STAINLESS STEEL FINISH.

1:100

DESIGN SUBJECT TO RELEVANT CODES AND STANDAR

NORTH EAST LINK PROGRAM

RING ROAD COMPLETION ATTACHMENT 1: ARCHITECTURE AND URBAN DESIGN

ROAD INFRASTRUCTURE SCREEN TYPES - SHEET 01

NELP DRAWING No.

North East Link Program

UDLP FINAL SUBMISSION UDLP FINAL SUBMISSION IEA

UDLP REVISION 1 UDLP IEA REVIEW PUBLIC EXHIBITION

APPROVALS

NAME

21/08/2024 3:34:16 PM

7 CVITKOVIC

E. CASTILLO

M SPYROPOULOS

M. FERNANDO

. ANDERSON

CHECKED BY

DESIGNED BY

CHECKED BY

ERIFIED BY

APPROVED BY

21/08/24

02/08/24

29/01/24

DATE


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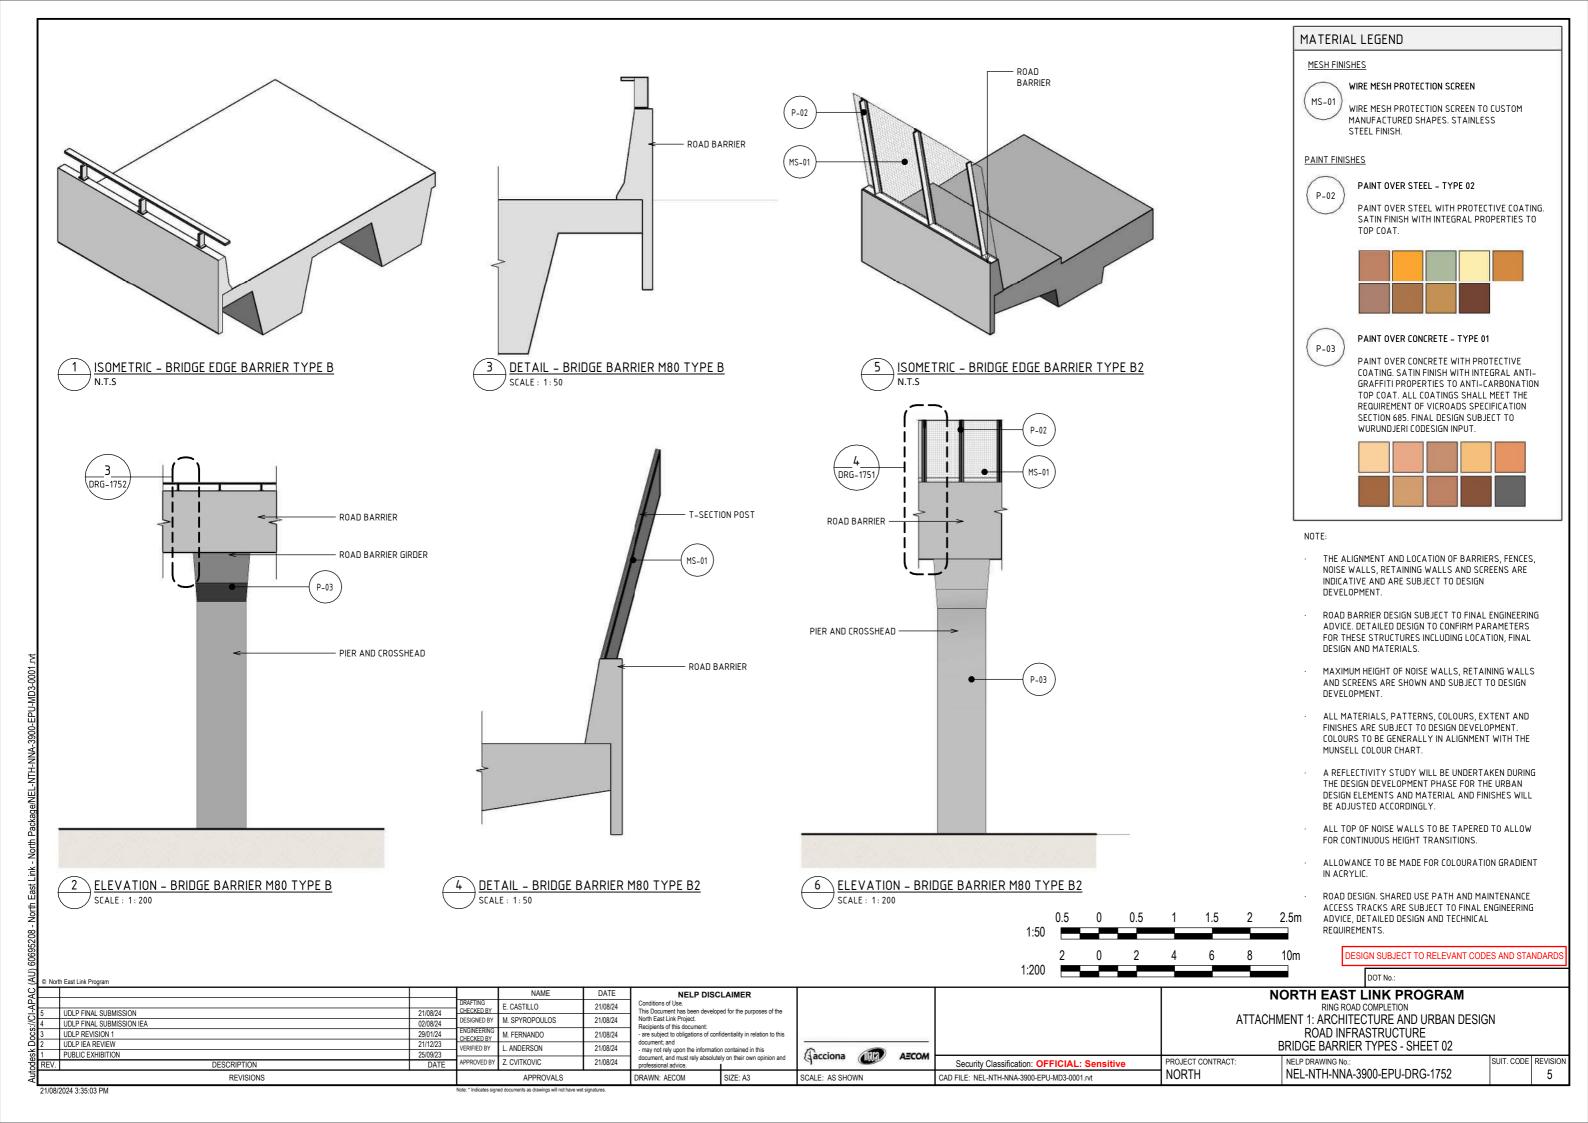
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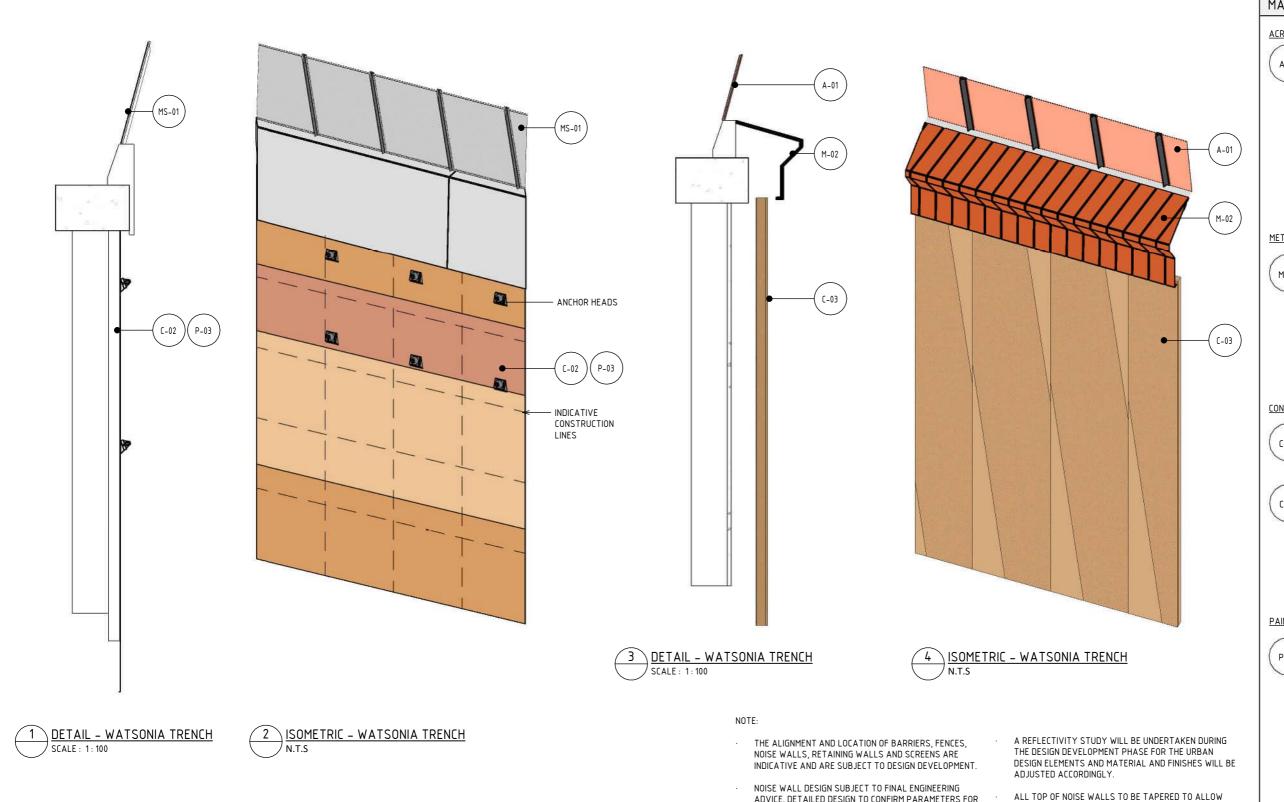
PROJECT CONTRACT NORTH

NEL-NTH-NNA-3900-EPU-DRG-1741

SUIT. CODE REVISION 5





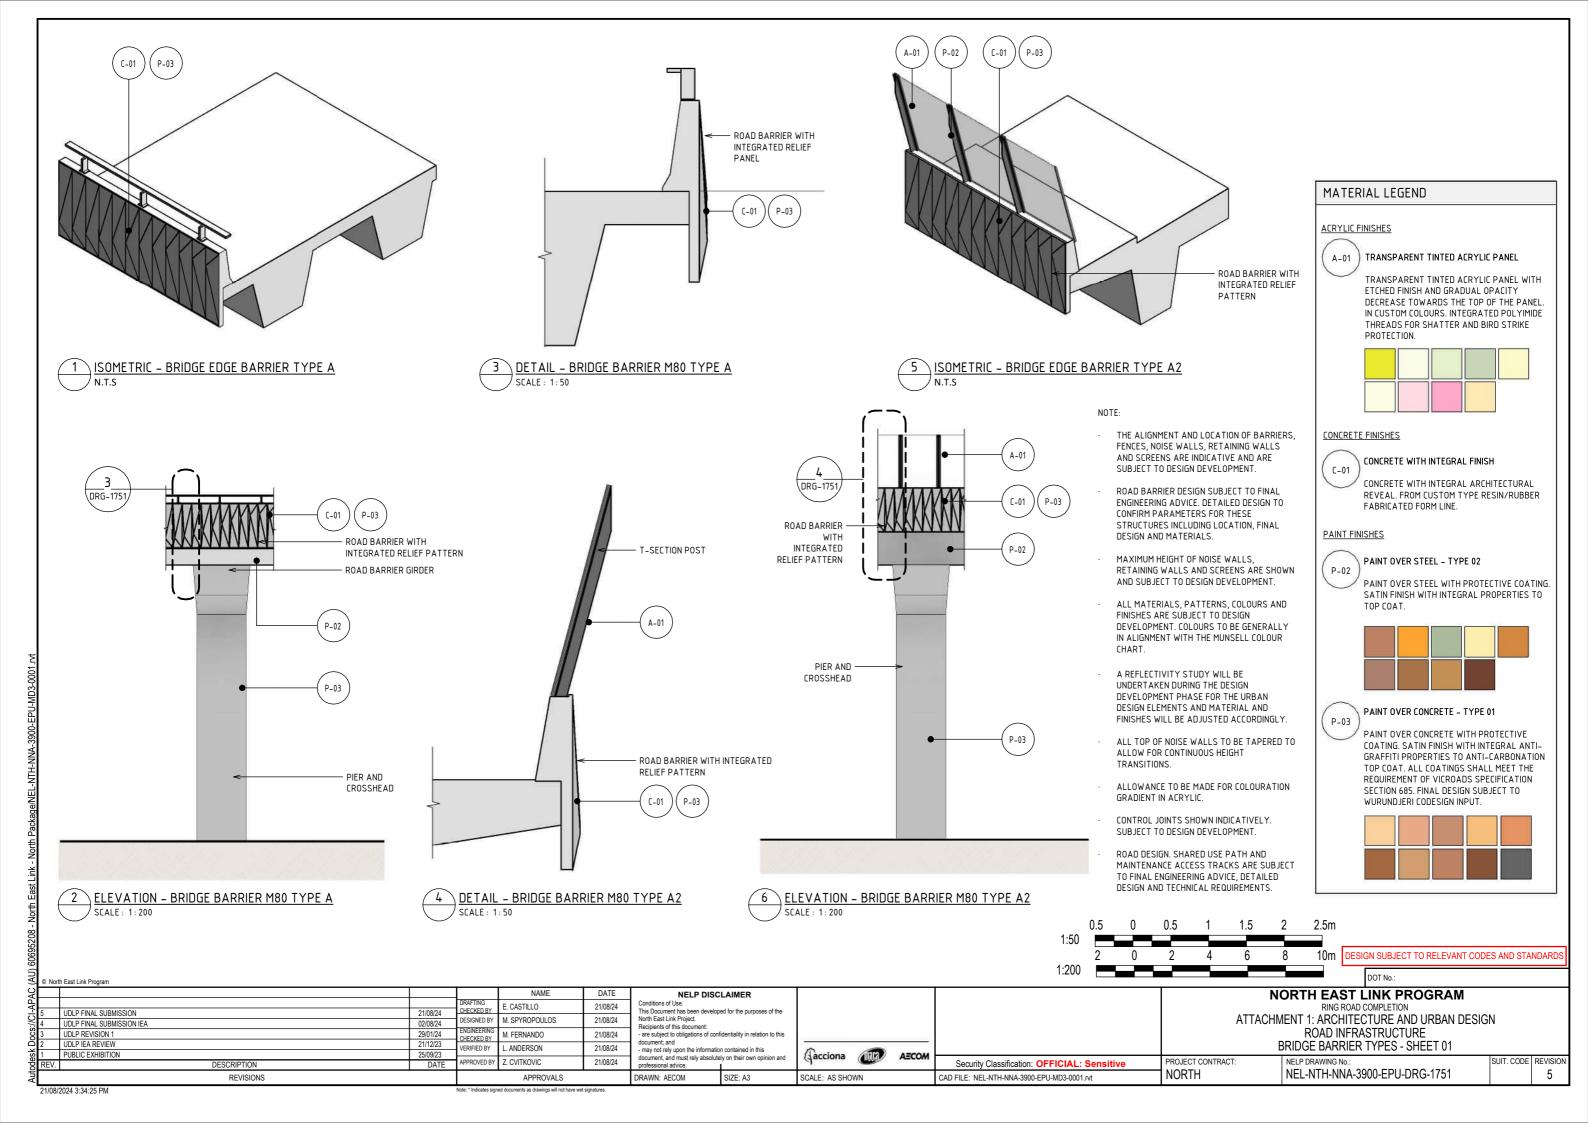

- ADVICE. DETAILED DESIGN TO CONFIRM PARAMETERS FOR THESE STRUCTURES INCLUDING LOCATION, FINAL DESIGN AND MATERIALS.
- MAXIMUM HEIGHT OF NOISE WALLS, RETAINING WALLS AND SCREENS ARE SHOWN AND SUBJECT TO DESIGN DEVELOPMENT.
- ALL MATERIALS, PATTERNS, COLOURS AND FINISHES ARE SUBJECT TO DESIGN DEVELOPMENT. COLOURS TO BE GENERALLY IN ALIGNMENT WITH THE MUNSELL COLOUR CHART.
- FOR CONTINUOUS HEIGHT TRANSITIONS.
- ALLOWANCE TO BE MADE FOR COLOURATION GRADIENT IN ACRYLIC.
- CONTROL JOINTS SHOWN INDICATIVELY. SUBJECT TO DESIGN DEVELOPMENT.

MATERIAL LEGEND

ACRYLIC FINISHES

A-01

TRANSPARENT TINTED ACRYLIC PANEL

TRANSPARENT TINTED ACRYLIC PANEL WITH ETCHED FINISH AND GRADUAL OPACITY DECREASE TOWARDS THE TOP OF THE PANEL. IN CUSTOM COLOURS. INTEGRATED POLYIMIDE THREADS FOR SHATTER AND BIRD STRIKE PROTECTION.



METAL FINISHES



SOLID ALUMINIUM PANEL

SOLID ALUMINIUM PANEL TO CUSTOM ARCHITECTURAL PROFILE WITH SATIN PVDF FINISH, IN CUSTOM COLOURS. FULL HEIGHT CLEAR NON SACRIFICIAL, NON-FILM FORMING COATING NOTE- TO MATCH TUNNELS UDLP



CONCRETE FINISHES



SHOTCRETE

OFF GUN SHOTCRETE FINISH.



PRECAST CONCRETE (TRENCH)

PRECAST CONCRETE TEXTURED PANEL WITH INTEGRAL ARCHITECTURAL REVEAL. FROM CUSTOM TYPE RESIN/RUBBER FABRICATED FORM LINE WITH OXIDE COLOUR.



PAINT FINISHES



PAINT OVER CONCRETE - TYPE 01

PAINT OVER CONCRETE WITH PROTECTIVE COATING. SATIN FINISH WITH INTEGRAL ANTI-GRAFFITI PROPERTIES TO ANTI-CARBONATION TOP COAT. ALL COATINGS SHALL MEET THE REQUIREMENT OF VICROADS SPECIFICATION SECTION 685. FINAL DESIGN SUBJECT TO WURUNDJERI CODESIGN INPUT.



MESH FINISHES



WIRE MESH PROTECTION SCREEN

WIRE MESH PROTECTION SCREEN TO CUSTOM MANUFACTURED SHAPES. STAINLESS STEEL

5m DESIGN SUBJECT TO RELEVANT CODES AND STANDAR

0 2 1:100

NORTH EAST LINK PROGRAM

RING ROAD COMPLETION ATTACHMENT 1: ARCHITECTURE AND URBAN DESIGN

ROAD INFRASTRUCTURE

BRIDGE BARRIER TYPES - SHEET 03 NELP DRAWING No.

North East Link Program

NAME DATE E. CASTILLO 21/08/24 CHECKED BY UDLP FINAL SUBMISSION 21/08/24 21/08/24 M SPYROPOULOS DESIGNED BY UDLP FINAL SUBMISSION IEA 02/08/24 M. FERNANDO 21/08/24 UDLP REVISION 1 29/01/24 CHECKED BY UDLP IEA REVIEW . ANDERSON 21/08/24 ERIFIED BY PUBLIC EXHIBITION APPROVED BY 7 CVITKOVIC 21/08/24 DESCRIPTION DATE REVISIONS APPROVALS DRAWN: AECOM

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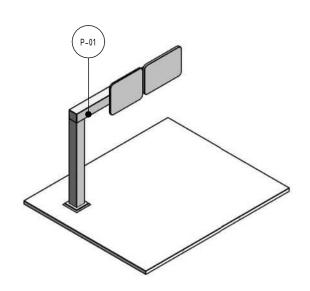
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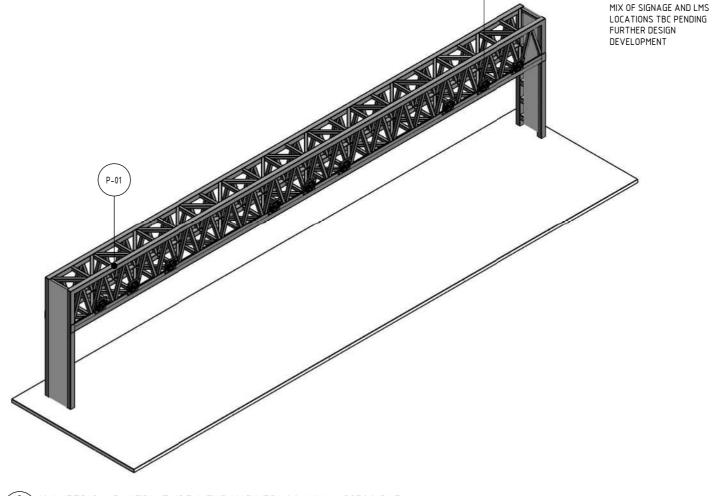
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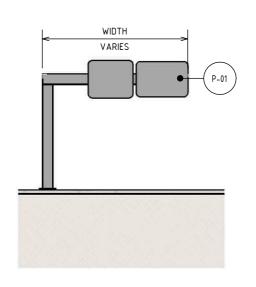
SUIT. CODE REVISION 5




ISOMETRIC - GANTRY TYPE 1 CANTILEVER



ISOMETRIC - GANTRY TYPE 2 THROUGH TRUSS NON-ACCESSIBLE



ELEVATION - GANTRY TYPE 1 CANTILEVER SCALE: 1: 250

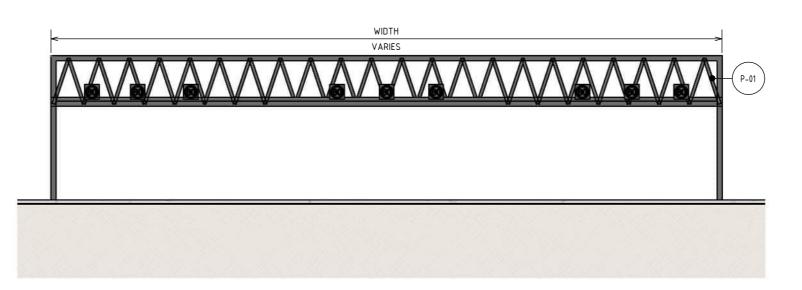

ELEVATION - GANTRY TYPE 2 THROUGH TRUSS NON-ACCESSIBLE SCALE: 1: 250

MATERIAL LEGEND

PAINT FINISHES

P-01

TYPE TWO TO CONTAIN A

PAINT OVER STEEL - TYPE 01

PAINT OVER STEEL WITH PROTECTIVE COATING. SATIN FINISH WITH INTEGRAL PROPERTIES TO TOP COAT.



NOTE:

- THE ALIGNMENT AND LOCATION OF BARRIERS, FENCES, NOISE WALLS, RETAINING WALLS AND SCREENS ARE INDICATIVE AND ARE SUBJECT TO DESIGN DEVELOPMENT.
- GANTRY DESIGN SUBJECT TO FINAL ENGINEERING ADVICE. DETAILED DESIGN TO CONFIRM PARAMETERS FOR THESE STRUCTURES INCLUDING LOCATION, FINAL DESIGN AND MATERIALS.
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- A REFLECTIVITY STUDY WILL BE UNDERTAKEN DURING THE DESIGN DEVELOPMENT PHASE FOR THE URBAN DESIGN ELEMENTS AND MATERIAL AND FINISHES WILL BE ADJUSTED ACCORDINGLY.
- ALLOWANCE TO BE MADE FOR COLOURATION GRADIENT IN ACRYLIC.

5


ROAD DESIGN. SHARED USE PATH AND MAINTENANCE ACCESS TRACKS ARE SUBJECT TO FINAL ENGINEERING ADVICE, DETAILED DESIGN AND TECHNICAL REQUIREMENTS.


7.5 12.5m DESIGN SUBJECT TO RELEVANT CODES AND STANDAR

DATE NAME


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ELEVATION - GANTRY TYPE 3 STEEL PORTAL NON-ACCESSIBLE SCALE: 1: 250

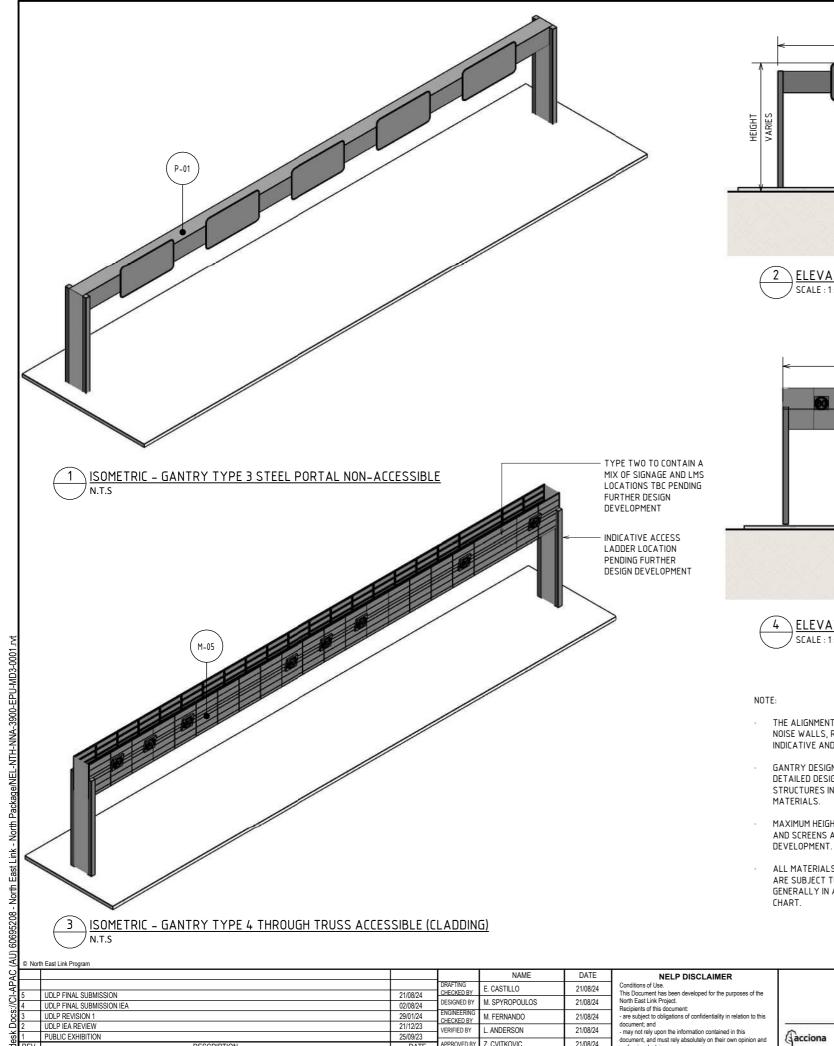

4 ELEVATION – GANTRY TYPE 4 THROUGH TRUSS ACCESSIBLE (CLADDING) SCALE: 1: 250

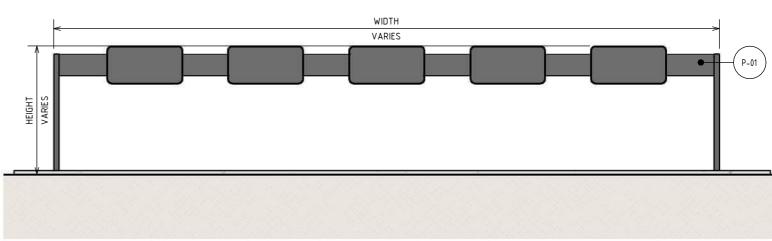Security Classification: OFFICIAL: Sensitive

CAD FILE: NEL-NTH-NNA-3900-EPU-MD3-0001.rvt

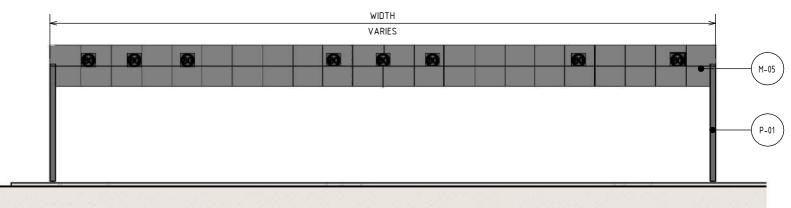- THE ALIGNMENT AND LOCATION OF BARRIERS, FENCES, NOISE WALLS, RETAINING WALLS AND SCREENS ARE INDICATIVE AND ARE SUBJECT TO DESIGN DEVELOPMENT
- GANTRY DESIGN SUBJECT TO FINAL ENGINEERING ADVICE. DETAILED DESIGN TO CONFIRM PARAMETERS FOR THESE STRUCTURES INCLUDING LOCATION, FINAL DESIGN AND
- MAXIMUM HEIGHT OF NOISE WALLS, RETAINING WALLS AND SCREENS ARE SHOWN AND SUBJECT TO DESIGN
- ALL MATERIALS, PATTERNS, COLOURS AND FINISHES ARE SUBJECT TO DESIGN DEVELOPMENT. COLOURS TO BE GENERALLY IN ALIGNMENT WITH THE MUNSELL COLOUR
- A REFLECTIVITY STUDY WILL BE UNDERTAKEN DURING THE DESIGN DEVELOPMENT PHASE FOR THE URBAN DESIGN ELEMENTS AND MATERIAL AND FINISHES WILL BE ADJUSTED ACCORDINGLY.
- ALLOWANCE TO BE MADE FOR COLOURATION GRADIENT IN ACRYLIC.

NORTH

ROAD DESIGN. SHARED USE PATH AND MAINTENANCE ACCESS TRACKS ARE SUBJECT TO FINAL ENGINEERING ADVICE, DETAILED DESIGN AND TECHNICAL REQUIREMENTS.

MATERIAL LEGEND

METAL FINISHES

M-05

PERFORATED ALUMINIUM PANELS

PERFORATED ALUMINIUM PANEL TO CUSTOM ARCHITECTURAL PROFILE WITH SATIN PVDF FINISH, IN CUSTOM COLOURS. FULL HEIGHT CLEAR NON SACRIFICIAL, NON-FILM FORMING COATING.

PAINT FINISHES

P-01

PAINT OVER STEEL - TYPE 01

PAINT OVER STEEL WITH PROTECTIVE COATING. SATIN FINISH WITH INTEGRAL PROPERTIES TO TOP COAT.

5



5 7.5 10 12.5m DESIGN SUBJECT TO RELEVANT CODES AND STANDAR

NORTH EAST LINK PROGRAM

RING ROAD COMPLETION ATTACHMENT 1: ARCHITECTURE AND URBAN DESIGN ROAD INFRASTRUCTURE **GANTRY TYPES - SHEET 02** PROJECT CONTRACT SUIT. CODE REVISION

APPROVALS

DRAWN: AECOM

SIZE: A3

SCALE: AS SHOWN

DATE


NELP DRAWING No.

NEL-NTH-NNA-3900-EPU-DRG-1762


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DESCRIPTION







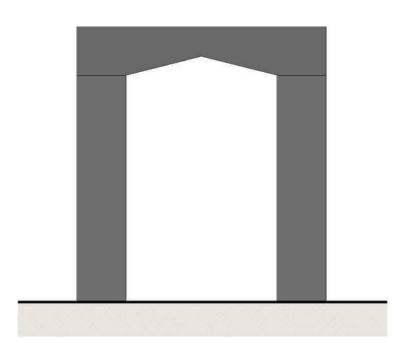

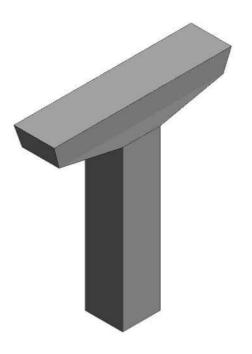

\ISOMETRIC - PIER TYPE A

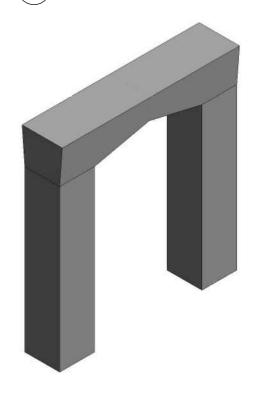

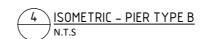

- THE ALIGNMENT AND LOCATION OF BARRIERS, FENCES, NOISE WALLS, RETAINING WALLS AND SCREENS ARE INDICATIVE AND ARE SUBJECT TO DESIGN DEVELOPMENT.
- PIER DESIGN SUBJECT TO FINAL ENGINEERING ADVICE. DETAILED DESIGN TO CONFIRM PARAMETERS FOR THESE STRUCTURES INCLUDING LOCATION, FINAL DESIGN AND MATERIALS.
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- ALLOWANCE TO BE MADE FOR COLOURATION GRADIENT IN ACRYLIC.
- ROAD DESIGN. SHARED USE PATH AND MAINTENANCE ACCESS TRACKS ARE SUBJECT TO FINAL ENGINEERING ADVICE, DETAILED DESIGN AND TECHNICAL REQUIREMENTS.

1:200

10m DESIGN SUBJECT TO RELEVANT CODES AND STANDARD

North	East	Link	Progran	1

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3	5 //	UDLP FINAL SUBMISSION UDLP FINAL SUBMISSION IFA	21/08/24 02/08/24		M. SPYROPOULOS	21/08/24
ŝ	3	UDLP REVISION 1		ENGINEERING CHECKED BY	M. FERNANDO	21/08/24
ػؚ	2	UDLP IEA REVIEW	21/12/23	VERIFIED BY	L. ANDERSON	21/08/24
20	1	PUBLIC EXHIBITION	25/09/23	ADDDOVED BY	Z. CVITKOVIC	21/08/24
₹	REV.	DESCRIPTION	DATE	APPROVED BY	Z. CVITKOVIC	21/00/24

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(acciona (III) A≡COM SCALE: AS SHOWN

PROJECT CONTRACT: Security Classification: OFFICIAL: Sensitive NORTH

CAD FILE: NEL-NTH-NNA-3900-EPU-MD3-0001.rvt

NORTH EAST LINK PROGRAM


RING ROAD COMPLETION ATTACHMENT 1: ARCHITECTURE AND URBAN DESIGN ROAD INFRASTRUCTURE

PIER TYPES - SHEET 01 NELP DRAWING No.:


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SUIT. CODE REVISION 5


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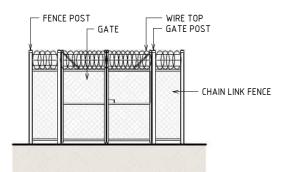
DETAIL - RAIL LINE SIDE FENCING - WELDED MESH FENCE WITH SHARK TOOTH

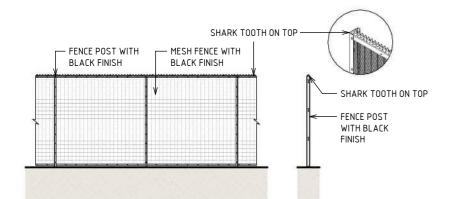


<u>DETAIL - RAIL LINE SIDE FENCING - WELDED MESH FENCE</u> SCALE: 1:100

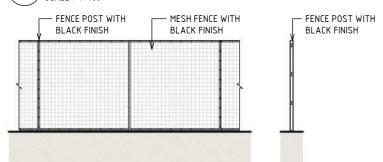


DETAIL - RAIL TUNNEL SERVICES FENCING - HIGH SECURITY VEHICLE ACCESS FENCING GATE SCALE: 1:100

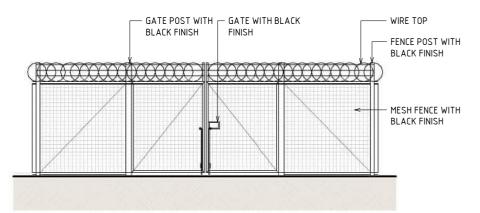


DETAIL – RAIL LUBRICATOR – EXISTING CHAIN LINK FENCE AND ACCESS GATE

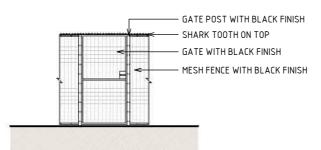


DETAIL - RAIL LINE SIDE FENCING - WELDED MESH ACCESS GATE WITH SHARK TOOTH SCALE: 1:100

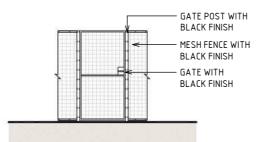

DETAIL - RAIL LINE SIDE FENCING - WELDED MESH ACCESS GATE SCALE: 1:100

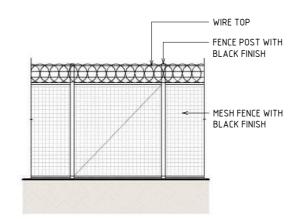

6 DETAIL - RAIL TUNNEL SERVICES FENCING - HIGH SECURITY ACCESS FENCING SCALE: 1:100

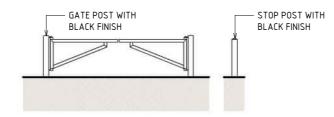

8 \ DETAIL - RAIL CORRIDOR - SWING BOOM GATE AND SWING STOP POST SCALE: 1:100

REQUIREMENTS. 0 2 3 DESIGN SUBJECT TO RELEVANT CODES AND STANDAR

PROJECT CONTRACT

NORTH

1:100

Security Classification: OFFICIAL: Sensitive

CAD FILE: NEL-NTH-NNA-3900-EPU-MD3-0001.rvt

ALLOWANCE TO BE MADE FOR COLOURATION GRADIENT IN

ROAD DESIGN, SHARED USE PATH AND MAINTENANCE ACCESS TRACKS ARE SUBJECT TO FINAL ENGINEERING ADVICE, DETAILED DESIGN AND TECHNICAL

THE ALIGNMENT AND LOCATION OF BARRIERS, FENCES,

MAXIMUM HEIGHT OF NOISE WALLS, RETAINING WALLS

AND SCREENS ARE SHOWN AND SUBJECT TO DESIGN

ALL MATERIALS, PATTERNS, COLOURS, EXTENT AND FINISHES ARE SUBJECT TO DESIGN DEVELOPMENT.

COLOURS TO BE GENERALLY IN ALIGNMENT WITH THE

A REFLECTIVITY STUDY WILL BE UNDERTAKEN DURING THE DESIGN DEVELOPMENT PHASE FOR THE URBAN DESIGN ELEMENTS AND MATERIAL AND FINISHES WILL BE

NOISE WALLS, RETAINING WALLS AND SCREENS ARE INDICATIVE AND ARE SUBJECT TO DESIGN DEVELOPMENT. FENCE DESIGN SUBJECT TO FINAL ENGINEERING ADVICE. DETAILED DESIGN TO CONFIRM PARAMETERS FOR THESE STRUCTURES INCLUDING LOCATION, FINAL DESIGN AND

NORTH EAST LINK PROGRAM

NOTE:

MATERIALS.

DEVELOPMENT.

MUNSELL COLOUR CHART.

ADJUSTED ACCORDINGLY.

RING ROAD COMPLETION ATTACHMENT 1: ARCHITECTURE AND URBAN DESIGN

ROAD INFRASTRUCTURE FENCE TYPES - SHEET 01

SUIT. CODE REVISION

5

SCALE: 1:100

North East Link Program DATE NAME E. CASTILLO 21/08/24 CHECKED BY UDLP FINAL SUBMISSION 21/08/24 M SPYROPOULOS 21/08/24 DESIGNED BY UDLP FINAL SUBMISSION IEA 02/08/24 M. FERNANDO 21/08/24 UDLP REVISION 1 29/01/24 CHECKED BY UDLP IEA REVIEW . ANDERSON 21/08/24 ERIFIED BY PUBLIC EXHIBITION APPROVED BY 7 CVITKOVIC 21/08/24 DESCRIPTION DATE REVISIONS APPROVALS

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NELP DRAWING No. NEL-NTH-NNA-3900-EPU-DRG-1781

MATERIAL PRECEDENTS



OFF-GUN SHOTCRETE FINISH

Source - https://www.curtisconcretepumping.com/projects/structural-shotcrete-basement-



CLIMBING PLANT FRAMES SOFTEN THE VISUAL IMPACT OF NOISE WALLS IN CONFINED SPACES. TULLAMARINE FREEWAY, MOONEE PONDS, VICTORIA

Source-https://www.vicroads.vic.gov.au/-/media/files/technical-documents-new/bridge-technicnotes/bridge-technical-note-2023_007--noise-attenuation-walls--v20--may-2023.ashx



PAINT TREATMENT WESTERN HIGHWAY (REMEMBRANCE DRIVE - BALLARAT) VICTORIA

Source - https://monumentaustralia.org.au/themes/conflict/ww1/display/111209-ballarat-avenue-of-honour-



LANDSCAPE IN FRONT OF NOISE WALLS MORDIALLOC FREEWAY, ROCK BEACHING TO REFERENCE GEOLOGY OF THE AREA BRAESIDE, VICTORIA

 $Source - \ https://www.vicroads.vic.gov.au/-/media/files/technical-documents-new/bridge-tec$



TIED-ARCH BRIDGE WITH INCLINED HANGERS

Source - https://structurae.net/en/structures/n-vi-footbridge



Source - Google Street View



ANCHOR HEAD TREATMENT

Source - https://www.dreamstime.com/used-to-ensure-stability-sheet-pile-structures-to-ensure-stability-slopes-rock-walls-notches-to-anch-image235255162



DEMONSTRATES LIGHTING THE VERTICAL ELEMENTS OF THE UNDERPASS TO IMPROVE VISUAL COMFORT, WHILST MAINTAINING COMPLIANT AND LIGHTING LEVELS.

Source -

https://www.warrenlangley.com.au/project/immerse/

- THE ALIGNMENT AND LOCATION OF BARRIERS, FENCES, SCREENS AND WALLS ARE INDICATIVE AND ARE SUBJECT TO DESIGN DEVELOPMENT.
- A REFLECTIVITY STUDY WILL BE UNDERTAKEN DURING THE DESIGN DEVELOPMENT PHASE FOR THE URBAN DESIGN ELEMENTS AND MATERIAL AND FINISHES WILL BE ADJUSTED ACCORDINGLY.
- ROAD DESIGN. SHARED USE PATH AND MAINTENANCE ACCESS TRACKS ARE SUBJECT TO FINAL ENGINEERING ADVICE, DETAILED DESIGN AND TECHNICAL REQUIREMENTS.
- BRIDGE DESIGN IS SUBJECT TO FINAL ENGINEERING ADVICE, DETAILED DESIGN AND TECHNICAL REQUIREMENTS.
- ALL MATERIALS, PATTERNS, COLOURS, EXTENTS AND FINISHES ARE SUBJECT TO DESIGN DEVELOPMENT. COLOURS TO BE GENERALLY IN ALIGNMENT WITH THE MUNSELL COLOUR CHART.

DESIGN SUBJECT TO RELEVANT CODES AND STANDAR

NORTH EAST LINK PROGRAM

RING ROAD COMPLETION ATTACHMENT 1: ARCHITECTURE AND URBAN DESIGN ROAD INFRASTRUCTURE MATERIAL PRECEDENTS

PROJECT CONTRACT NELP DRAWING No. NORTH

notes/bridge-technical-note-2023_007--noise-attenuation-walls--v20--may-2023.ashx

DATE E. CASTILLO 21/08/24 UDLP FINAL SUBMISSION 21/08/24 21/08/24 M SPYROPOULOS DESIGNED BY UDLP FINAL SUBMISSION IEA 02/08/24 M. FERNANDO 21/08/24 UDLP REVISION 1 29/01/24 CHECKED BY UDLP IEA REVIEW . ANDERSON 21/08/24 ERIFIED BY PUBLIC EXHIBITION APPROVED BY 7 CVITKOVIC 21/08/24 DESCRIPTION REVISIONS APPROVALS

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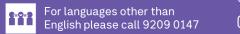
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1800 105 105 (call anytime) community@northeastlink.vic.gov.au









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